BIG BEND & OAK COMMONS MO2316 12878545

ENGINEERING

2009 INTERNATIONAL BUILDING CODE OR ADOPTED COD9 2008 NATIONAL ELECTRIC CODE OR ADOPTED CODE TIA-222-G OR ADOPTED CODE

PROJECT DESCRIPTION

THE PROJECT CONSISTS OF THE INSTALLATION AND OPERATION OF ANTENNAS AND ASSOCIATED EQUIPMENT CABINETS FOR AT&T'S WIRELESS TELECOMMUNICATIONS NETWORK.

SITE INFORMATION

PROPERTY OWNER: CITY OF BALLWIN 14811 MANCHESTER ROAD BALLWIN, MO 63011

TOWER OWNER:

SITE CONTACT:

TOM AIKEN (636) 227-2243

COUNTY: LATITUDE (NAD 83):

38' 34' 14.554" N

LONGITUDE (NAD 83):

90° 33′ 16.564″ W -90.554601

ZONING JURISDICTION:

ZONING DISTRICT:

PARCEL #:

CITY OF BALLWIN

PA - PUBLIC ACTIVITY

24S241186

V-B

AT&T

AMEREN UE

OCCUPANCY GROUP:

CONSTRUCTION TYPE:

POWER COMPANY:

TELEPHONE COMPANY:

CONSTRUCTION MANAGER: TBD

SITE ACQUISITION MANAGER: CHRISTINA KNAPEK


RF ENGINEER:

SANDY SZYHOWSKI

(952) 896-0740

at&t

NSB **125' - MONOPINE**

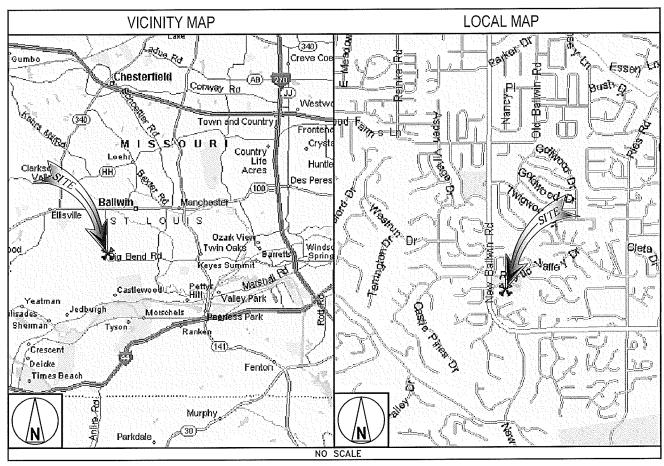

CONTACT INFORMATION

ENGINEER

BLACK & VEATCH CORPORATION 10950 GRANDVIEW DRIVE OVERLAND PARK, KS 66210

CONTACT: PHONE:

GREGORY SCHMIDT (913) 458-3263

DRIVING DIRECTIONS

DIRECTIONS FROM NEAREST MAJOR INTERSECTION:

FROM I-270 EXIT WEST ONTO MO-100/MANCHESTER RD. FOLLOW TO NEW BALLWIN RD AND TURN SOUTH. SITE ACCESS IS ON EAST SIDE OF ROAD THROUGH PARK ENTRANCE.

GENERAL NOTES

THE FACILITY IS UNMANNED AND NOT FOR HUMAN HABITATION. A TECHNICIAN WILL VISIT THE SITE AS REQUIRED FOR ROUTINE MAINTENANCE, THE PROJECT WILL NOT RESULT IN ANY SIGNIFICANT DISTURBANCE OR EFFECT ON DRAINAGE; NO SANITARY SEWER SERVICE, POTABLE WATER, OR TRASH DISPOSAL IS REQUIRED AND NO COMMERCIAL SIGNAGE IS

DRAWING INDEX			
SHEET NO:	SHEET TITLE		
T-1	TITLE SHEET		
LS-1	LAND SURVEY (BY OTHERS)		
C-1	OVERALL SITE PLAN (EXISTING PARK CONDITIONS)		
C-1.1	ENLARGED SITE PLAN (EXISTING PARK CONDITIONS)		
C-1.2	OVERALL SITE PLAN (FUTURE PARK CONDITIONS)		
C-1.3	ENLARGED SITE PLAN (FUTURE PARK CONDITIONS)		
C-1.4	SITE PLAN		
C-2	ELEVATIONS		
C-3	CMU WALL ELEVATIONS		
L1	LANDSCAPING PLAN		
	authority 1970 -		

11"x17" PLOT WILL BE HALF SCALE UNLESS OTHERWISE NOTED

CONTRACTOR SHALL VERIFY ALL PLANS & EXISTING DIMENSIONS & CONDITIONS ON THE JOB SITE & SHALL IMMEDIATELY NOTIFY THE ENGINEER IN WRITING OF ANY DISCREPANCIES BEFORE PROCEEDING WITH THE WORK OR BE RESPONSIBLE FOR SAME



UNDERGROUND SERVICE ALERT UTILITIES PROTECTION CENTER, INC.

> 811 48 HOURS BEFORE YOU DIG



OVERLAND PARK, KS 66204



10950 GRANDVIEW DRIVE OVERLAND PARK, KANSAS 66210 (913) 458-2000

PROJECT NO:	122041
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IT IS A VIOLATION OF LAW FOR ANY PERSON, UNLESS THEY ARE ACTING UNDER THE DIRECTION OF A LICENSED PROFESSIONAL ENGINEER, TO ALTER THIS DOCUMENT.

BIG BEND & OAK COMMONS M02316 500 NEW BALLWIN ROAD BALLWIN, MO 63011 NSB

TITLE SHEET

T-1

MO2316 / BIG BEND & OAK COMMONS IN ST. LOUIS COUNTY, MISSOURI

BENCH MARK Top of 1/2" Iron Bar w/ Cap at CP-1 Elevation = 632.58ft

Coordinates were derived using GPS Static Survey methods and post processed data with Magellan/Ashtech receivers and "Locus System" processor software.

The purpose of this survey is to establish and describe a Lease Parcel and associated easements. This is not a boundary survey of the Parent Parcel.

The utilities as shown on this drawing were developed from the information

The utilities as shown on this drawing were developed from the information available (existing utility maps, oboveground observations and or surface markings placed on the ground by the utility company or a representative thereof). This company has made no attempt to excavate or go below surface to locate utilities and does not extend or imply a guaranty or warranty as to the exact location of or complete inventory of utilities in this area. It shall be the contractors responsibility to verify the location and depth of all utilities (whether shown or not) prior to excavation or construction and to protect said utilities from damage.

Set 1/2" iron bar at Lease corners unless otherwise noted.

PROPOSED CELL TOWER DATA Center of Tower Lat 38'34'14.554" North Long 90'33'16.564" West Ground Elevation = 628ft

LEGEND Ø PP POWER POLE □ Tel. Ped. TELEPHONE PEDESTAL ELECTRIC METER ∘ EM SEWER VALVE e SV WATER FOUNTAIN ot ₩F BENCHWARK Α COUTROL POINT CATE POST . CP GUARD POST · GRD CLEANOUT ·co PROPERTY CORNER \triangle TOWER POINT 常 TREE (DIA.) TREE LINE FENCE OVERHEAD POWER LINE NDERGROUND ELECTRIC LINE





CERTIFICATION:

JEFFREY B. LOVELACE MO-LS2580

DATE: _____

I HEREBY CERTIFY THAT A SURVEY WAS MADE BY ME, OR UNDER MY DIRECT SUPERVISION, ON THE GROUND OF THE LEASE AREA, LEASE ACCESS EASEMENT, AND LEASE UTILITY EASEMENT PREMISES HEREIN DESCRIBED, AND THE RESULTS OF SAID SURVEY ARE REPRESENTED HEREON. THIS SURVEY WAS EXCUTED IN ACCORDANCE WITH THE CURRENT MINIMUM STANDARDS FOR PROPERTY BOUNDARY SURVEYS OVER SAID LEASE PREMISES TO THE BEST OF MY PROFESSIONAL KNOWLEDGE AND BELLEY.

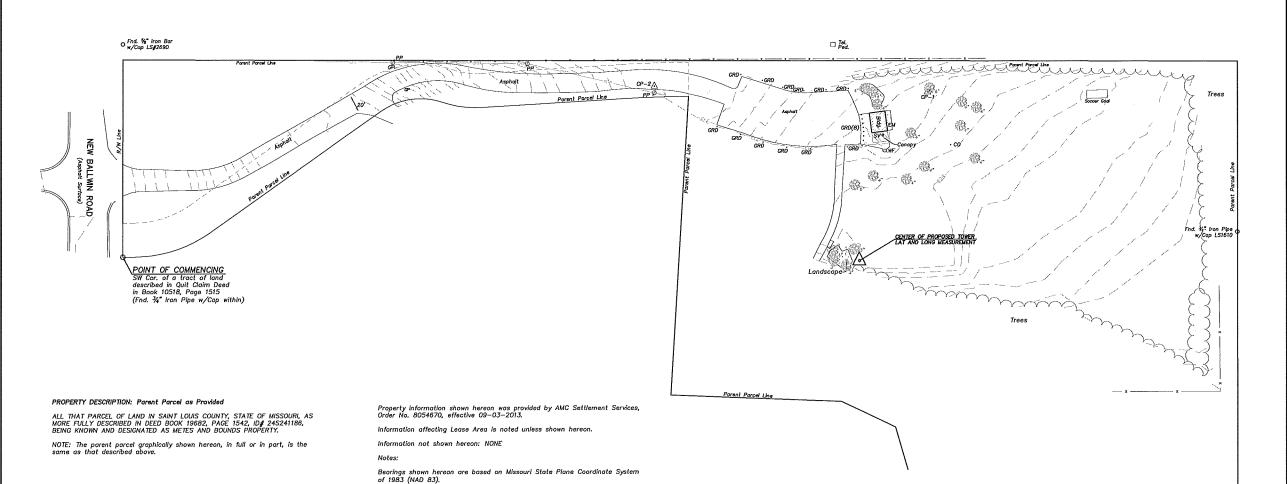

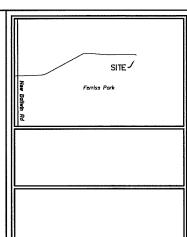

OVELACE & ASSOCIATES Land Surveying - Land Planning Telecommunications Surveys 29 SE 3rd Street Lee's Summit, Misson Phone: (816) 347-9997 Fax: (816) 347-9979

SURVEY COORDINATED BY:


LOVELACE AND ASSOCIATES, LLC P.O. BOX 68, LEE'S SUMMIT, MO 64063 TELEPHONE: 816–347–9997 FAX: 816–347–9979

SURVEY PROVIDED BY:

LOVELACE AND ASSOCIATES, LLC P.O. BOX 68, LEE'S SUMMIT, MO 64063 TELEPPHONE: 816-347-9997 FAX: 816-347-9979

SURVEY PROVIDED FOR:

BLACK & VEATCH CORPORATION 10950 GRANDVIEW DRIVE, OVERLAND PARK, KS 66210 TELEPHONE: 913-458-3263

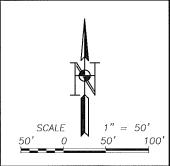

According to my Interpretations of Community Panel No. 29189CO258 H of the Flood Insurance Rate Map for St. Louis County, Missouri, dated August 2, 1995, the subject property is in Flood Zone "X". ie. "areas determined to be Outside 500 year flood



CALL BEFORE YOU DIG - DRILL - BLAST 1-800-344-7493 (TOLL FREE)

MISSOURI DNE CALL SYSTEM, INC.

SITE I.D.: MO2316

Fnd. ¾" Iron Pipa w/Cap LS19D

Fnd. ¾" Iron Pipe w/Cap LS190

SITE NAME: BIG BEND & OAK COMMONS

SITE LOCATION: BALLWIN, ST. LOUIS COUNTY, MO

LA PROJECT NO.: 13451


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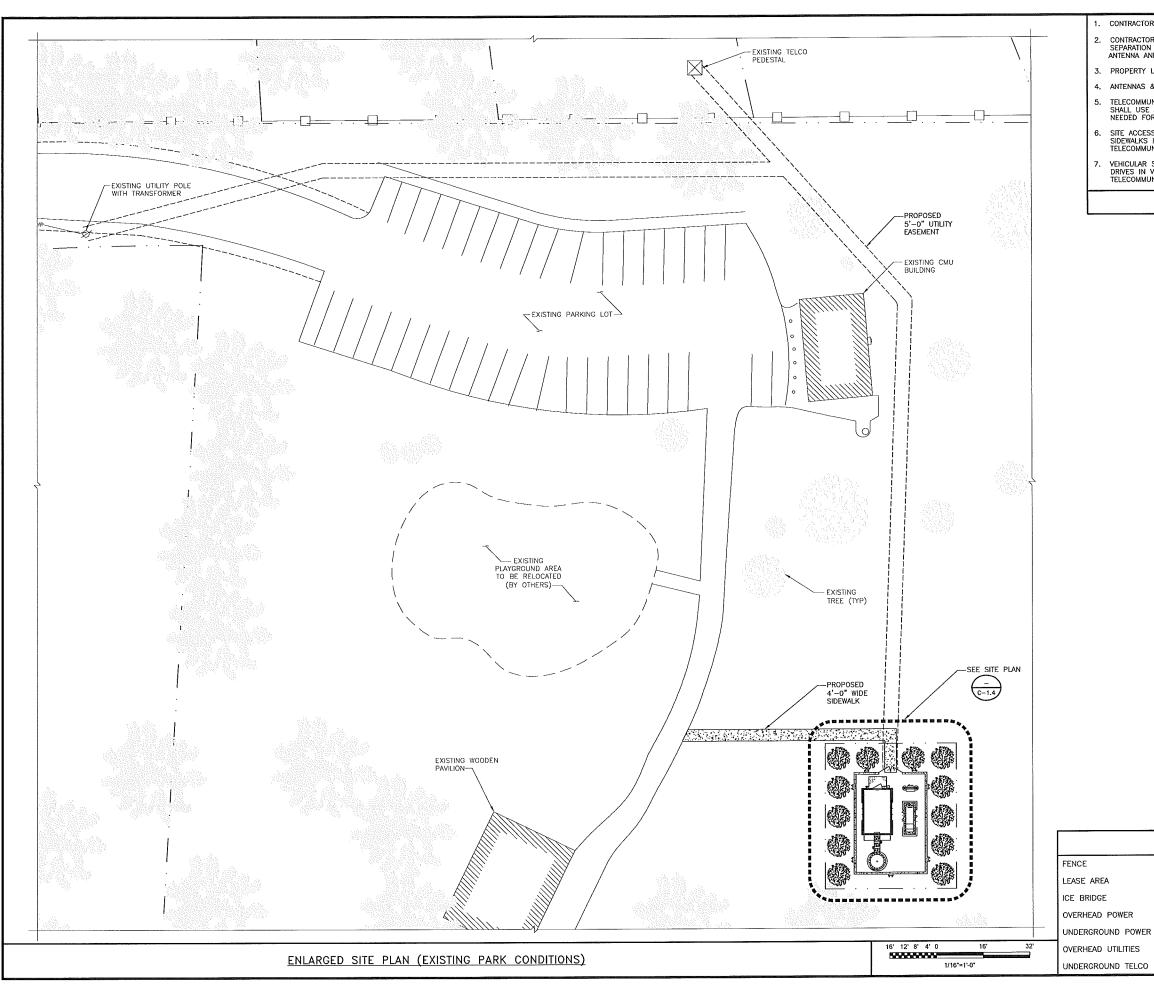
CHECKED BY: J.B.L.

DATE: 10-24-13

FIELDWORK DATE: 10-22-13

SHEET NUMBER 1 OF 1



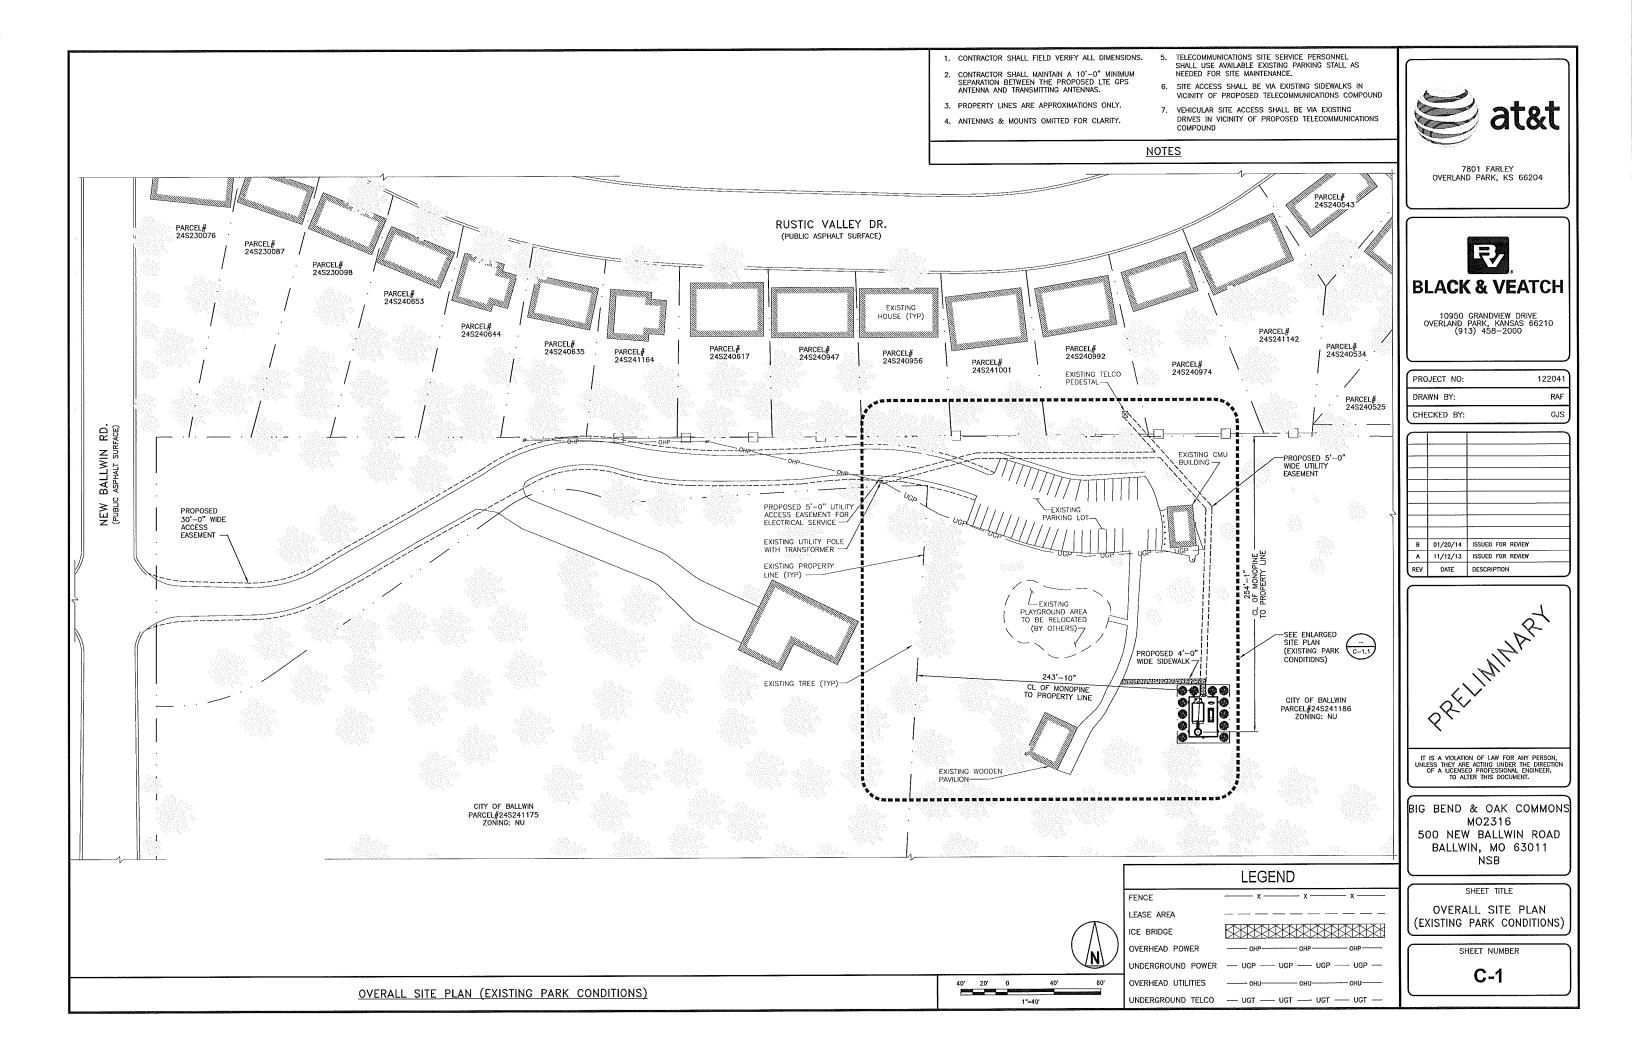

- 1. CONTRACTOR SHALL FIELD VERIFY ALL DIMENSIONS.
- CONTRACTOR SHALL MAINTAIN A 10'-0" MINIMUM SEPARATION BETWEEN THE PROPOSED LTE GPS ANTENNA AND TRANSMITTING ANTENNAS.
- 3. PROPERTY LINES ARE APPROXIMATIONS ONLY.
- 4. ANTENNAS & MOUNTS OMITTED FOR CLARITY.
- 5. TELECOMMUNICATIONS SITE SERVICE PERSONNEL SHALL USE AVAILABLE EXISTING PARKING STALL AS NEEDED FOR SITE MAINTENANCE.
- 6. SITE ACCESS SHALL BE VIA EXISTING/PROPOSED SIDEWALKS IN VICINITY OF PROPOSED TELECOMMUNICATIONS COMPOUND
- 7. VEHICULAR SITE ACCESS SHALL BE VIA EXISTING DRIVES IN VICINITY OF PROPOSED TELECOMMUNICATIONS COMPOUND

<u>NOTES</u>

LEGEND

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7801 FARLEY OVERLAND PARK, KS 66204



10950 GRANDVIEW DRIVE OVERLAND PARK, KANSAS 66210 (913) 458–2000

122041

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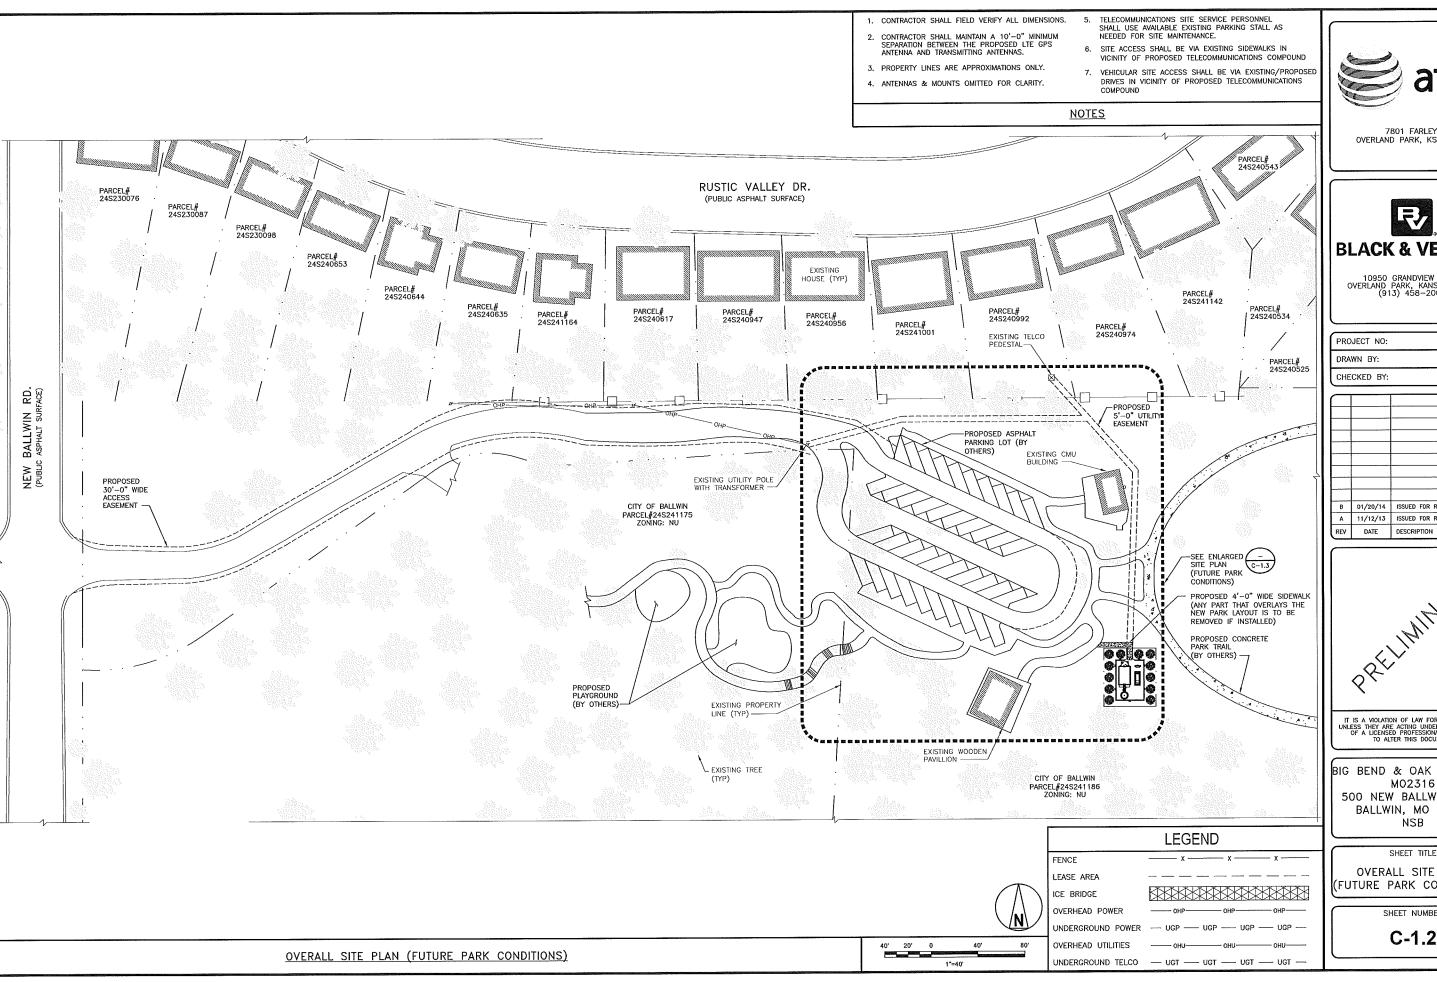
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BIG BEND & OAK COMMONS MO2316 500 NEW BALLWIN ROAD BALLWIN, MO 63011 NSB

SHEET TITLE

ENLARGED SITE PLAN (EXISITNG PARK CONDITIONS)

SHEET NUMBER





7801 FARLEY OVERLAND PARK, KS 66204



10950 GRANDVIEW DRIVE OVERLAND PARK, KANSAS 66210 (913) 458-2000

122041

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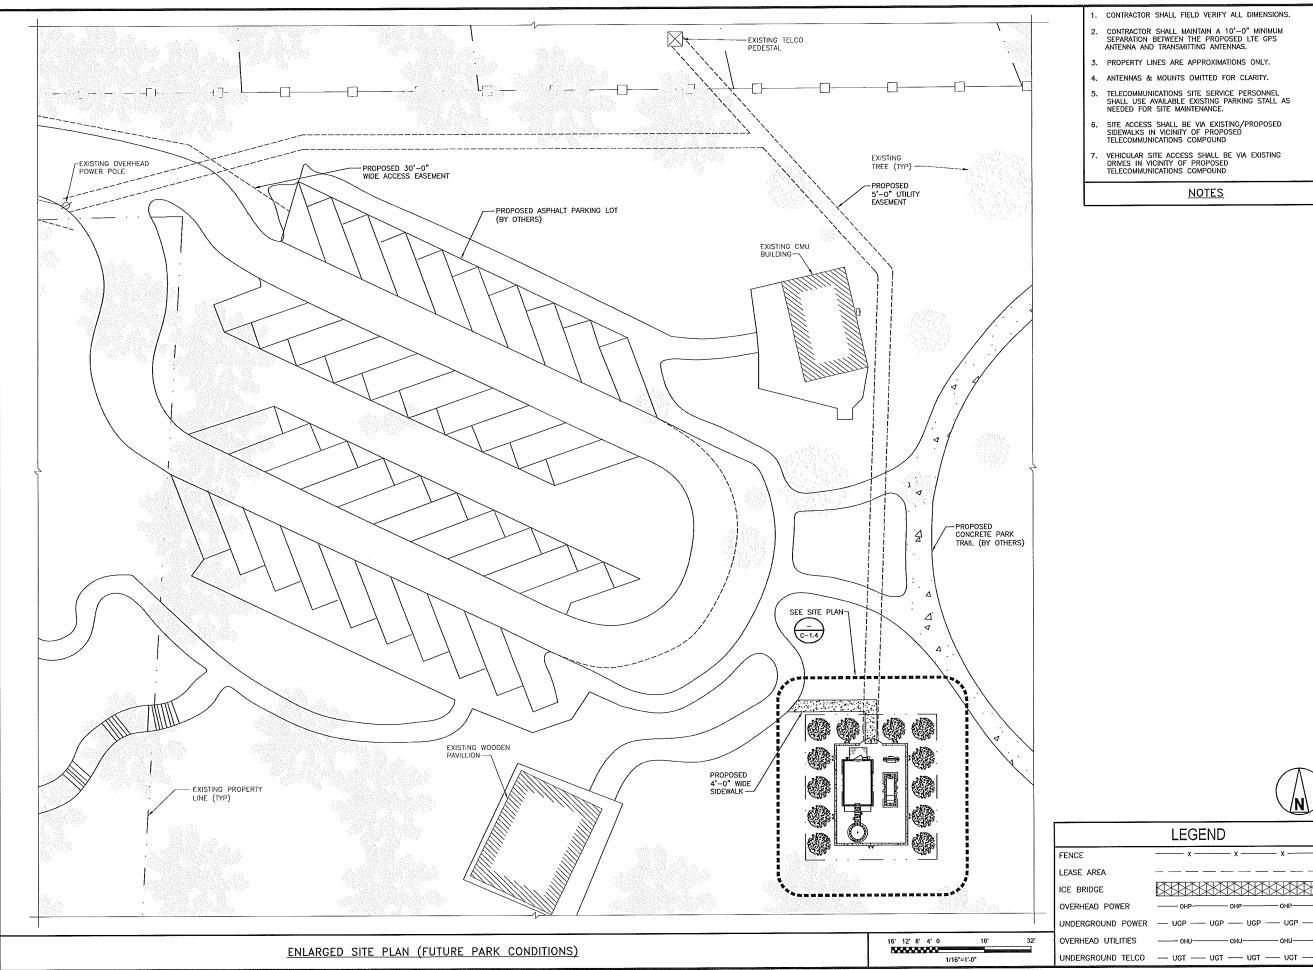
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SHEET TITLE

OVERALL SITE PLAN (FUTURE PARK CONDITIONS)

SHEET NUMBER



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<u>NOTES</u>

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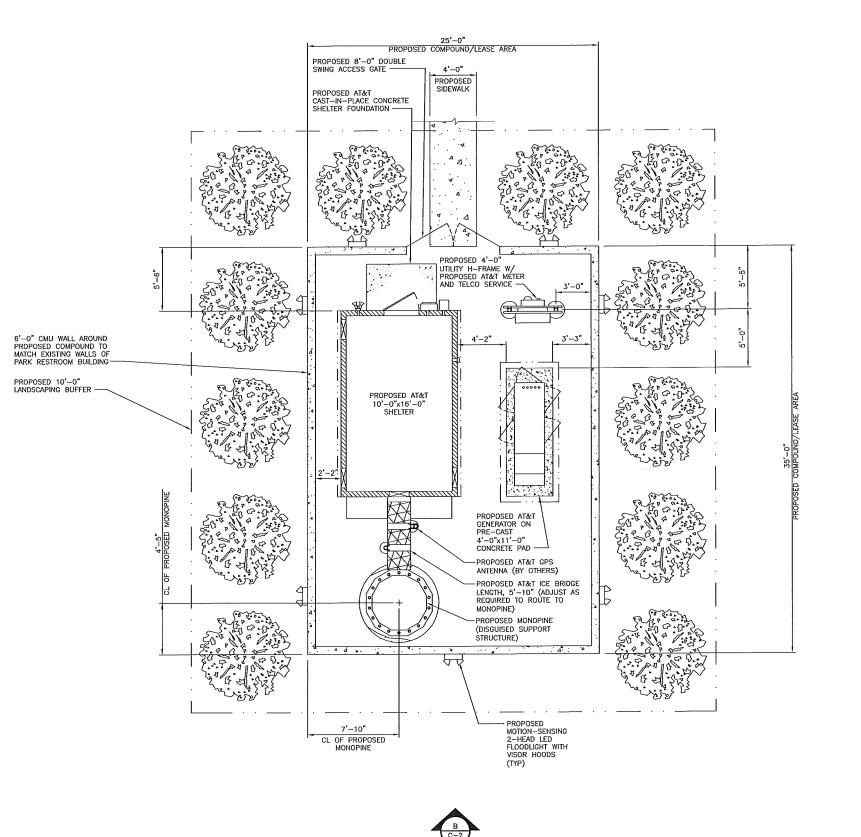
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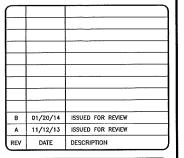



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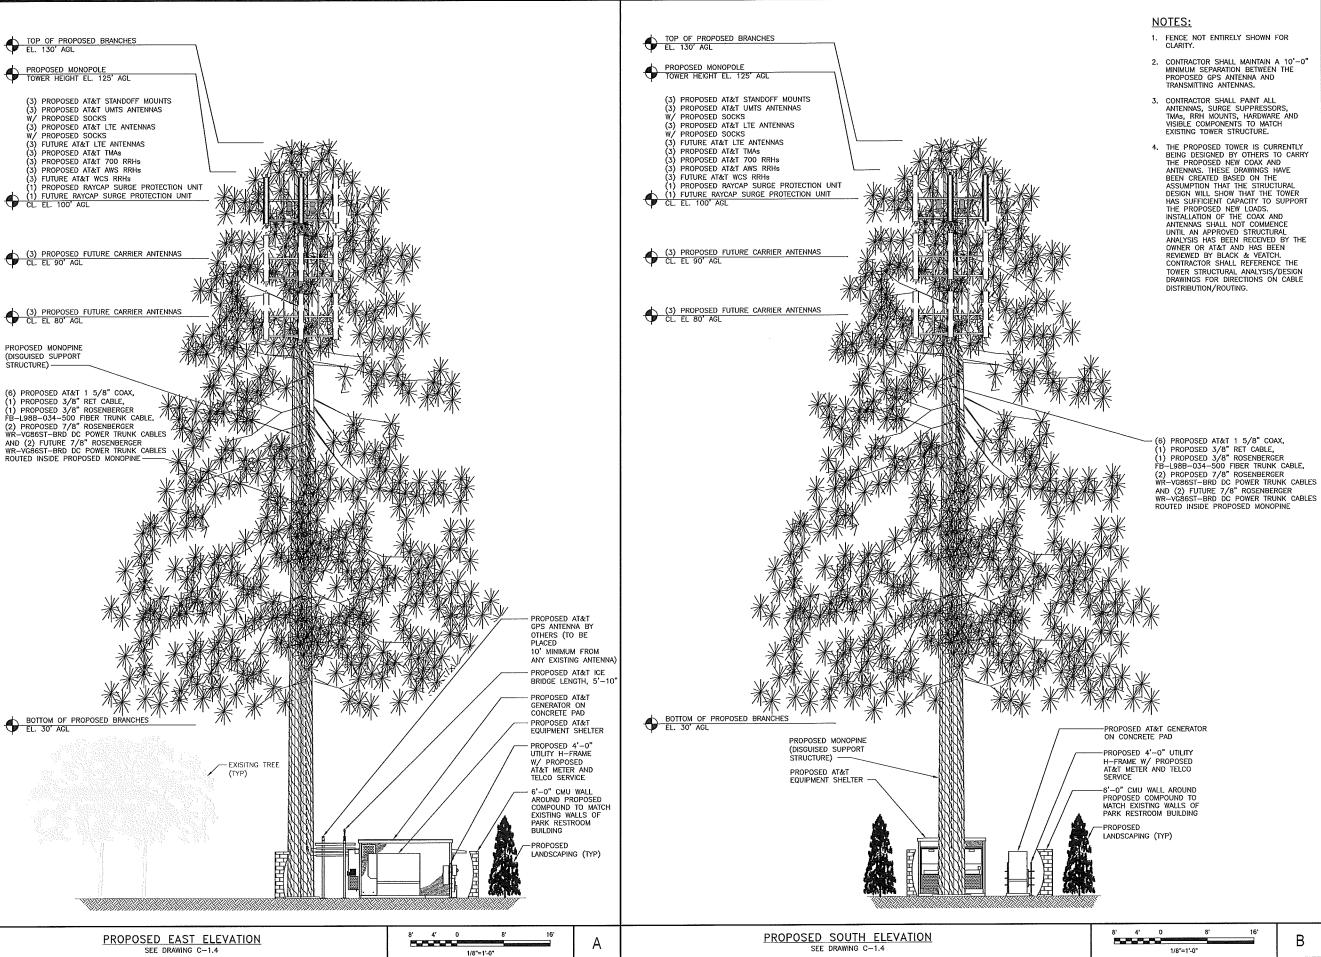
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SITE PLAN

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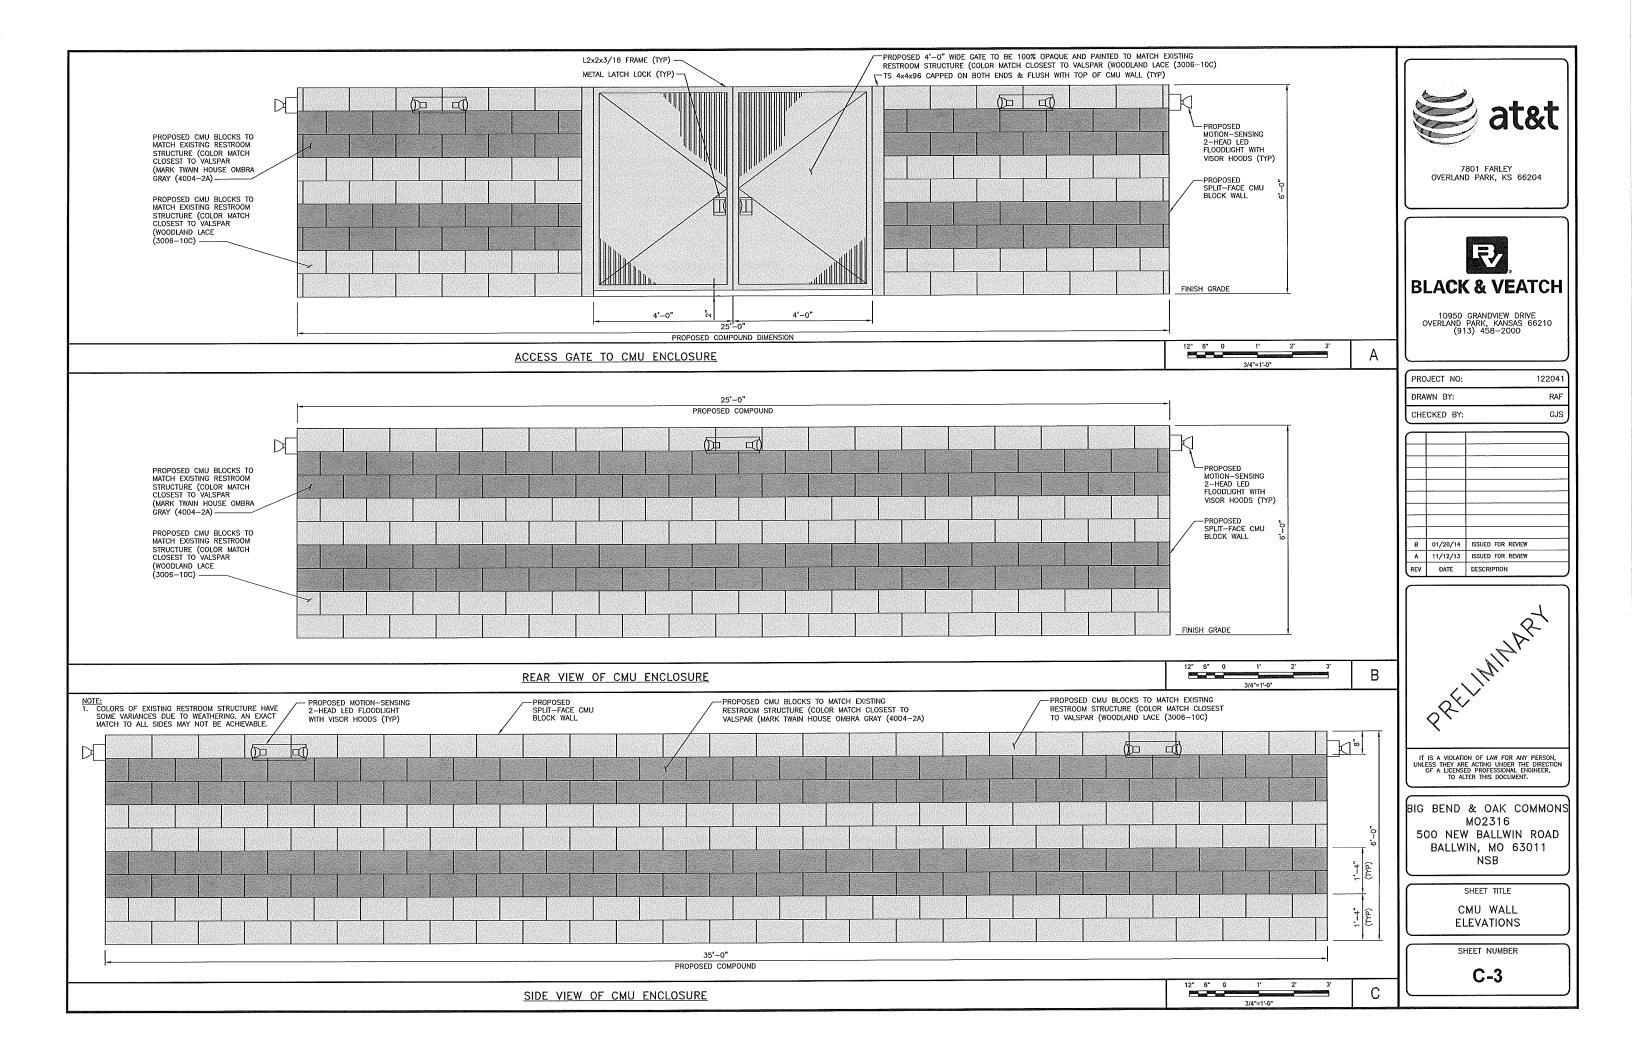
BIG BEND & OAK COMMONS MO2316 500 NEW BALLWIN ROAD BALLWIN, MO 63011 NSB

SHEET TITLE

ELEVATIONS

SHEET NUMBER
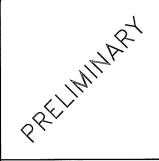
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PLANTING NOTES 12. ALL REQUIRED TREE PROTECTION MEASURES SHALL BE INSTALLED PRIOR TO GRADING OR EXCAVATING. THE CONTRACTOR SHALL COMPLETELY GUARANTEE ALL PLANT MATERIAL FOR A PERIOD OF (1) ONE YEAR BEGINNING AT THE DATE OF TOTAL ACCEPTANCE. THE CONTRACTOR SHALL PROMPTLY MAKE ALL REPLACEMENTS BEFORE OR AT THE END OF THE ALL PLANTS MUST BE HEALTHY, VIGOROUS MATERIAL, FREE OF PEST AND DISEASE. 13. UNDISTURBED BUFFERS SHALL BE REPLANTED TO BUFFER STANDARDS WHERE SPARSELY VEGETATED OR WHERE DISTURBED AT APPROVED UTILITY CROSSINGS. REPLANTING IS SUBJECT COUNTY 2. ALL PLANTS MUST BE CONTAINER-GROWN OR BALLED AND 8. THE OWNER'S REPRESENTATIVE WILL APPROVE THE STAKED ALL PLANTS ARE SUBJECT TO THE APPROVAL OF THE OWNER'S REPRESENTATIVE BEFORE, DURING AND AFTER INSTALLATION. LOCATION OF ALL PLANT MATERIAL PRIOR TO INSTALLATION. 14. LANDLORD TO APPROVE TYPE OF SHRUBBERY PRIOR TO INSTALLATION. ALL PLANTS AND PLANTING AREAS MUST BE COMPLETELY MULCHED AFTER BEING DUG AT THE NURSERY SOURCE, ALL TREES IN LEAF SHALL BE ACCUMULATED FOR TWO (2) WEEKS UNDER A MIST SYSTEM PRIOR TO INSTALLATION. PRIOR TO CONSTRUCTION, THE CONTRACTOR SHALL BE RESPONSIBLE FOR LOCATING ALL UNDERCROUND UTILITIES AND SHALL AVOID DAMAGE TO ALL UTILITIES DURING COURSE OF WORK. THE CONTRACTOR IS RESPONSIBLE FOR REPAIRING ALL DAMAGE TO 7801 FARLEY 10. ANY PLANT MATERIAL THAT DIES, TURNS BROWN OR DEFOLIATES (PRIOR TO TOTAL ACCEPTANCE OF THE WORK SHALL BE PROMPTLY REMOVED FROM THE SITE AND REPLACED WITH MATERIAL OF THE SAME SPECIES, QUANTITY, SIZE AND MEETING ALL SPECIFICATIONS. OVERLAND PARK, KS 66204 COMMON NAME OTY SIZE SPACING SPECIFICATIONS BOTANICAL NAME EVERGREEN JUNIPERUS CHINENSIS TREES 'KETELEERI' KETELERI JUNIPER CONTAINERIZED AS SHOWN ON PLAN MIN 72" IN HEIGHT THE CONTRACTOR IS RESPONSIBLE FOR FULLY MAINTAINING ALL PLANTING AREAS (INCLUDING, BUT NOT LIMITED TO: WATERING, 11. STANDARDS SET FORTH IN "AMERICAN STANDARD FOR NURSERY STOCK". LATEST EDITION REPRESENTS GUIDELINE SPECIFICATIONS ONLY AND SHALL CONSTITUTE MINIMUM QUALITY REQUIREMENTS FOR SPRAYING, MULCHING, FERTILIZATION, ETC) UNTIL THE WORK IS **BLACK & VEATCH** 10950 GRANDVIEW DRIVE OVERLAND PARK, KANSAS 66210 (913) 458-2000 **NOTES** PLANT SCHEDULE PROJECT NO: 122041 RAF LEADER STAKE - 1" X 1" TO EXTEND 2' ABOVE TOP OF TREE. STAKE NOT TO CHECKED BY: GJS PROPOSED 5'-0" UTILITY ACCESS EASEMENT FOR 4 . . 4 ELECTRICAL/TELCO SERVICE PLACE HOSE APPROXIMATELY AT MIDPOINT OF TRUNK WIDTH OF BALL TREE TIE (TYP) -PROPOSED 4'-0" UTILITY H-FRAME W/ PROPOSED AT&T METER AND TELCO SERVICE B 01/20/14 ISSUED FOR REVIEW A 11/12/13 ISSUED FOR REVIEW DATE DESCRIPTION (12) PROPOSED EVERGREEN JUNIPER FOR COVERAGE SCHEDULE) (TYP) 6'-0" CMU WALL AROUND PROPOSED COMPOUND TO MATCH EXISTING WALLS OF PARK RESTROOM BUILDING PROPOSED AT&T В PLANTING DETAIL NO SCALE 10'-0"x16'-0" SHELTER PROPOSED 10'-0" WIDE LANDSCAPING BUFFER (TYP) GENERATOR ON PRECAST 4'-0"x11'-0" CONCRETE PAD IT IS A VIOLATION OF LAW FOR ANY PERSON, EXTEND POLYETHYLENE TUBING 2" BEYOND TRUNK AND BRANCHES BIG BEND & OAK COMMONS PROPOSED MONOPOLE (DISGUISED SUPPORT STRUCTURE) M02316 500 NEW BALLWIN ROAD BALLWIN, MO 63011 NSB SHEET TITLE LANDSCAPING PLAN 7'-10" 25'-0" SHEET NUMBER <u>/N\</u> L-1 С STAKING PLAN NO SCALE LANDSCAPING PLAN 3/16"=1'-0"