


CONTACT INFORMATION

WATER	SEWER
MISSOURI AMERICAN WATER	METROPOLITAN SEWER DISTRICT
REPRESENTATIVE: DAVE PRUITT ADDRESS: 727 CRAIG ROAD ST. LOUIS, MISSOURI 63141 PHONE: (314) 996-2396	REPRESENTATIVE: JOHN C. GRIMM, P.E. ADDRESS: 2350 MARKET STREET ST. LOUIS, MO 63103-2555 PHONE: (314) 768-2743
ELECTRIC	GAS
AMEREN	SPIRE
REPRESENTATIVE: LES NOLAN ADDRESS: 9823 MACKENZIE ROAD ST. LOUIS, MISSOURI 63123 PHONE: (314) 393-7635	REPRESENTATIVE: BRIAN LANGENBACHER ADDRESS: 4118 SHREWSBURY AVENUE SHREWSBURY, MISSOURI 63119 PHONE: (314) 713-6572
TELEPHONE	CABLE
AT&T	CHARTER COMMUNICATIONS
REPRESENTATIVE: DANIEL GRAY ADDRESS: PHONE: (314) 415-0832	REPRESENTATIVE: RONALD DUMKE ADDRESS: 101 NW PLAZA DR. ST. ANN, MISSOURI 63074 PHONE: (314) 267-9581
OWNER	
CITY OF BALLWIN	MoDOT
REPRESENTATIVE: JIM LINK ADDRESS: 14811 MANCHESTER ROAD BALLWIN, MO 63011 PHONE: (636) 227-8580	REPRESENTATIVE: JILL STEIGER ADDRESS: 1590 WOODLAKE DRIVE CHESTERFIELD, MISSOURI 63017-5712 PHONE: (314) 453-5061

LOCATION INFORMATION **LENGTH OF PROJECT**

QUADRANGLE/YEAR: MANCHESTER/2017 TOWNSHIP: 45N RANGE: 4E US SURVEY 1979	START OF PROJECT: STA. 13+17.04 END OF PROJECT: STA. 80+71.11 PROJECT LENGTH: 6754.07 FEET FUNCTIONAL CLASSIFICATION: COLLECTOR ADT: 7625 (2015), 7820 (2020) DESIGN SPEED: 30 MPH
--	---

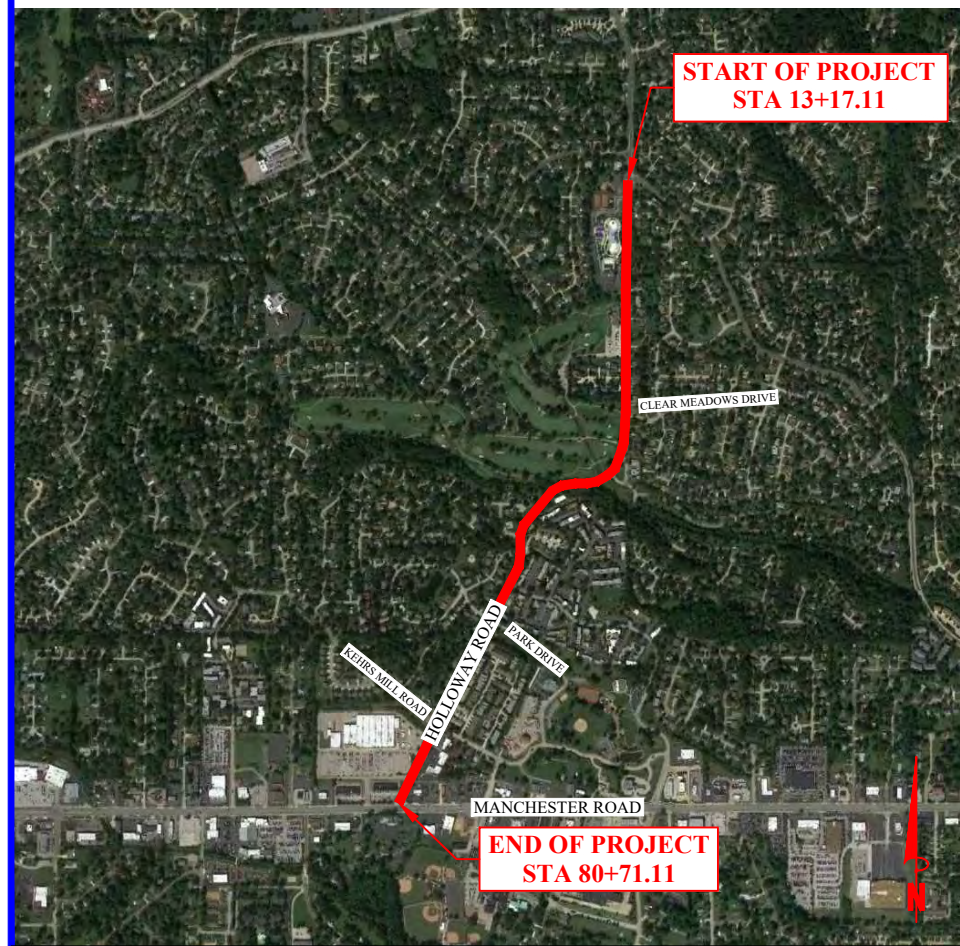

VICINITY MAP
NOT TO SCALE

HOLLOWAY ROAD IMPROVEMENTS

IN THE
CITY OF BALLWIN
ST. LOUIS COUNTY, MISSOURI
FEDERAL PROJECT NO. STP-4939(608)



14811 MANCHESTER ROAD
BALLWIN, MO 63011
TELEPHONE (636) 227-8580
FAX (636) 207-2320
www.ballwin.mo.us



- Civil Engineering
- Land Surveying
- Architecture
- Site Development
- Master Planning
- General Consulting

737 RUDDER RD.
FENTON, MISSOURI 63026
TELEPHONE (314) 842-4033
FAX (314) 842-5957
www.cochraneng.com

COCHRAN PROJECT NO. SC19-981
JANUARY 2021

SHEET INDEX

SHEET NAME	SHEET NO.
QUANTITY SHEET	Q-1
TOPOGRAPHIC SURVEY	TS-1 TO TS-11
CORING SAMPLES	CS-1
LEGEND AND GENERAL NOTES	LG-1
TYPICAL SECTIONS	TXS-1
SITE PLAN	S-1 TO S-11
GRADING PLAN	C-1 TO C-5
PAVEMENT MARKING AND SIGNAGE	PM-1 TO PM-11
PAVEMENT PHASING PLAN	PH-1
TRAFFIC CONTROL AND DETAILS	TC-1 TO TC-4
EROSION CONTROL PLAN/DETAILS	EC-1 TO EC-12
SIDEWALK AND CURB RAMP DETAILS	DE-1 TO DE-8
DRIVEWAY DETAILS	DE-9 TO DE-13
MISCELLANEOUS DETAILS	DE-14 TO DE-18
CROSS SECTIONS	XS-1 TO XS-14
MODOT STANDARD DETAILS	7 SHEETS

DESIGN DESIGNATION

FUNCTIONAL CLASSIFICATION: COLLECTOR
CURRENT POSTED SPEED: 30 MPH
DESIGN SPEED: 30 MPH
CURRENT ADT: 7,625
DESIGN ADT: 7,820 (2020)

ALL OSHA RULES & REGULATIONS ESTABLISHED FOR THE TYPE OF CONSTRUCTION REQUIRED BY THESE PLANS SHALL BE STRICTLY FOLLOWED (IE. TRENCHING, BLASTING, ETC.)

TWO WORKING DAYS PRIOR TO THE START OF ANY EXCAVATION ON THIS SITE, CONTRACTOR SHALL CALL 1-800-DIG-RITE FOR UTILITY LOCATION INFORMATION.

WHERE THE TERM "STANDARD SPECIFICATIONS" IS USED, SUCH REFERENCE SHALL MEAN THE CURRENT EDITION OF THE MISSOURI STANDARD SPECIFICATIONS FOR HIGHWAY CONSTRUCTION, EXCEPT AS OTHERWISE PROVIDED IN THE PROJECT MANUAL. IN CASE OF CONFLICT IN THE REQUIREMENTS OF THE STANDARD SPECIFICATIONS AND THE REQUIREMENTS STATED IN THE PROJECT MANUAL, THE REQUIREMENTS IN THE PROJECT MANUAL SHALL PREVAIL.

Stormwater Management Future Disturbance Note:

Project Disturbance = 5.09 ACRES
Disturbed Area Considered Maintenance Area = 5.09 ACRES
Project Runoff Differential = 0.00 CFS

Any future land disturbance and/or increase in impervious area on this site may require additional stormwater management per MSD regulations in place at the time (including total land disturbance and/or imperviousness added on this plan.)



1/1/21
KEVIN J. WOLFF
NO. PE-200400859
STATE OF MISSOURI
REGISTERED PROFESSIONAL ENGINEER
FOR SO ENGINEERING LLC,
DBA COCHRAN

THIS SHEET HAS BEEN SIGNED,
SEALED AND DATED ELECTRONICALLY

THE PROFESSIONAL'S SEAL AFFIXED TO THIS SHEET APPLIES ONLY TO ITEMS ON THIS SHEET. ALL DRAWINGS OR OTHER DOCUMENTS NOT EXHIBITING THIS SEAL SHALL NOT BE CONSIDERED PREPARED BY THIS PROFESSIONAL.

ENGINEERING CERTIFICATE OF AUTHORITY NUMBER - 2007006937
LAND SURVEYING CERTIFICATE OF AUTHORITY NUMBER - 2007004529

CITY OF BALLWIN

ACCEPTED BY:

JIM LINK
DIRECTOR OF PUBLIC WORKS


QUANTITY SHEET

Bid No.	Spec. No.	Description	From STA	To STA	Unit	Quantity
ROADWAY ITEMS						
1	2022010	Removal of Improvements	13+17	80+71	LS	1
2	2038000	Earthwork	13+17	80+71	STA	67.6
3	3040506	Type 5 Aggregate Base, 6" (For Concrete Pavement, 10 and 8" Only)	77+32	80+71	SY	2,154
4	4011209	Bituminous Pavement Mixture PG64-22, (BP-1), 3" Thick	10+49	77+32	TON	3,720
5	5021100	Concrete Pavement, 10" (High Early)	13+17	35+23	SY	2,004
6	5021100	Concrete Pavement, 8" (High Early)	13+17	35+23	SY	150
7	6061010	Replace Guard Rail	48+68	49+75	LF	107
8	6083006	Dowelled On Concrete Island, 6"	80+01	80+49	SF	365
9	6085000	Concrete Approach, 6" (Remove and Replace)	21+45	65+20	SF	1,465
10	6091012	Concrete Vertical Curb, 6" (Remove and Replace)	35+08	60+65	LF	210
11	6091053	Concrete Curb and Gutter (Remove and Replace)	13+17	80+71	LF	1,890
12	6091054	Concrete Rolled Curb and Gutter (Remove and Replace)	28+40	30+95	LF	180
13	6131000	Full Depth Pavement (Repair)	13+17	80+71	SY	100
14	6161025	Channelizers (Trimline)	13+17	80+71	EA	150
15	6181000	Mobilization	13+17	80+71	LS	1
16	6221001	Coldmilling Bituminous Pavement	13+17	77+32	SY	21,860
17	8061007A	Inlet Checks	13+40	80+50	EA	26
18	8061019	Silt Fence	13+17	80+65	LF	1,785
19	9031243	18" Surface-Mount Delineator Post	80+01	80+49	EA	6
20	MSD	Curb or Area Inlet Top Replacement	38+85	77+35	EA	14
21	MSD	Double Curb Inlet Top Replacement	29+60	52+55	EA	8
22	JSP	Subgrade Repair	13+17	80+71	CY	10

Bid No.	Spec. No.	Description	From STA	To STA	Unit	Quantity
SIGNING/STRIPING/SIGNALS ITEMS						
23	6161006	"Road Work Ahead" Sign (W20-1)	13+17	80+71	EA	10
24	6161006	"Shoulder Work Ahead" Sign (W21-5)	13+17	80+71	EA	4
25	6161006	"End Road Work" Sign (G20-2)	13+17	80+71	EA	2
26	6161006	"One Lane Road Ahead" Sign (W20-4)	13+17	80+71	EA	4
27	6161006	"Flagger" Sign (W20-7a)	13+17	80+71	EA	4
28	6161006	"Road Closed" Sign (R11-2R)	13+17	80+71	EA	4
29	6161006	"Sidewalk Closed" Sign (R9-9)	13+17	80+71	EA	8
30	6161006	"No Left Turn" Sign (R3-2)	13+17	80+71	EA	3
31	6161006	"Detour Left Arrow - Holloway Road" Custom Sign	13+17	80+71	EA	3
32	6161006	"Detour Straight Arrow - Holloway Road" Custom Sign	13+17	80+71	EA	3
33	6161006	"Detour Right Arrow - Holloway Road" Custom Sign	13+17	80+71	EA	2
34	6161006	"End Detour - Holloway Road" Custom Sign	13+17	80+71	EA	2
35	6161031	"Type I" Movable Barricade with light	13+17	80+71	EA	16
36	6161031	Type III Moveable Barricade with Type C Warning Lights	13+17	80+71	EA	37
37	6161099	Changeable Message Sign with Communication Interface, Contractor Furnished, Contractor Retained	13+17	80+71	EA	2
38	6201002 6201005	Pavement Marking 4" - Yellow and White (Epoxy, No Grinding)	13+17	80+55	LF	16,100
39	6201011	Pavement Marking 12" - White (Epoxy, No Grinding)	60+55	80+45	LF	995
40	6201014	Pavement Marking 24" - White (Epoxy, No Grinding)	60+51	80+11	LF	176
41	6201020	Pavement Marking Turn Lane Arrow (Epoxy, No Grinding)	13+38	79+80	EA	16
42	6201023	Pavement Marking Through Lane Arrow (Epoxy, No Grinding)	70+08	74+68	EA	5
43	6201026	Pavement Marking Combination Turn & Through Lane Arrow (Epoxy, No Grinding)	70+08	70+75	EA	2
44	6209902	Pavement Marking Shared Lane Symbol (Epoxy, No Grinding)	21+00	69+40	EA	10
45	9035000	"Share the Road" Sign (W16-1)	21+00	69+40	EA	10
46	9035000	"Bike" Sign (W11-1)	21+00	69+40	EA	10
BICYCLE/PEDESTRIAN FACILITY ITEMS						
47	6081010	Concrete Curb Ramp, 6"	34+55	80+47	SF	2,026
48	6081012	Detectable Warning Device	34+65	80+47	SF	272
49	6086004	Concrete Sidewalk, 4"	34+50	80+69	SF	996
LANDSCAPING/STREETSCAPING ITEMS						
50	7034009	Concrete Retaining Wall	56+46	56+68	CY	600
51	8031000	Sodding	13+17	80+71	SY	10

Drawing name: I:\SC19-981 Holloway Road, Ballwin, MO\AUTOCAD DRAWINGS\QUANTITY SHEET.dwg Tab: Q-1 Plotted on: Feb 09, 2021 - 10:27am Plotted by: kwloff

314-842-4033 (tel.)
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 www.cochraneng.com
COCHRAN
 Civil Engineering
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 ENGINEERING CERTIFICATE OF AUTHORITY NUMBER - 2007006937
 LAND SURVEYING CERTIFICATE OF AUTHORITY NUMBER - 2007004529

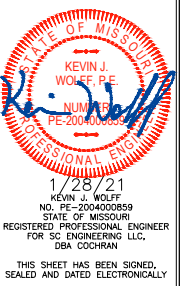

1/28/21
 KEVIN J. WOLFF
 NO. PE-200400859
 STATE OF MISSOURI
 REGISTERED PROFESSIONAL ENGINEER
 FOR SC ENGINEERING LLC,
 DBA COCHRAN
 THIS SHEET HAS BEEN SIGNED,
 SEALED AND DATED ELECTRONICALLY

THE PROFESSIONAL'S SEAL AFFIXED TO
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 ON THIS SHEET. ALL DRAWINGS OR
 OTHER DOCUMENTS NOT EXHIBITING
 THIS SEAL SHALL NOT BE CONSIDERED
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HOLLOWAY ROAD IMPROVEMENTS
FEDERAL PROJECT NO. STP-4939(608)
CITY OF BALLWIN, MISSOURI


DATE:	DATE:	DATE:
REVISION:	DWN. BY:	APPD. BY:
	K.J.W.	M.D.S.
	DATE:	JANUARY 2021
	SCALE:	NO SCALE
	PROJ. NO.:	SC19-981
	DWG. NO.:	Q-1

THIS SITE LIES WITHIN SEC 26 AND SEC 35, AND USS 1908, T45N, R4E

LAND TIE: FOUND 1/2" IRON ROD (ADOPT) AT NE CORNER OF ROW EXCEPTION TO BK. 17760, PG. 3499 PER BK. 8455, PG. 1081 (S04°54'21"E OF CL ROAD STA. 10+00)

THIS PROJECT IS ORIENTED TO GRID NORTH DERIVED FROM GPS OBSERVATIONS OF MISSOURI GRS MONUMENT SL-194 USING MODOT'S RTK GPS NETWORK.

TOPOGRAPHIC SURVEY

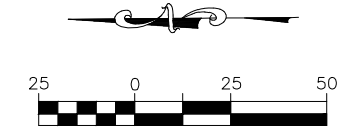

314-842-4033 (tel.)
314-842-5957 (fax)
www.cochraneng.com

COCHRAN

737 RUDDER ROAD
FENTON, MISSOURI 65026

Civil Engineering
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ENGINEERING CERTIFICATE OF AUTHORITY NUMBER - 2007006937
LAND SURVEYING CERTIFICATE OF AUTHORITY NUMBER - 2007004529

STATE OF MISSOURI
TIMOTHY J. VAN LEER
NUMBER PLS-200700007
PROFESSIONAL LAND SURVEYOR
FOR SO ENGINEERING LLC,
DBA COCHRAN

1/28/21
TIMOTHY J. VAN LEER
NO. PLS-200700007
STATE OF MISSOURI
PROFESSIONAL LAND SURVEYOR
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FEDERAL PROJECT NO. STP-4939(608)
CITY OF BALLWIN, MISSOURI


TOPOGRAPHIC SURVEY

DATE: _____ REVISION: _____

DWN. BY: Z.B.H. APPD. BY: T.J.V.
DATE: JANUARY 2021

SCALE: 1" = 50'

PROJ. NO.: SC19-981
DWG. NO.: TS-3

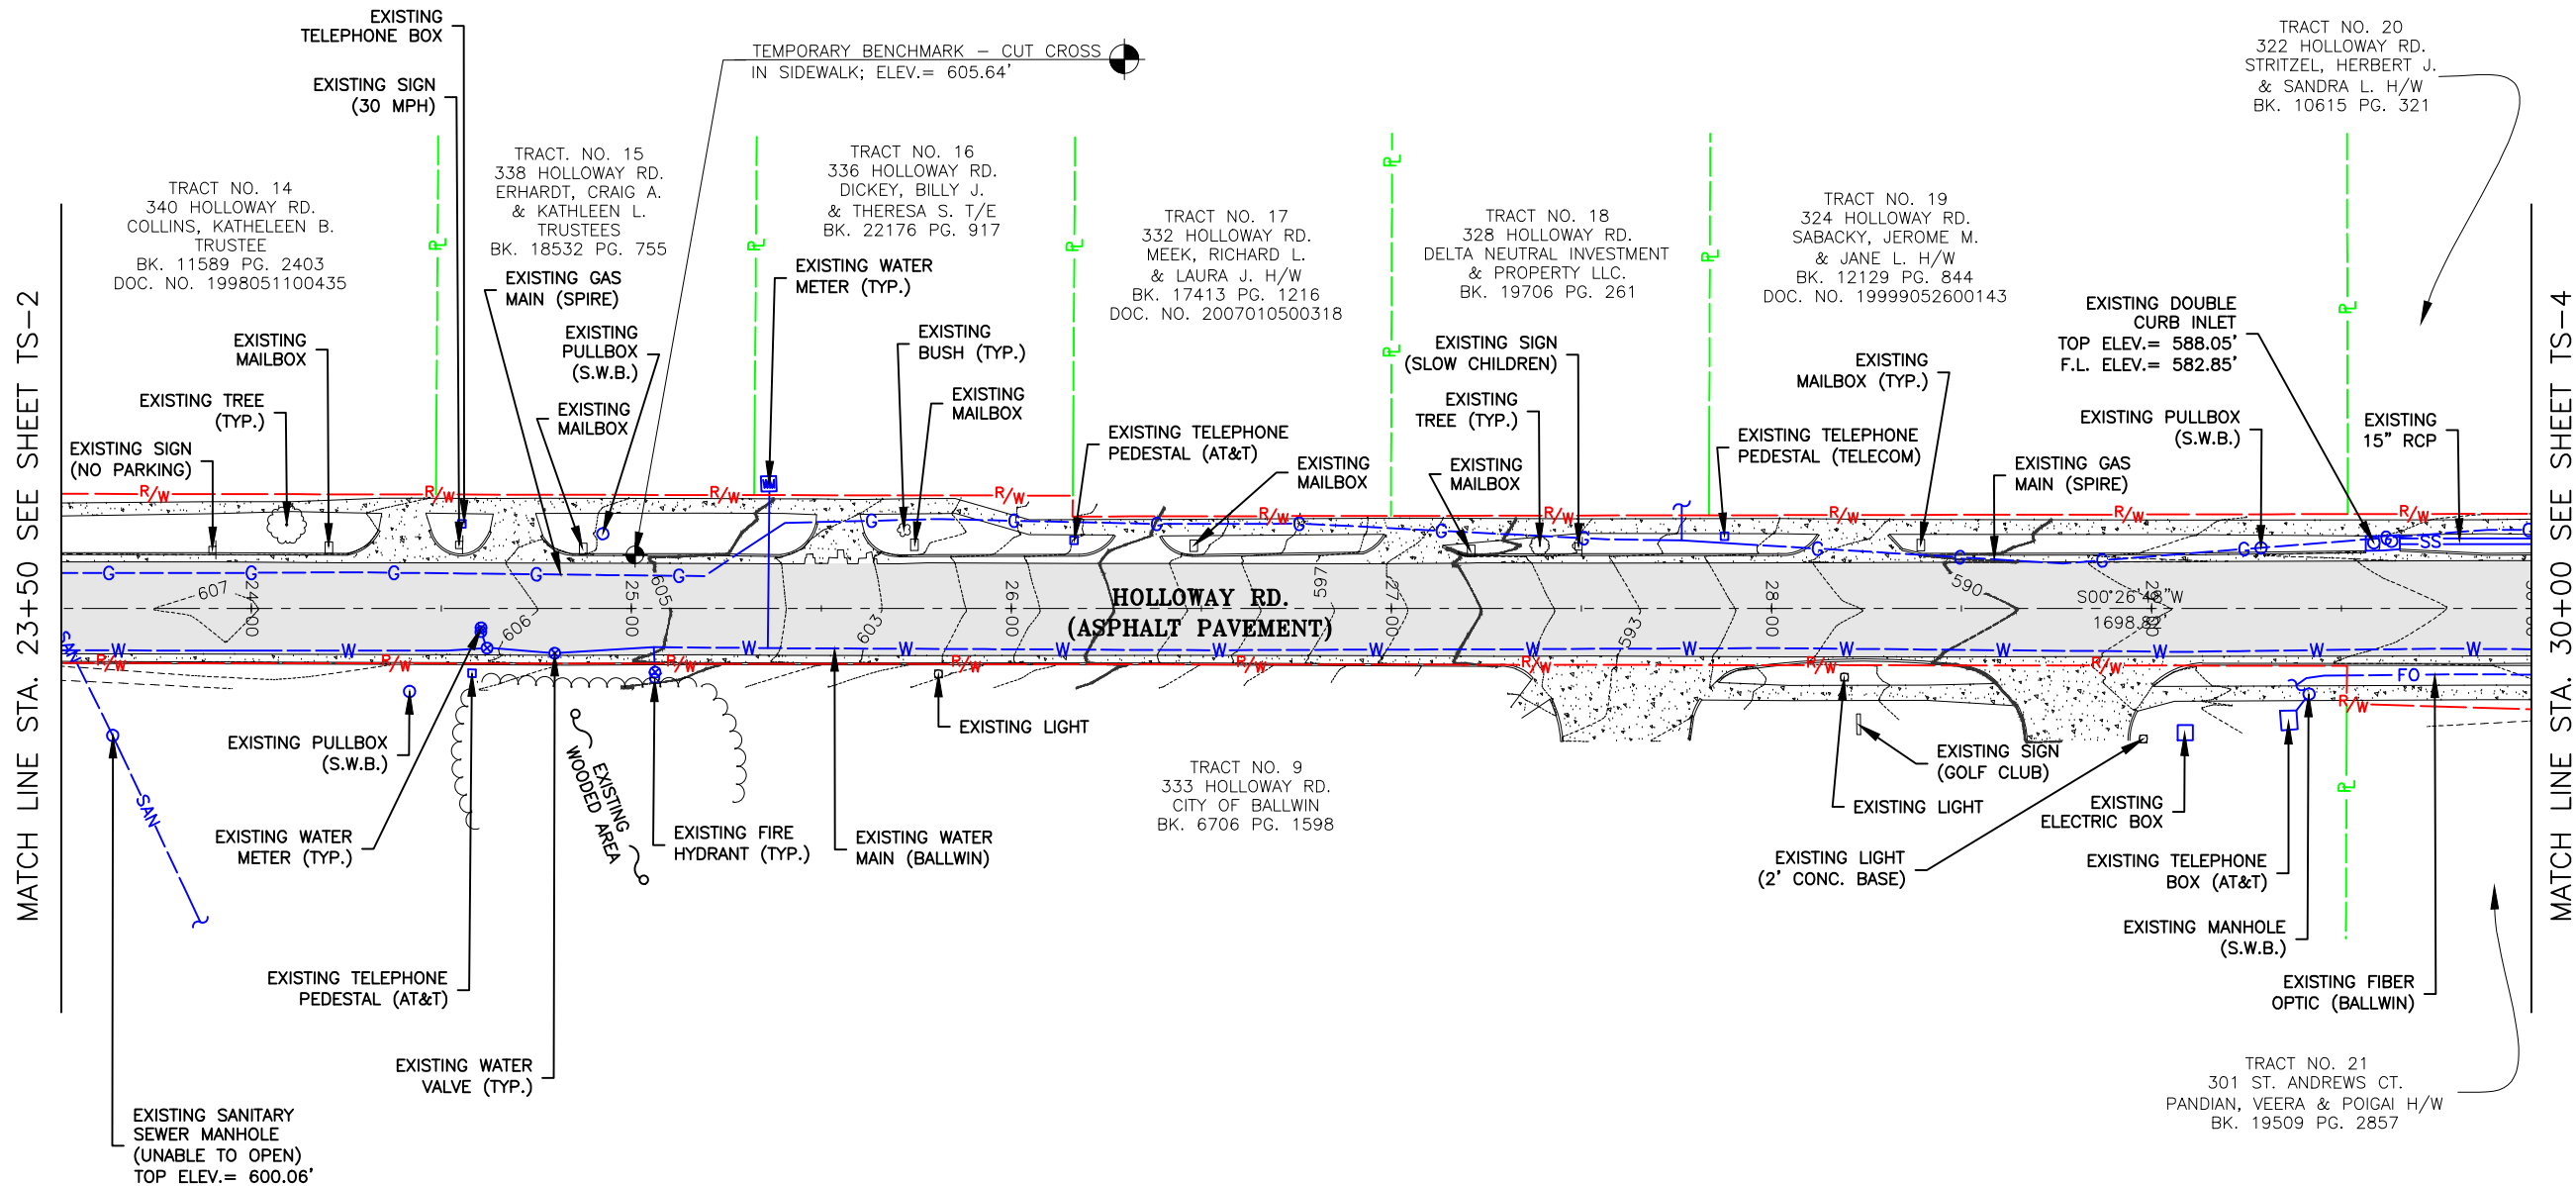

- NOTES:
- UNDERGROUND STRUCTURES, FACILITIES, AND UTILITIES HAVE BEEN PLOTTED FROM AVAILABLE SURVEYS AND RECORDS. THEREFORE, THEIR LOCATIONS MUST BE CONSIDERED APPROXIMATE ONLY. THERE MAY BE OTHERS, THE EXISTENCE OF WHICH IS PRESENTLY NOT KNOWN.
 - SITE BENCHMARK IS MISSOURI GRS MONUMENT SL-194, ELEV.= 562.47 FEET (NAVD88). TEMPORARY BENCHMARK IS A CROSS CUT IN THE CONCRETE ON THE EAST SIDE OF HOLLOWAY RD. AT APPROXIMATELY STA. 25+00 AS SHOWN ABOVE, ELEV.= 605.64.
 - THE CONTRACTOR IS SPECIFICALLY CAUTIONED THAT THE LOCATION AND/OR ELEVATION OF EXISTING UTILITIES AS SHOWN ON THESE PLANS IS BASED ON RECORDS OF VARIOUS UTILITY COMPANIES AND, WHERE POSSIBLE, MEASUREMENTS TAKEN IN THE FIELD. THE INFORMATION IS NOT TO BE RELIED ON AS BEING EXACT OR COMPLETE. THE CONTRACTOR SHALL FIELD VERIFY THE LOCATION AND ELEVATION OF ALL POTENTIAL UTILITY CONFLICTS PRIOR TO ORDERING MATERIALS FOR CONSTRUCTION. THE CONTRACTOR MUST CALL THE APPROPRIATE UTILITY COMPANY AT LEAST 48 HOURS BEFORE ANY EXCAVATION TO REQUEST EXACT FIELD LOCATION OF UTILITIES. LOCATION, RELOCATION AND CONNECTION OF THE UTILITIES SHALL BE COORDINATED WITH THE UTILITY COMPANIES.
 - TOPOGRAPHIC INFORMATION AS SHOWN HEREON PER FIELD WORK PERFORMED BY J.W.B., Z.B.H., AND A.M.T.B. OF COCHRAN, DATED SEPTEMBER 2019.
 - THIS PROJECT IS ORIENTED TO GRID NORTH DERIVED FROM GPS OBSERVATIONS OF MISSOURI GRS MONUMENT SL-194 USING MODOT'S RTK GPS NETWORK.
 - THIS SITE LIES ENTIRELY WITHIN "ZONE X", AREAS DETERMINED TO BE OUTSIDE THE 0.2% ANNUAL CHANCE FLOODPLAIN, AREAS OF 0.2% ANNUAL CHANCE FLOOD; AREAS OF 1% ANNUAL CHANCE FLOOD WITH AVERAGE DEPTHS OF LESS THAN 1 FOOT OR WITH DRAINAGE AREAS LESS THAN 1 SQUARE MILE PER FEMA FLOOD INSURANCE RATE MAP NUMBER 29189C0281K, EFFECTIVE DATE FEBRUARY 4, 2015.
 - THIS TOPOGRAPHIC SURVEY DOES NOT CONSTITUTE A PROPERTY BOUNDARY SURVEY.

LEGEND			
PROPERTY LINE	- - - - -	EXISTING UTILITY POLE	⊙
RIGHT-OF-WAY	- R/W -	EXISTING SANITARY SEWER	- SAN -
CENTERLINE OF ROAD	- - - - -	EXISTING WATER MAIN	- W -
EXISTING STRIPING	- - - - -	EXISTING GAS MAIN	- G -
EXISTING MAJOR CONTOUR	- -970 - -	EXISTING STORM SEWER	- SS -
EXISTING MINOR CONTOUR	- - - - -	EXISTING UNDERGROUND TELEPHONE	- UGT -
EXISTING BUILDING	▒▒▒▒▒	EXISTING UNDERGROUND ELECTRIC	- UGE -
EXISTING CONCRETE PAVEMENT	▒▒▒▒▒	EXISTING TELEPHONE PEDESTAL	□
EXISTING GRAVEL	▒▒▒▒▒	EXISTING WATER VALVE	⊕
EXISTING ASPHALT PAVEMENT	▒▒▒▒▒	EXISTING WATER METER	⊕
EXISTING AERIAL ELECTRIC	- AE -	EXISTING FIBER OPTIC	- FO -
		EXISTING GAS VALVE	⊕
		EXISTING FIRE HYDRANT	⊕
		EXISTING MAILBOX	□
		EXISTING SIGN	⊕
		EXISTING FENCE	- X -
		EXISTING LIGHT	⊕
		EXISTING BUSH	⊕
		EXISTING TREE	⊕
		EXISTING UTILITY (TERMINUS UNKNOWN)	⊕
		EXISTING GUY WIRE	→
		EXISTING EDGE OF WOODS	⊕

Drawing name: I:\SC19-981 Holloway Road, Ballwin, MO\AUTOCAD DRAWINGS\TOPOGRAPHIC SURVEY.dwg Tab: TS-3 Plotted on: Feb 09, 2021 - 10:27am Plotted by: kwelff

THIS SITE LIES WITHIN SEC 26 AND SEC 35, AND USS 1908, T45N, R4E



LAND TIE: FOUND 1/2" IRON ROD (ADOPT) AT NE CORNER OF ROW EXCEPTION TO BK. 17760, PG. 3499 PER BK. 8455, PG. 1081 (S04°54'21"E OF CL ROAD STA. 10+00)

THIS PROJECT IS ORIENTED TO GRID NORTH DERIVED FROM GPS OBSERVATIONS OF MISSOURI GRS MONUMENT SL-194 USING MODOT'S RTK GPS NETWORK.

TOPOGRAPHIC SURVEY

EXISTING SIGN (CLEAR MEADOWS DR.)

EXISTING CURB INLET
TOP ELEV.= 568.58'
NORTH F.L. ELEV.= 562.78'
SOUTH F.L. ELEV.= 562.78'
EAST F.L. ELEV.= 562.78'
WEST F.L. ELEV.= 564.48'

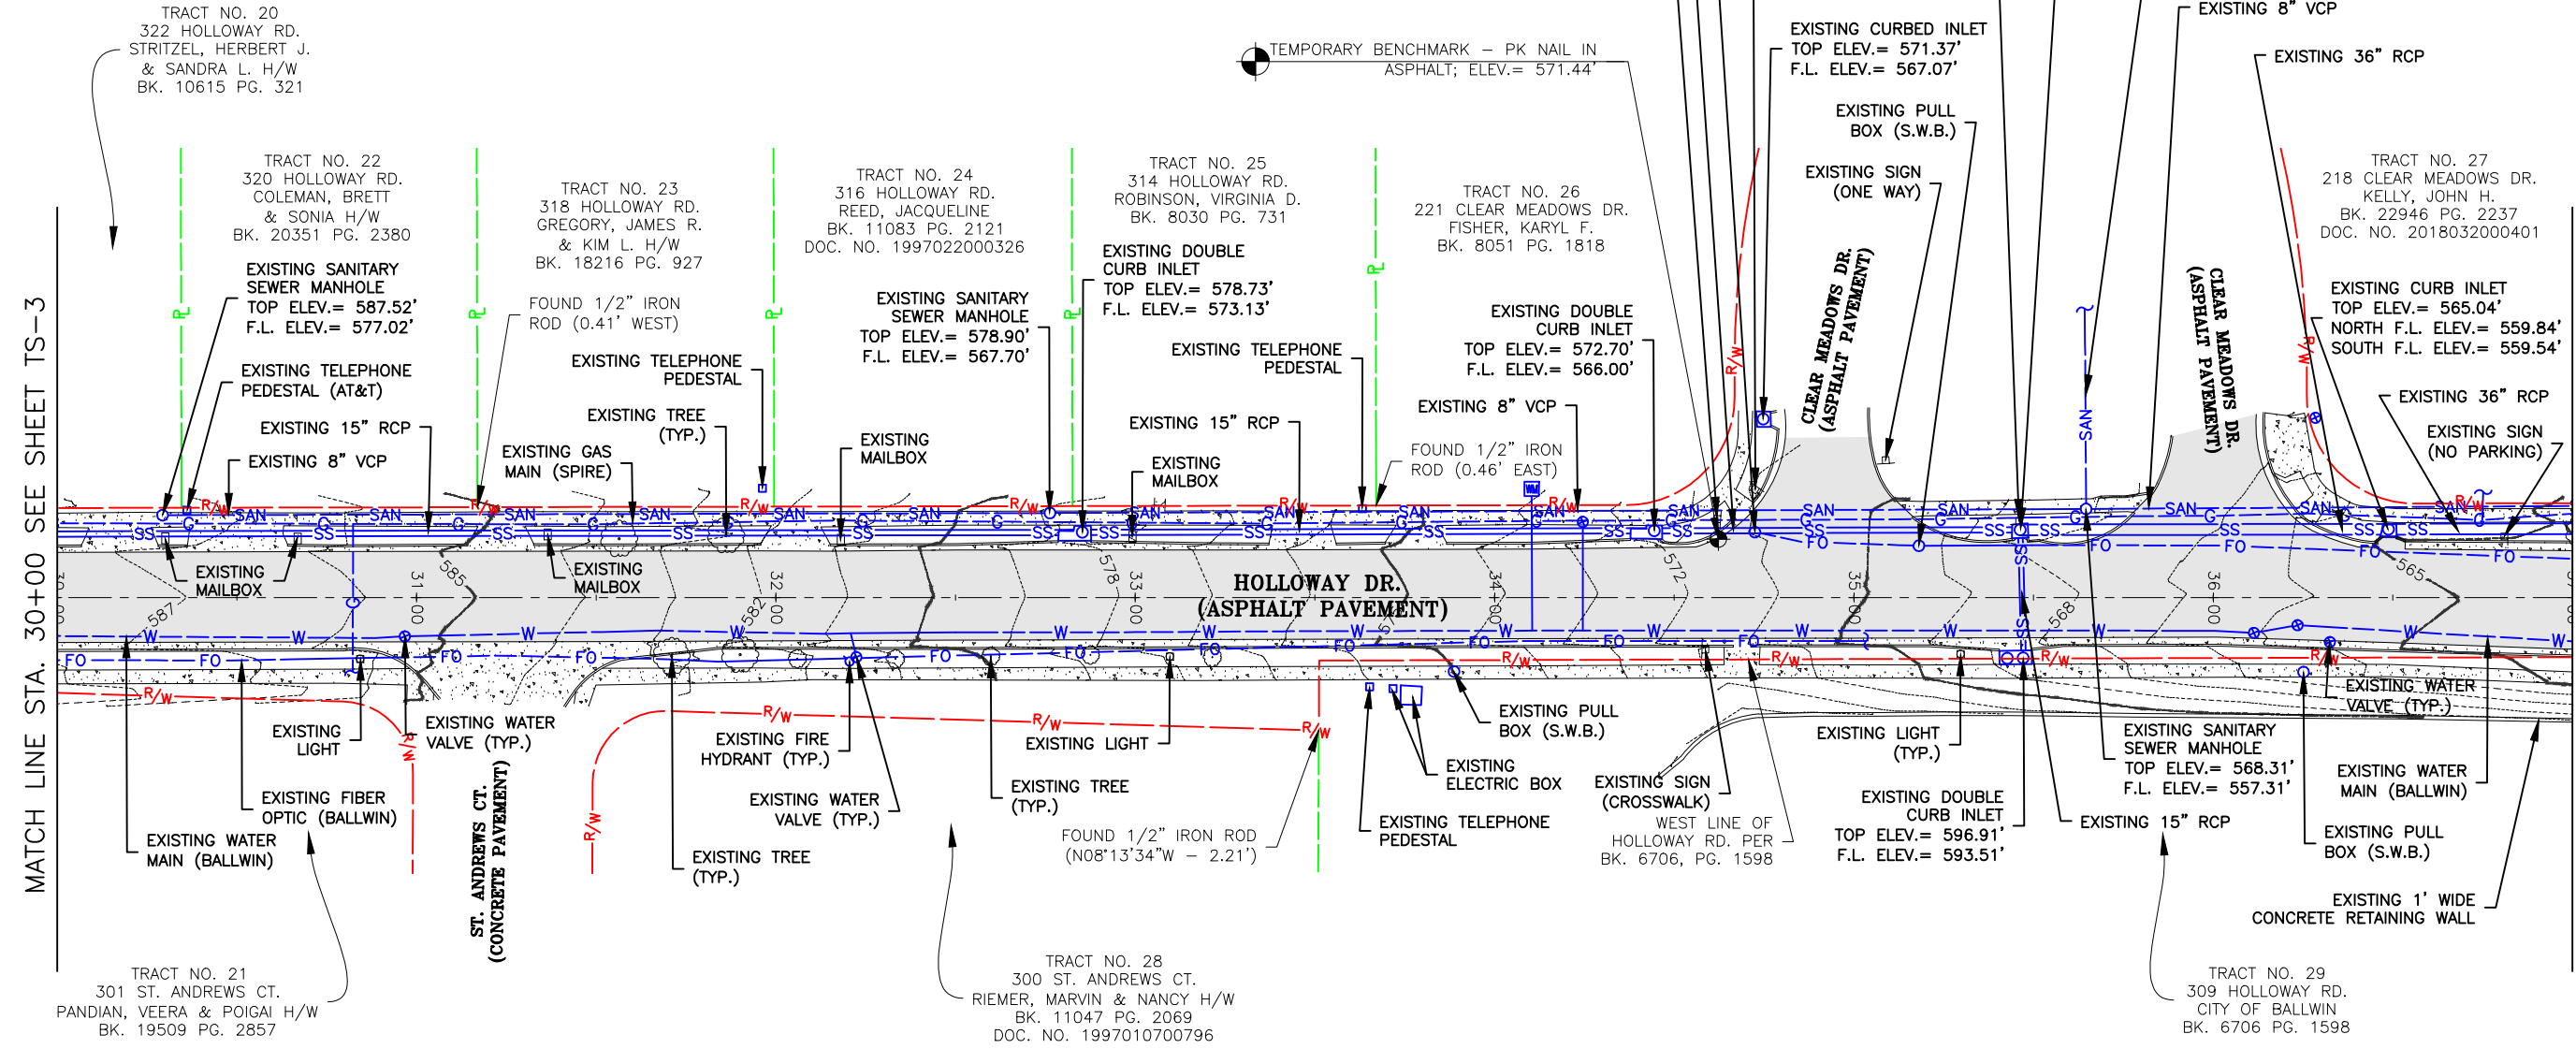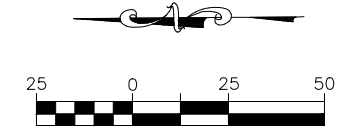

MATCH LINE STA. 30+00 SEE SHEET TS-3

MATCH LINE STA. 37+00 SEE SHEET TS-5

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LEGEND			
PROPERTY LINE	---P---	EXISTING UTILITY POLE	-O-
RIGHT-OF-WAY	---R/W---	EXISTING SANITARY SEWER	---SAN---
CENTERLINE OF ROAD	---	EXISTING WATER MAIN	---W---
EXISTING STRIPING	---	EXISTING GAS MAIN	---G---
EXISTING MAJOR CONTOUR	---970---	EXISTING STORM SEWER	---SS---
EXISTING MINOR CONTOUR	---	EXISTING UNDERGROUND TELEPHONE	---UGT---
EXISTING BUILDING	▒	EXISTING UNDERGROUND ELECTRIC	---UGE---
EXISTING CONCRETE PAVEMENT	▒	EXISTING TELEPHONE PEDESTAL	□
EXISTING GRAVEL	▒	EXISTING WATER VALVE	⊗
EXISTING ASPHALT PAVEMENT	▒	EXISTING WATER METER	⊕
EXISTING AERIAL ELECTRIC	---AE---	EXISTING FIBER OPTIC	---FO---
		EXISTING GAS VALVE	⊙
		EXISTING FIRE HYDRANT	⊕
		EXISTING MAILBOX	□
		EXISTING SIGN	⊠
		EXISTING FENCE	---X---
		EXISTING LIGHT	□
		EXISTING BUSH	⊗
		EXISTING TREE	⊙
		EXISTING UTILITY (TERMINUS UNKNOWN)	---
		EXISTING GUY WIRE	---
		EXISTING EDGE OF WOODS	---

314-842-4033 (tel.)
314-842-5957 (fax)
www.cochraneng.com

COCHRAN

737 RUDDER ROAD
FENTON, MISSOURI 65026

Civil Engineering
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Master Planning
General Consulting

ENGINEERING CERTIFICATE OF AUTHORITY NUMBER - 2007006937
LAND SURVEYING CERTIFICATE OF AUTHORITY NUMBER - 2007004529

STATE OF MISSOURI

TIMOTHY J. VAN LEER

NUMBER PLS-2007000007

1/28/21

TIMOTHY J. VAN LEER
NO. PLS-2007000007
STATE OF MISSOURI
PROFESSIONAL LAND SURVEYOR
FOR SO ENGINEERING LLC,
DBA COCHRAN

THIS SHEET HAS BEEN SIGNED,
SEALED AND DATED ELECTRONICALLY

HOLLOWAY ROAD IMPROVEMENTS
FEDERAL PROJECT NO. STP-4939(608)
CITY OF BALLWIN, MISSOURI

TOPOGRAPHIC SURVEY

DATE: _____

DATE: _____

DATE: JANUARY 2021

SCALE: 1" = 50'

PROJ. NO.: SC19-981

DWG. NO.: TS-4

DWN. BY: Z.B.H. APPD. BY: T.J.V.



Drawing name: U:\SC19-981 Holloway Road, Ballwin, MO\AUTOCAD DRAWINGS\TOPOGRAPHIC SURVEY.dwg Tab: TS-4 Plotted on: Feb 09, 2021 - 10:28am Plotted by: kweliff

THIS SITE LIES WITHIN SEC 26 AND SEC 35, AND USS 1908, T45N, R4E

LAND TIE: FOUND 1/2" IRON ROD (ADOPT) AT NE CORNER OF ROW EXCEPTION TO BK. 17760, PG. 3499 PER BK. 8455, PG. 1081 (S04°54'21"E OF CL ROAD STA. 10+00)

THIS PROJECT IS ORIENTED TO GRID NORTH DERIVED FROM GPS OBSERVATIONS OF MISSOURI GRS MONUMENT SL-194 USING MODOT'S RTK GPS NETWORK.

TOPOGRAPHIC SURVEY

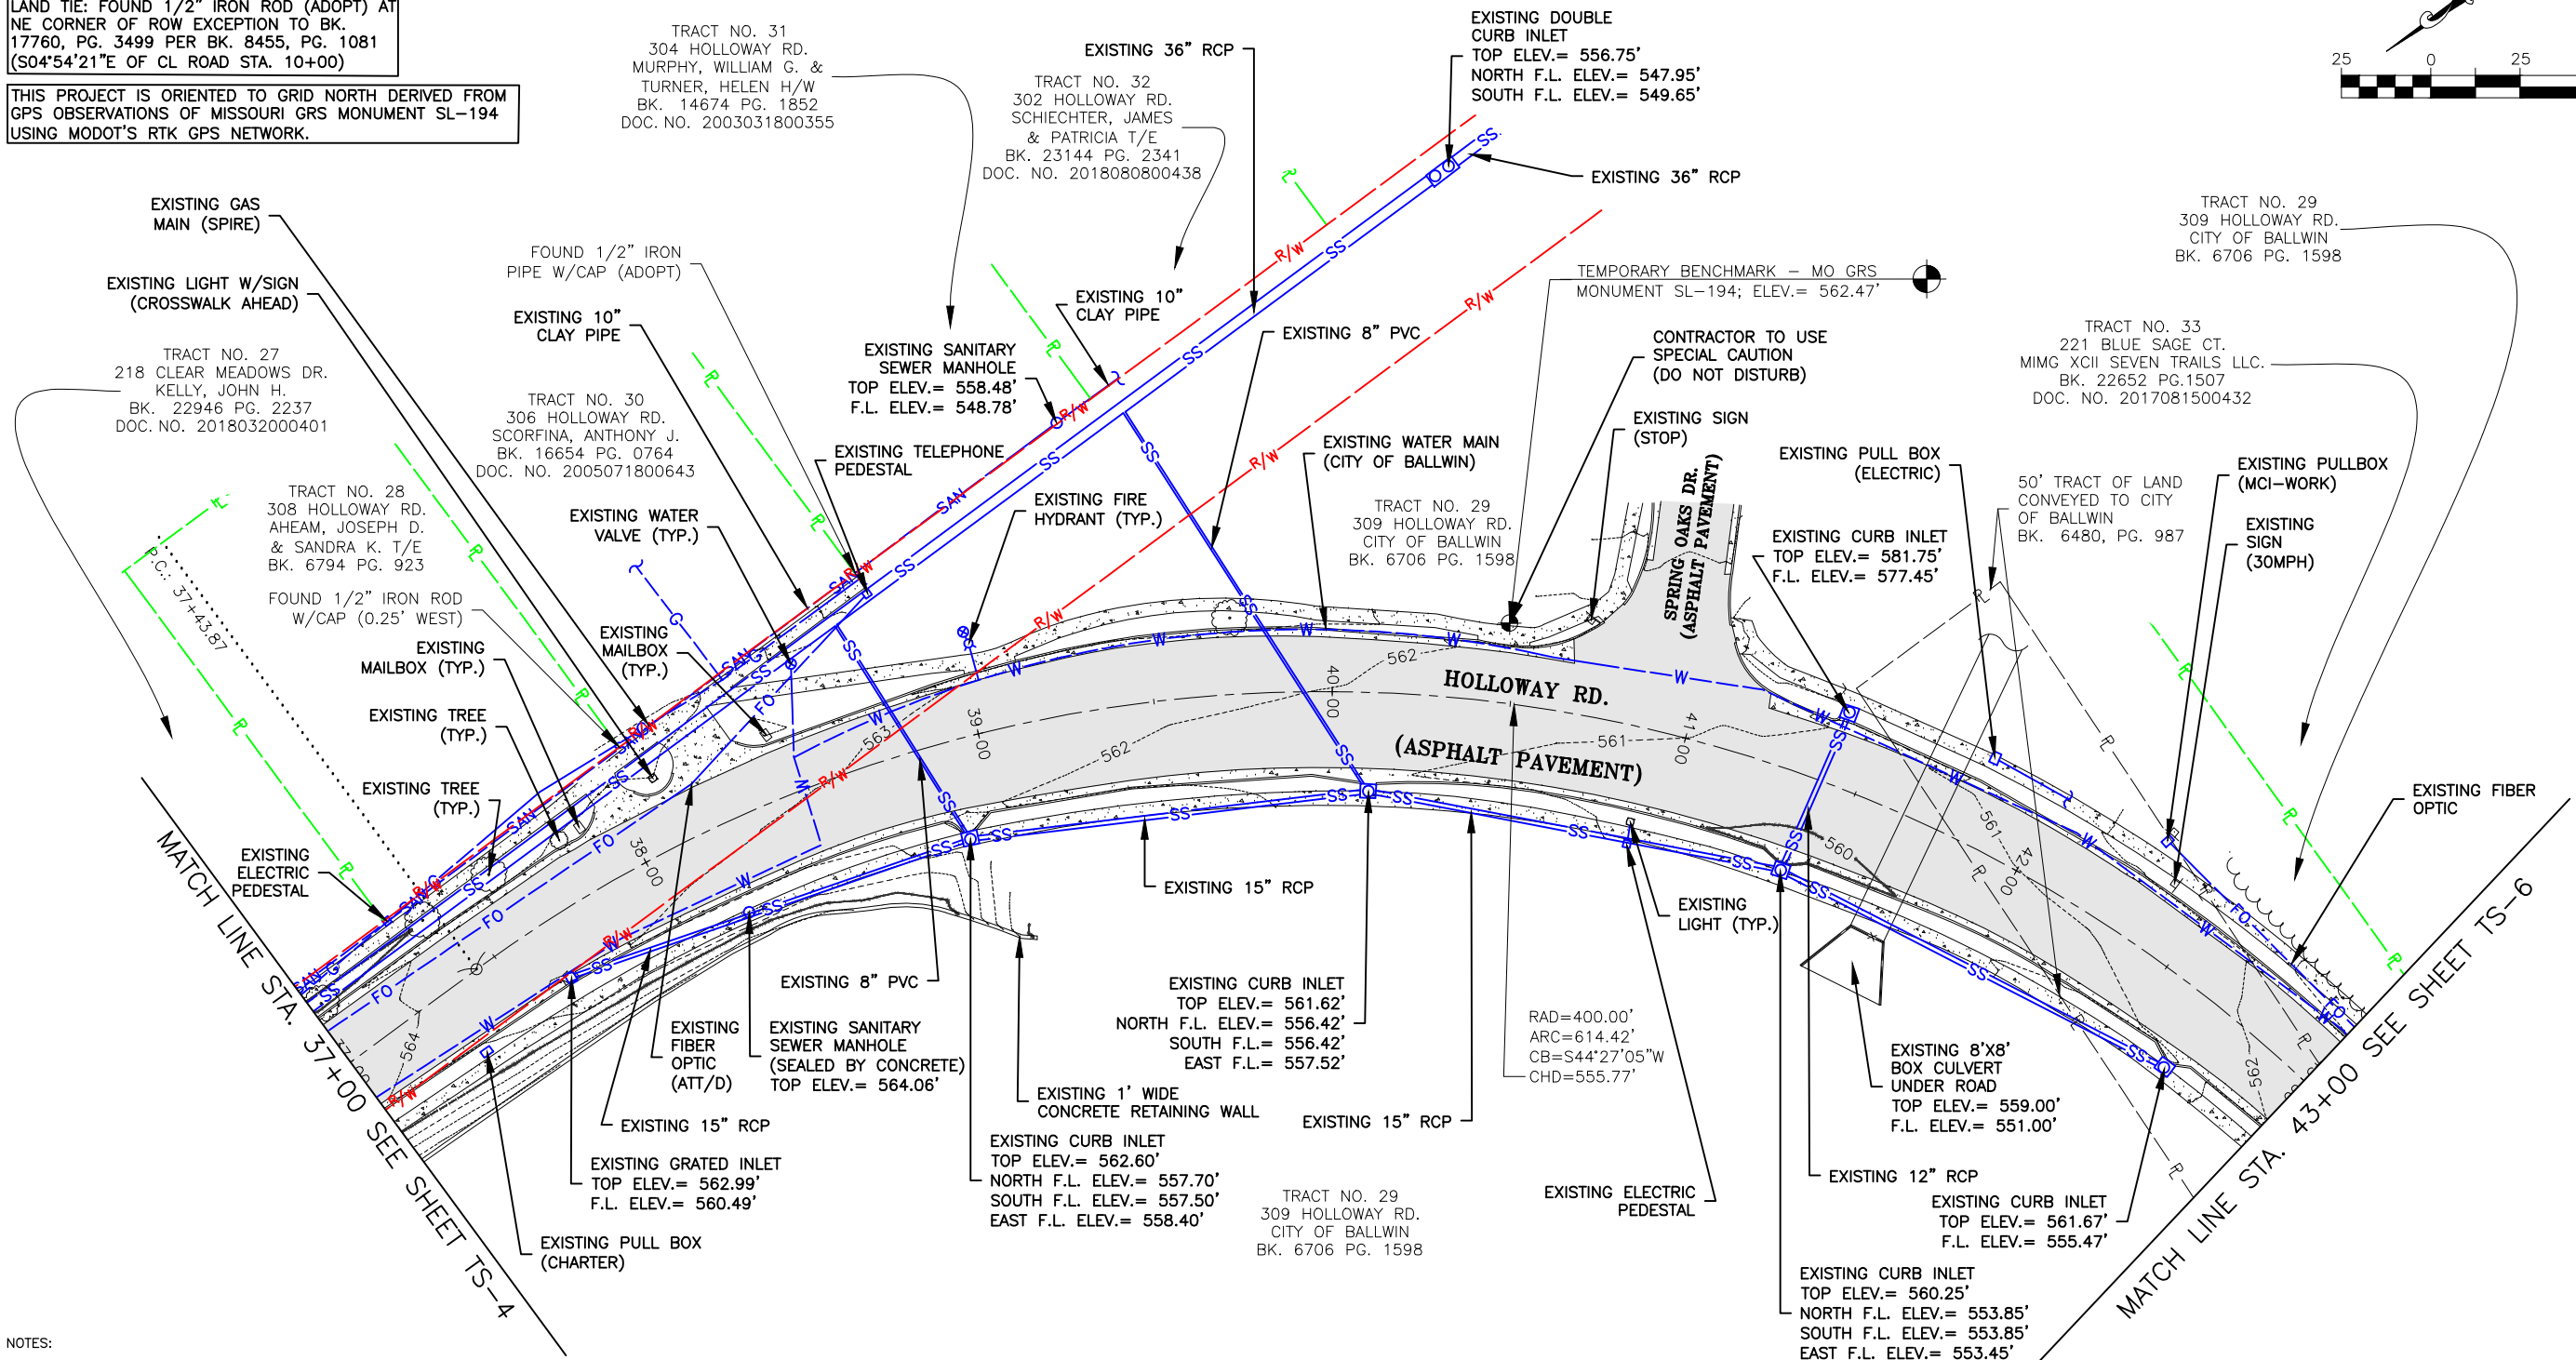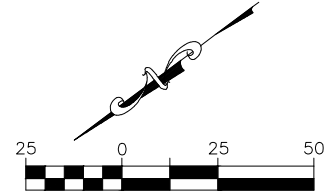

- NOTES:
- UNDERGROUND STRUCTURES, FACILITIES, AND UTILITIES HAVE BEEN PLOTTED FROM AVAILABLE SURVEYS AND RECORDS. THEREFORE, THEIR LOCATIONS MUST BE CONSIDERED APPROXIMATE ONLY. THERE MAY BE OTHERS, THE EXISTENCE OF WHICH IS PRESENTLY NOT KNOWN.
 - SITE BENCHMARK IS MISSOURI GRS MONUMENT SL-194, ELEV.= 562.47 FEET (NAVD88). TEMPORARY BENCHMARK IS MISSOURI GRS MONUMENT SL-194 ELEV.= 562.47.
 - THE CONTRACTOR IS SPECIFICALLY CAUTIONED THAT THE LOCATION AND/OR ELEVATION OF EXISTING UTILITIES AS SHOWN ON THESE PLANS IS BASED ON RECORDS OF VARIOUS UTILITY COMPANIES AND, WHERE POSSIBLE, MEASUREMENTS TAKEN IN THE FIELD. THE INFORMATION IS NOT TO BE RELIED ON AS BEING EXACT OR COMPLETE. THE CONTRACTOR SHALL FIELD VERIFY THE LOCATION AND ELEVATION OF ALL POTENTIAL UTILITY CONFLICTS PRIOR TO ORDERING MATERIALS FOR CONSTRUCTION. THE CONTRACTOR MUST CALL THE APPROPRIATE UTILITY COMPANY AT LEAST 48 HOURS BEFORE ANY EXCAVATION TO REQUEST EXACT FIELD LOCATION OF UTILITIES. LOCATION, RELOCATION AND CONNECTION OF THE UTILITIES SHALL BE COORDINATED WITH THE UTILITY COMPANIES.
 - TOPOGRAPHIC INFORMATION AS SHOWN HEREON PER FIELD WORK PERFORMED BY J.W.B., Z.B.H., AND A.M.T.B. OF COCHRAN, DATED SEPTEMBER 2019.
 - THIS PROJECT IS ORIENTED TO GRID NORTH DERIVED FROM GPS OBSERVATIONS OF MISSOURI GRS MONUMENT SL-194 USING MODOT'S RTK GPS NETWORK.
 - THIS SITE LIES ENTIRELY WITHIN "ZONE X", AREAS DETERMINED TO BE OUTSIDE THE 0.2% ANNUAL CHANCE FLOODPLAIN, AREAS OF 0.2% ANNUAL CHANCE FLOOD; AREAS OF 1% ANNUAL CHANCE FLOOD WITH AVERAGE DEPTHS OF LESS THAN 1 FOOT OR WITH DRAINAGE AREAS LESS THAN 1 SQUARE MILE PER FEMA FLOOD INSURANCE RATE MAP NUMBER 29189C0281K, EFFECTIVE DATE FEBRUARY 4, 2015.
 - THIS TOPOGRAPHIC SURVEY DOES NOT CONSTITUTE A PROPERTY BOUNDARY SURVEY.

LEGEND

PROPERTY LINE	---P---	EXISTING UTILITY POLE	-O-	EXISTING GAS VALVE	⊗
RIGHT-OF-WAY	---R/W---	EXISTING SANITARY SEWER	---SAN---	EXISTING FIRE HYDRANT	⊕
CENTERLINE OF ROAD	---	EXISTING WATER MAIN	---W---	EXISTING MAILBOX	□
EXISTING STRIPING	---	EXISTING GAS MAIN	---G---	EXISTING SIGN	⊠
EXISTING MAJOR CONTOUR	---970---	EXISTING STORM SEWER	---SS---	EXISTING FENCE	---X---
EXISTING MINOR CONTOUR	---	EXISTING UNDERGROUND TELEPHONE	---UGT---	EXISTING LIGHT	□
EXISTING BUILDING	▒	EXISTING UNDERGROUND ELECTRIC	---UGE---	EXISTING BUSH	⊗
EXISTING CONCRETE PAVEMENT	▒	EXISTING TELEPHONE PEDESTAL	□	EXISTING TREE	⊙
EXISTING GRAVEL	▒	EXISTING WATER VALVE	⊗	EXISTING UTILITY (TERMINUS UNKNOWN)	---
EXISTING ASPHALT PAVEMENT	▒	EXISTING WATER METER	⊕	EXISTING GUY WIRE	---
EXISTING AERIAL ELECTRIC	---AE---	EXISTING FIBER OPTIC	---FO---	EXISTING EDGE OF WOODS	---

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ENGINEERING CERTIFICATE OF AUTHORITY NUMBER - 2007006937
LAND SURVEYING CERTIFICATE OF AUTHORITY NUMBER - 2007004529

STATE OF MISSOURI

TIMOTHY J. VAN LEER

NUMBER PLS-200700007

1/28/21

TIMOTHY J. VAN LEER
NO. PLS-200700007
STATE OF MISSOURI
PROFESSIONAL LAND SURVEYOR
FOR SC ENGINEERING LLC,
DBA COCHRAN

THIS SHEET HAS BEEN SIGNED,
SEALED AND DATED ELECTRONICALLY

HOLLOWAY ROAD IMPROVEMENTS
FEDERAL PROJECT NO. STP-4939(608)
CITY OF BALLWIN, MISSOURI

TOPOGRAPHIC SURVEY

DATE: _____

DATE: _____

DWN. BY: Z.B.H. APPD. BY: T.J.V.

DATE: JANUARY 2021

SCALE: 1" = 50'

PROJ. NO.: SC19-981

DWG. NO.: TS-5



Drawing name: I:\SC19-981 Holloway Road, Ballwin, MO\AUTOCAD DRAWINGS\TOPOGRAPHIC SURVEY.dwg Tab: TS-5 Plotted on: Feb 09, 2021 - 10:28am Plotted by: kwolf

TOPOGRAPHIC SURVEY

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LAND TIE: FOUND 1/2" IRON ROD (ADOPT) AT NE CORNER OF ROW EXCEPTION TO BK. 17760, PG. 3499 PER BK. 8455, PG. 1081 (S04°54'21"E OF CL ROAD STA. 10+00)

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NOTES:

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- THE CONTRACTOR IS SPECIFICALLY CAUTIONED THAT THE LOCATION AND/OR ELEVATION OF EXISTING UTILITIES AS SHOWN ON THESE PLANS IS BASED ON RECORDS OF VARIOUS UTILITY COMPANIES AND, WHERE POSSIBLE, MEASUREMENTS TAKEN IN THE FIELD. THE INFORMATION IS NOT TO BE RELIED ON AS BEING EXACT OR COMPLETE. THE CONTRACTOR SHALL FIELD VERIFY THE LOCATION AND ELEVATION OF ALL POTENTIAL UTILITY CONFLICTS PRIOR TO ORDERING MATERIALS FOR CONSTRUCTION. THE CONTRACTOR MUST CALL THE APPROPRIATE UTILITY COMPANY AT LEAST 48 HOURS BEFORE ANY EXCAVATION TO REQUEST EXACT FIELD LOCATION OF UTILITIES. LOCATION, RELOCATION AND CONNECTION OF THE UTILITIES SHALL BE COORDINATED WITH THE UTILITY COMPANIES.
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LEGEND

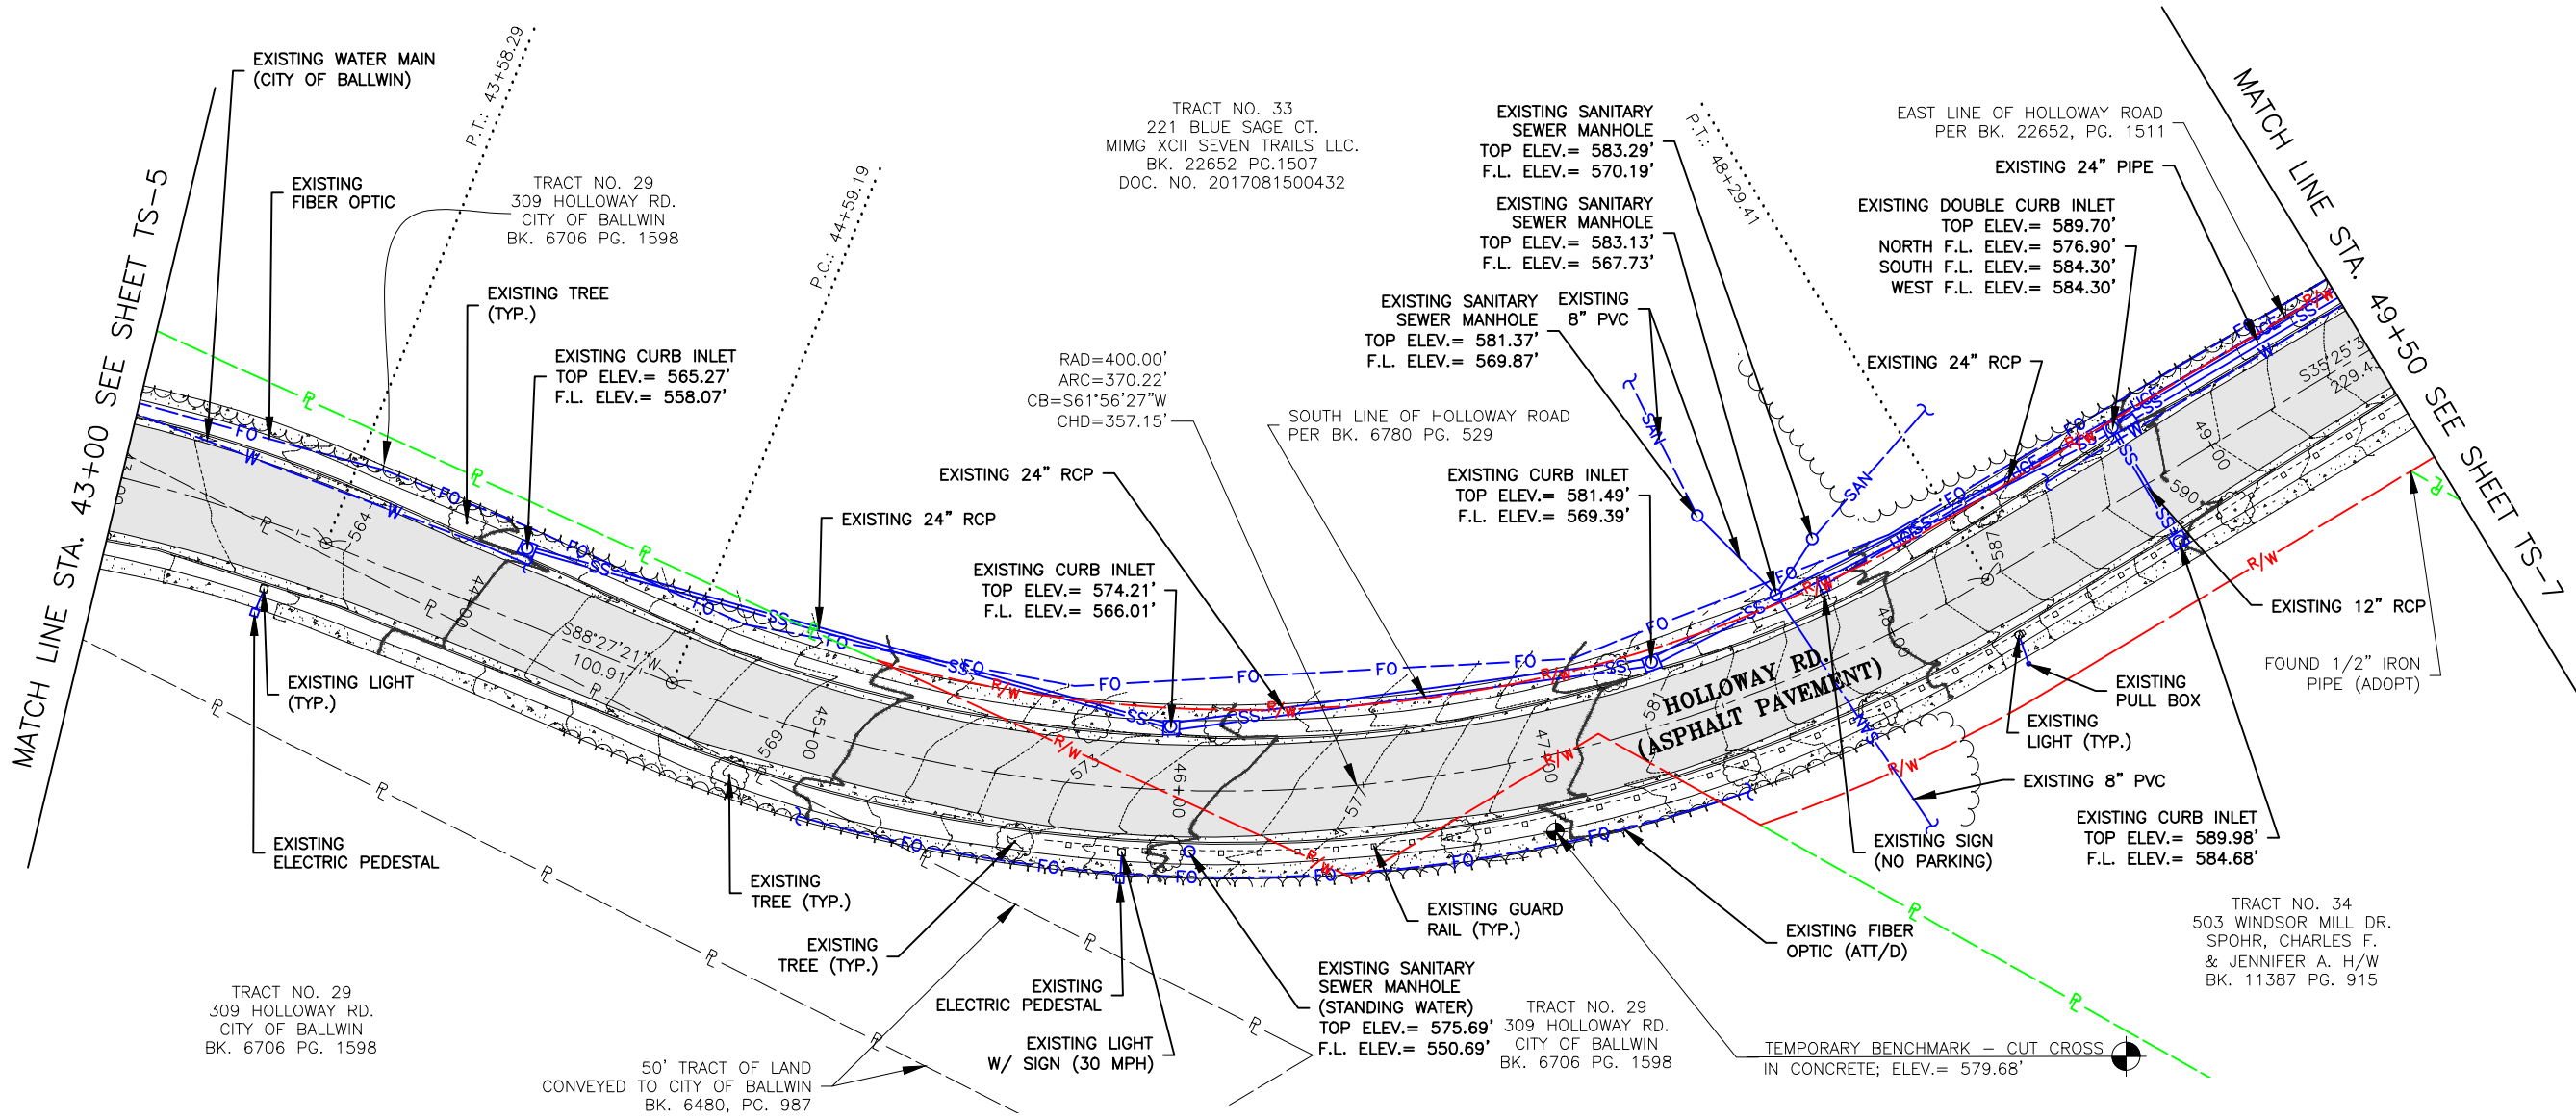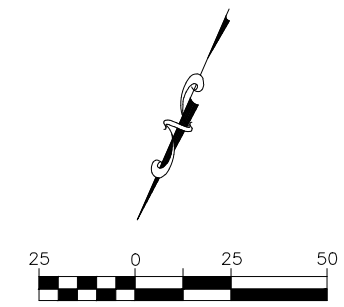PROPERTY LINE	---P---	EXISTING UTILITY POLE	⊙	EXISTING GAS VALVE	⊙
RIGHT-OF-WAY	---R/W---	EXISTING SANITARY SEWER	---SAN---	EXISTING FIRE HYDRANT	⊕
CENTERLINE OF ROAD	---CL---	EXISTING WATER MAIN	---W---	EXISTING MAILBOX	□
EXISTING STRIPING	---	EXISTING GAS MAIN	---G---	EXISTING SIGN	⊠
EXISTING MAJOR CONTOUR	---970---	EXISTING STORM SEWER	---SS---	EXISTING FENCE	---X---
EXISTING MINOR CONTOUR	---	EXISTING UNDERGROUND TELEPHONE	---UGT---	EXISTING LIGHT	⊙
EXISTING BUILDING	▒	EXISTING UNDERGROUND ELECTRIC	---UGE---	EXISTING BUSH	⊙
EXISTING CONCRETE PAVEMENT	▒	EXISTING TELEPHONE PEDESTAL	□	EXISTING TREE	⊙
EXISTING GRAVEL	▒	EXISTING WATER VALVE	⊕	EXISTING UTILITY (TERMINUS UNKNOWN)	---
EXISTING ASPHALT PAVEMENT	▒	EXISTING WATER METER	⊕	EXISTING GUY WIRE	---
EXISTING AERIAL ELECTRIC	---AE---	EXISTING FIBER OPTIC	---FO---	EXISTING EDGE OF WOODS	---

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THE PROFESSIONAL SEAL AFFIXED TO THIS SHEET APPLIES ONLY TO ITEMS ON THIS SHEET. ALL DRAWINGS OR OTHER DOCUMENTS NOT EXHIBITING THIS SEAL SHALL NOT BE CONSIDERED PREPARED BY THIS PROFESSIONAL.

HOLLOWAY ROAD IMPROVEMENTS
FEDERAL PROJECT NO. STP-4939(608)
CITY OF BALLWIN, MISSOURI

TOPOGRAPHIC SURVEY

DATE: _____

DATE: _____

DATE: JANUARY 2021

SCALE: 1" = 50'

PROJ. NO: SC19-981

DWG. NO: TS-6

DWN. BY: Z.B.H. APPD. BY: T.J.V.


Drawing name: U:\SC19-981 Holloway Road, Ballwin, MO\AUTOCAD DRAWINGS\TOPOGRAPHIC SURVEY.dwg Tab: TS-6 Plotted on: Feb 09, 2021 - 10:28am Plotted by: kwolf

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LAND TIE: FOUND 1/2" IRON ROD (ADOPT) AT NE CORNER OF ROW EXCEPTION TO BK. 17760, PG. 3499 PER BK. 8455, PG. 1081 (S04°54'21"E OF CL ROAD STA. 10+00)

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 - TEMPORARY BENCHMARK IS A CROSS CUT IN THE CONCRETE ON THE WEST SIDE OF HOLLOWAY RD. AT APPROXIMATELY STA. 51+60 AS SHOWN ABOVE, ELEV.= 607.50.
 - THE CONTRACTOR IS SPECIFICALLY CAUTIONED THAT THE LOCATION AND/OR ELEVATION OF EXISTING UTILITIES AS SHOWN ON THESE PLANS IS BASED ON RECORDS OF VARIOUS UTILITY COMPANIES AND, WHERE POSSIBLE, MEASUREMENTS TAKEN IN THE FIELD. THE INFORMATION IS NOT TO BE RELIED ON AS BEING EXACT OR COMPLETE. THE CONTRACTOR SHALL FIELD VERIFY THE LOCATION AND ELEVATION OF ALL POTENTIAL UTILITY CONFLICTS PRIOR TO ORDERING MATERIALS FOR CONSTRUCTION. THE CONTRACTOR MUST CALL THE APPROPRIATE UTILITY COMPANY AT LEAST 48 HOURS BEFORE ANY EXCAVATION TO REQUEST EXACT FIELD LOCATION OF UTILITIES. LOCATION, RELOCATION AND CONNECTION OF THE UTILITIES SHALL BE COORDINATED WITH THE UTILITY COMPANIES.
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LEGEND	
PROPERTY LINE	---P---
RIGHT-OF-WAY	---R/W---
CENTERLINE OF ROAD	---C---
EXISTING STRIPING	---S---
EXISTING MAJOR CONTOUR	---970---
EXISTING MINOR CONTOUR	---M---
EXISTING BUILDING	[Hatched Box]
EXISTING CONCRETE PAVEMENT	[Stippled Box]
EXISTING GRAVEL	[Dotted Box]
EXISTING ASPHALT PAVEMENT	[Solid Grey Box]
EXISTING AERIAL ELECTRIC	---AE---
EXISTING UTILITY POLE	⊙
EXISTING SANITARY SEWER	---SAN---
EXISTING WATER MAIN	---W---
EXISTING GAS MAIN	---G---
EXISTING STORM SEWER	---SS---
EXISTING UNDERGROUND TELEPHONE	---UGT---
EXISTING UNDERGROUND ELECTRIC	---UGE---
EXISTING TELEPHONE PEDESTAL	□
EXISTING WATER VALVE	⊗
EXISTING WATER METER	⊞
EXISTING FIBER OPTIC	---FO---
EXISTING GAS VALVE	⊙
EXISTING FIRE HYDRANT	⊕
EXISTING MAILBOX	□
EXISTING SIGN	⊠
EXISTING FENCE	---X---
EXISTING LIGHT	□
EXISTING BUSH	⊕
EXISTING TREE	⊙
EXISTING UTILITY (TERMINUS UNKNOWN)	⊞
EXISTING GUY WIRE	---
EXISTING EDGE OF WOODS	⌋

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TIMOTHY J. VAN LEER

NUMBER PLS-200700007

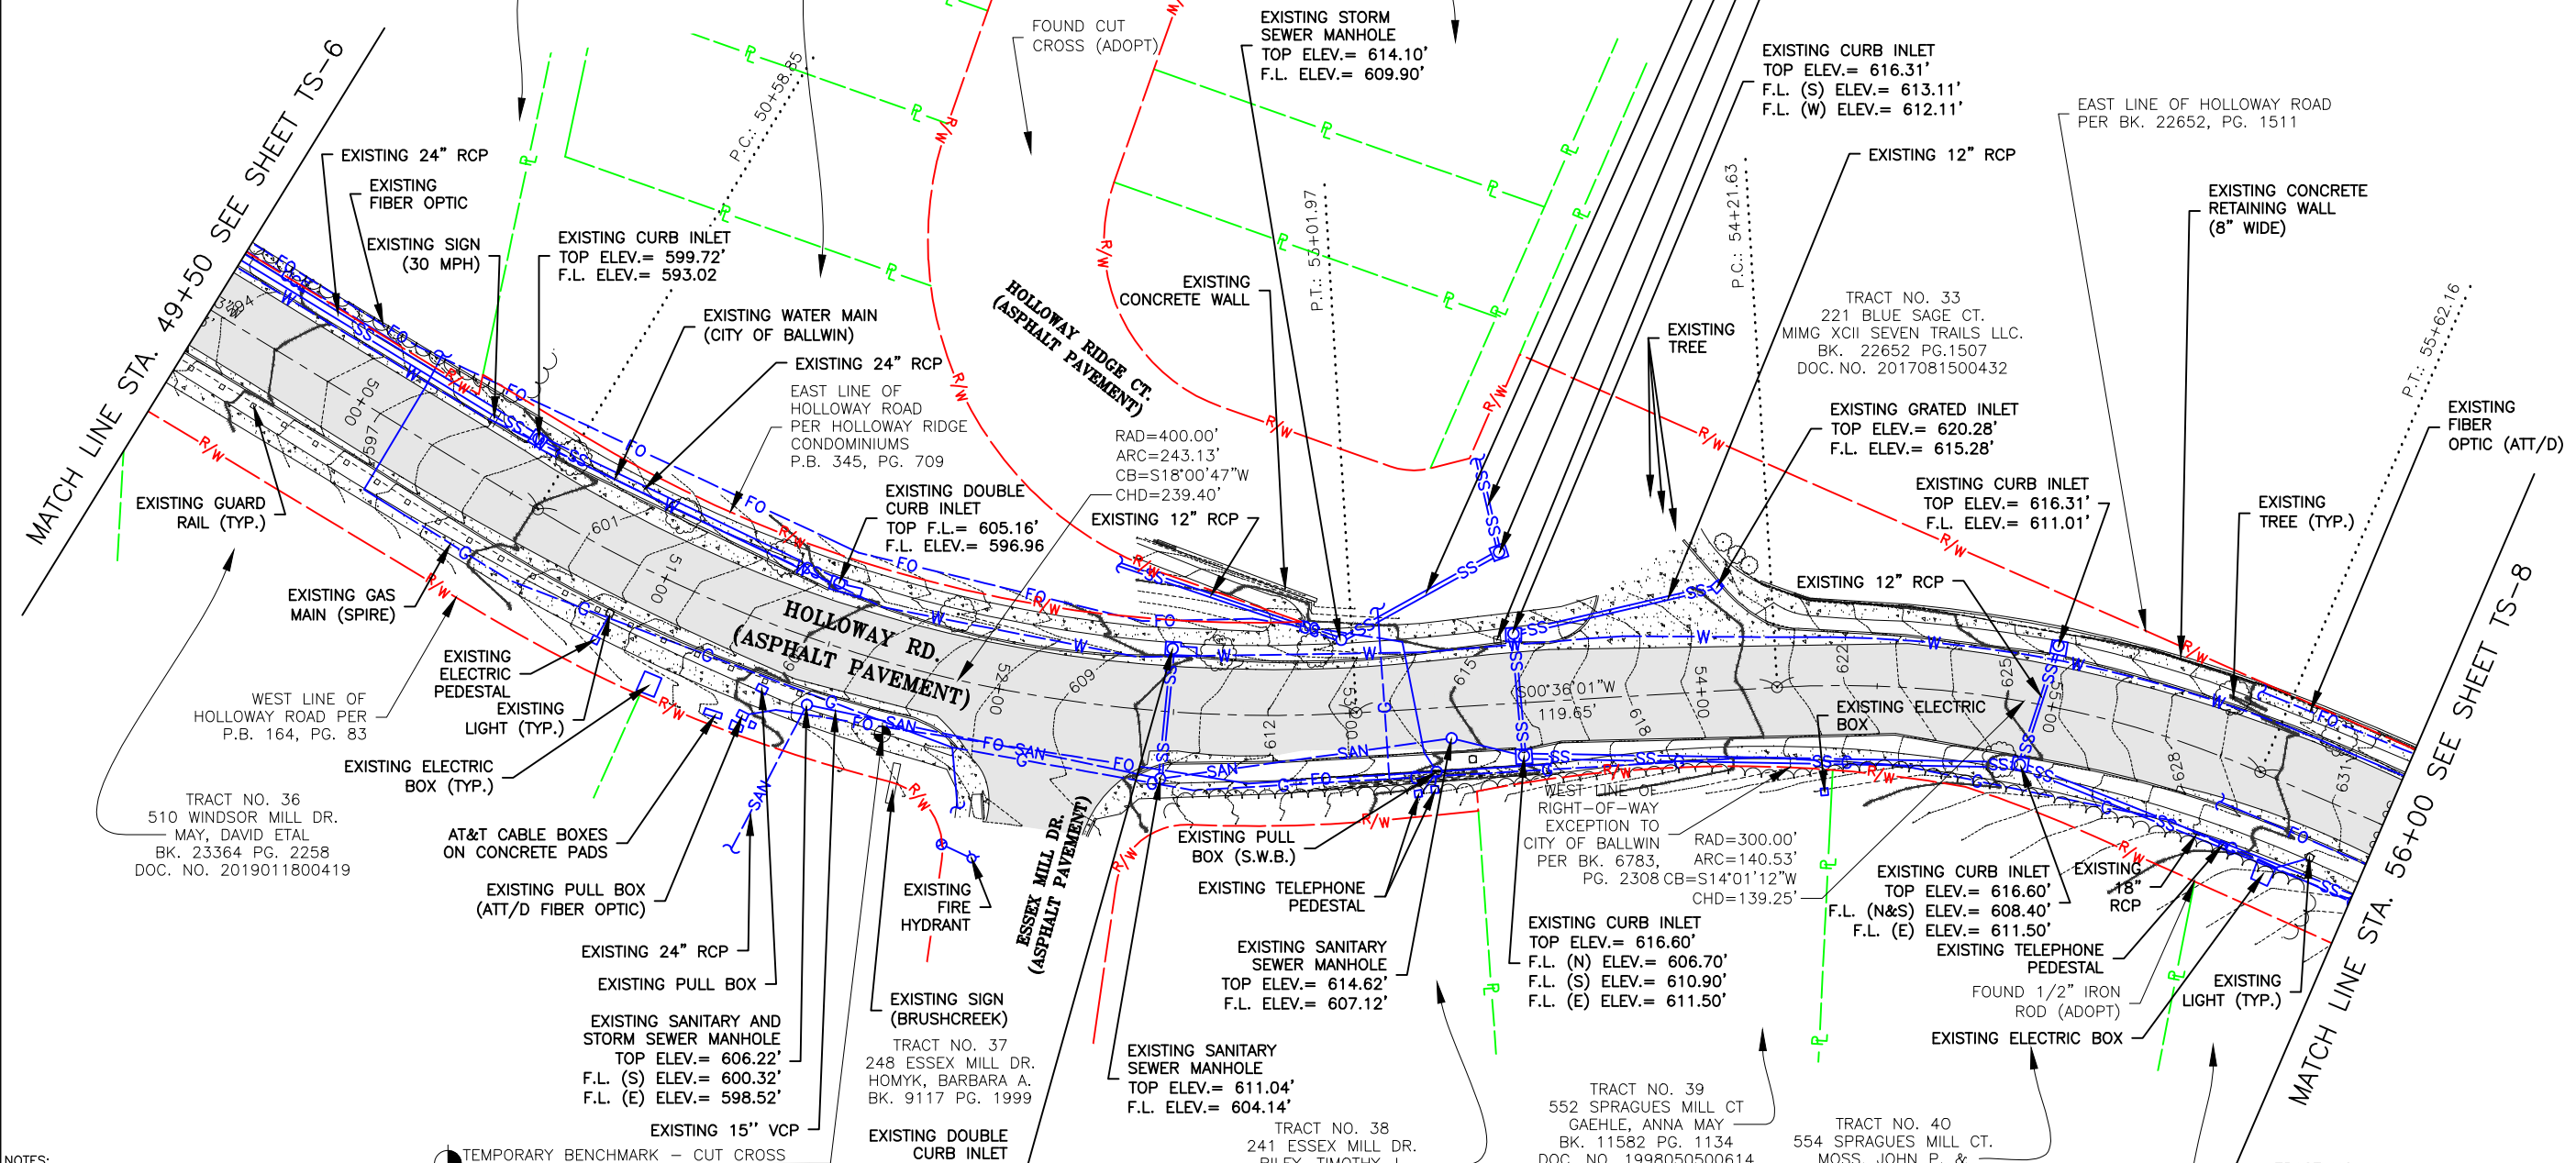1/28/21

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PROFESSIONAL LAND SURVEYOR
FOR SC ENGINEERING LLC, DBA COCHRAN

THIS SHEET HAS BEEN SIGNED, SEALED AND DATED ELECTRONICALLY.

HOLLOWAY ROAD IMPROVEMENTS
FEDERAL PROJECT NO. STP-4939(608)
CITY OF BALLWIN, MISSOURI

TOPOGRAPHIC SURVEY

DATE: _____

DATE: _____

DATE: JANUARY 2021

SCALE: 1" = 50'

PROJ. NO.: SC19-981

DWG. NO.: TS-7


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TOPOGRAPHIC SURVEY

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 - THE CONTRACTOR IS SPECIFICALLY CAUTIONED THAT THE LOCATION AND/OR ELEVATION OF EXISTING UTILITIES AS SHOWN ON THESE PLANS IS BASED ON RECORDS OF VARIOUS UTILITY COMPANIES AND, WHERE POSSIBLE, MEASUREMENTS TAKEN IN THE FIELD. THE INFORMATION IS NOT TO BE RELIED ON AS BEING EXACT OR COMPLETE. THE CONTRACTOR SHALL FIELD VERIFY THE LOCATION AND ELEVATION OF ALL POTENTIAL UTILITY CONFLICTS PRIOR TO ORDERING MATERIALS FOR CONSTRUCTION. THE CONTRACTOR MUST CALL THE APPROPRIATE UTILITY COMPANY AT LEAST 48 HOURS BEFORE ANY EXCAVATION TO REQUEST EXACT FIELD LOCATION OF UTILITIES. LOCATION, RELOCATION AND CONNECTION OF THE UTILITIES SHALL BE COORDINATED WITH THE UTILITY COMPANIES.
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LEGEND	
PROPERTY LINE	---
RIGHT-OF-WAY	---
CENTERLINE OF ROAD	---
EXISTING STRIPING	---
EXISTING MAJOR CONTOUR	---970---
EXISTING MINOR CONTOUR	---
EXISTING BUILDING	▒
EXISTING CONCRETE PAVEMENT	▒
EXISTING GRAVEL	▒
EXISTING ASPHALT PAVEMENT	▒
EXISTING AERIAL ELECTRIC	---AE---
EXISTING UTILITY POLE	⊙
EXISTING SANITARY SEWER	---SAN---
EXISTING WATER MAIN	---W---
EXISTING GAS MAIN	---G---
EXISTING STORM SEWER	---SS---
EXISTING UNDERGROUND TELEPHONE	---UGT---
EXISTING UNDERGROUND ELECTRIC	---UGE---
EXISTING TELEPHONE PEDESTAL	□
EXISTING WATER VALVE	⊗
EXISTING WATER METER	⊕
EXISTING FIBER OPTIC	---FO---
EXISTING GAS VALVE	⊙
EXISTING FIRE HYDRANT	⊕
EXISTING MAILBOX	□
EXISTING SIGN	⊕
EXISTING FENCE	---X---
EXISTING LIGHT	⊕
EXISTING BUSH	⊕
EXISTING TREE	⊕
EXISTING UTILITY (TERMINUS UNKNOWN)	---
EXISTING GUY WIRE	---
EXISTING EDGE OF WOODS	---

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CITY OF BALLWIN, MISSOURI

TOPOGRAPHIC SURVEY

DATE: 1/28/21

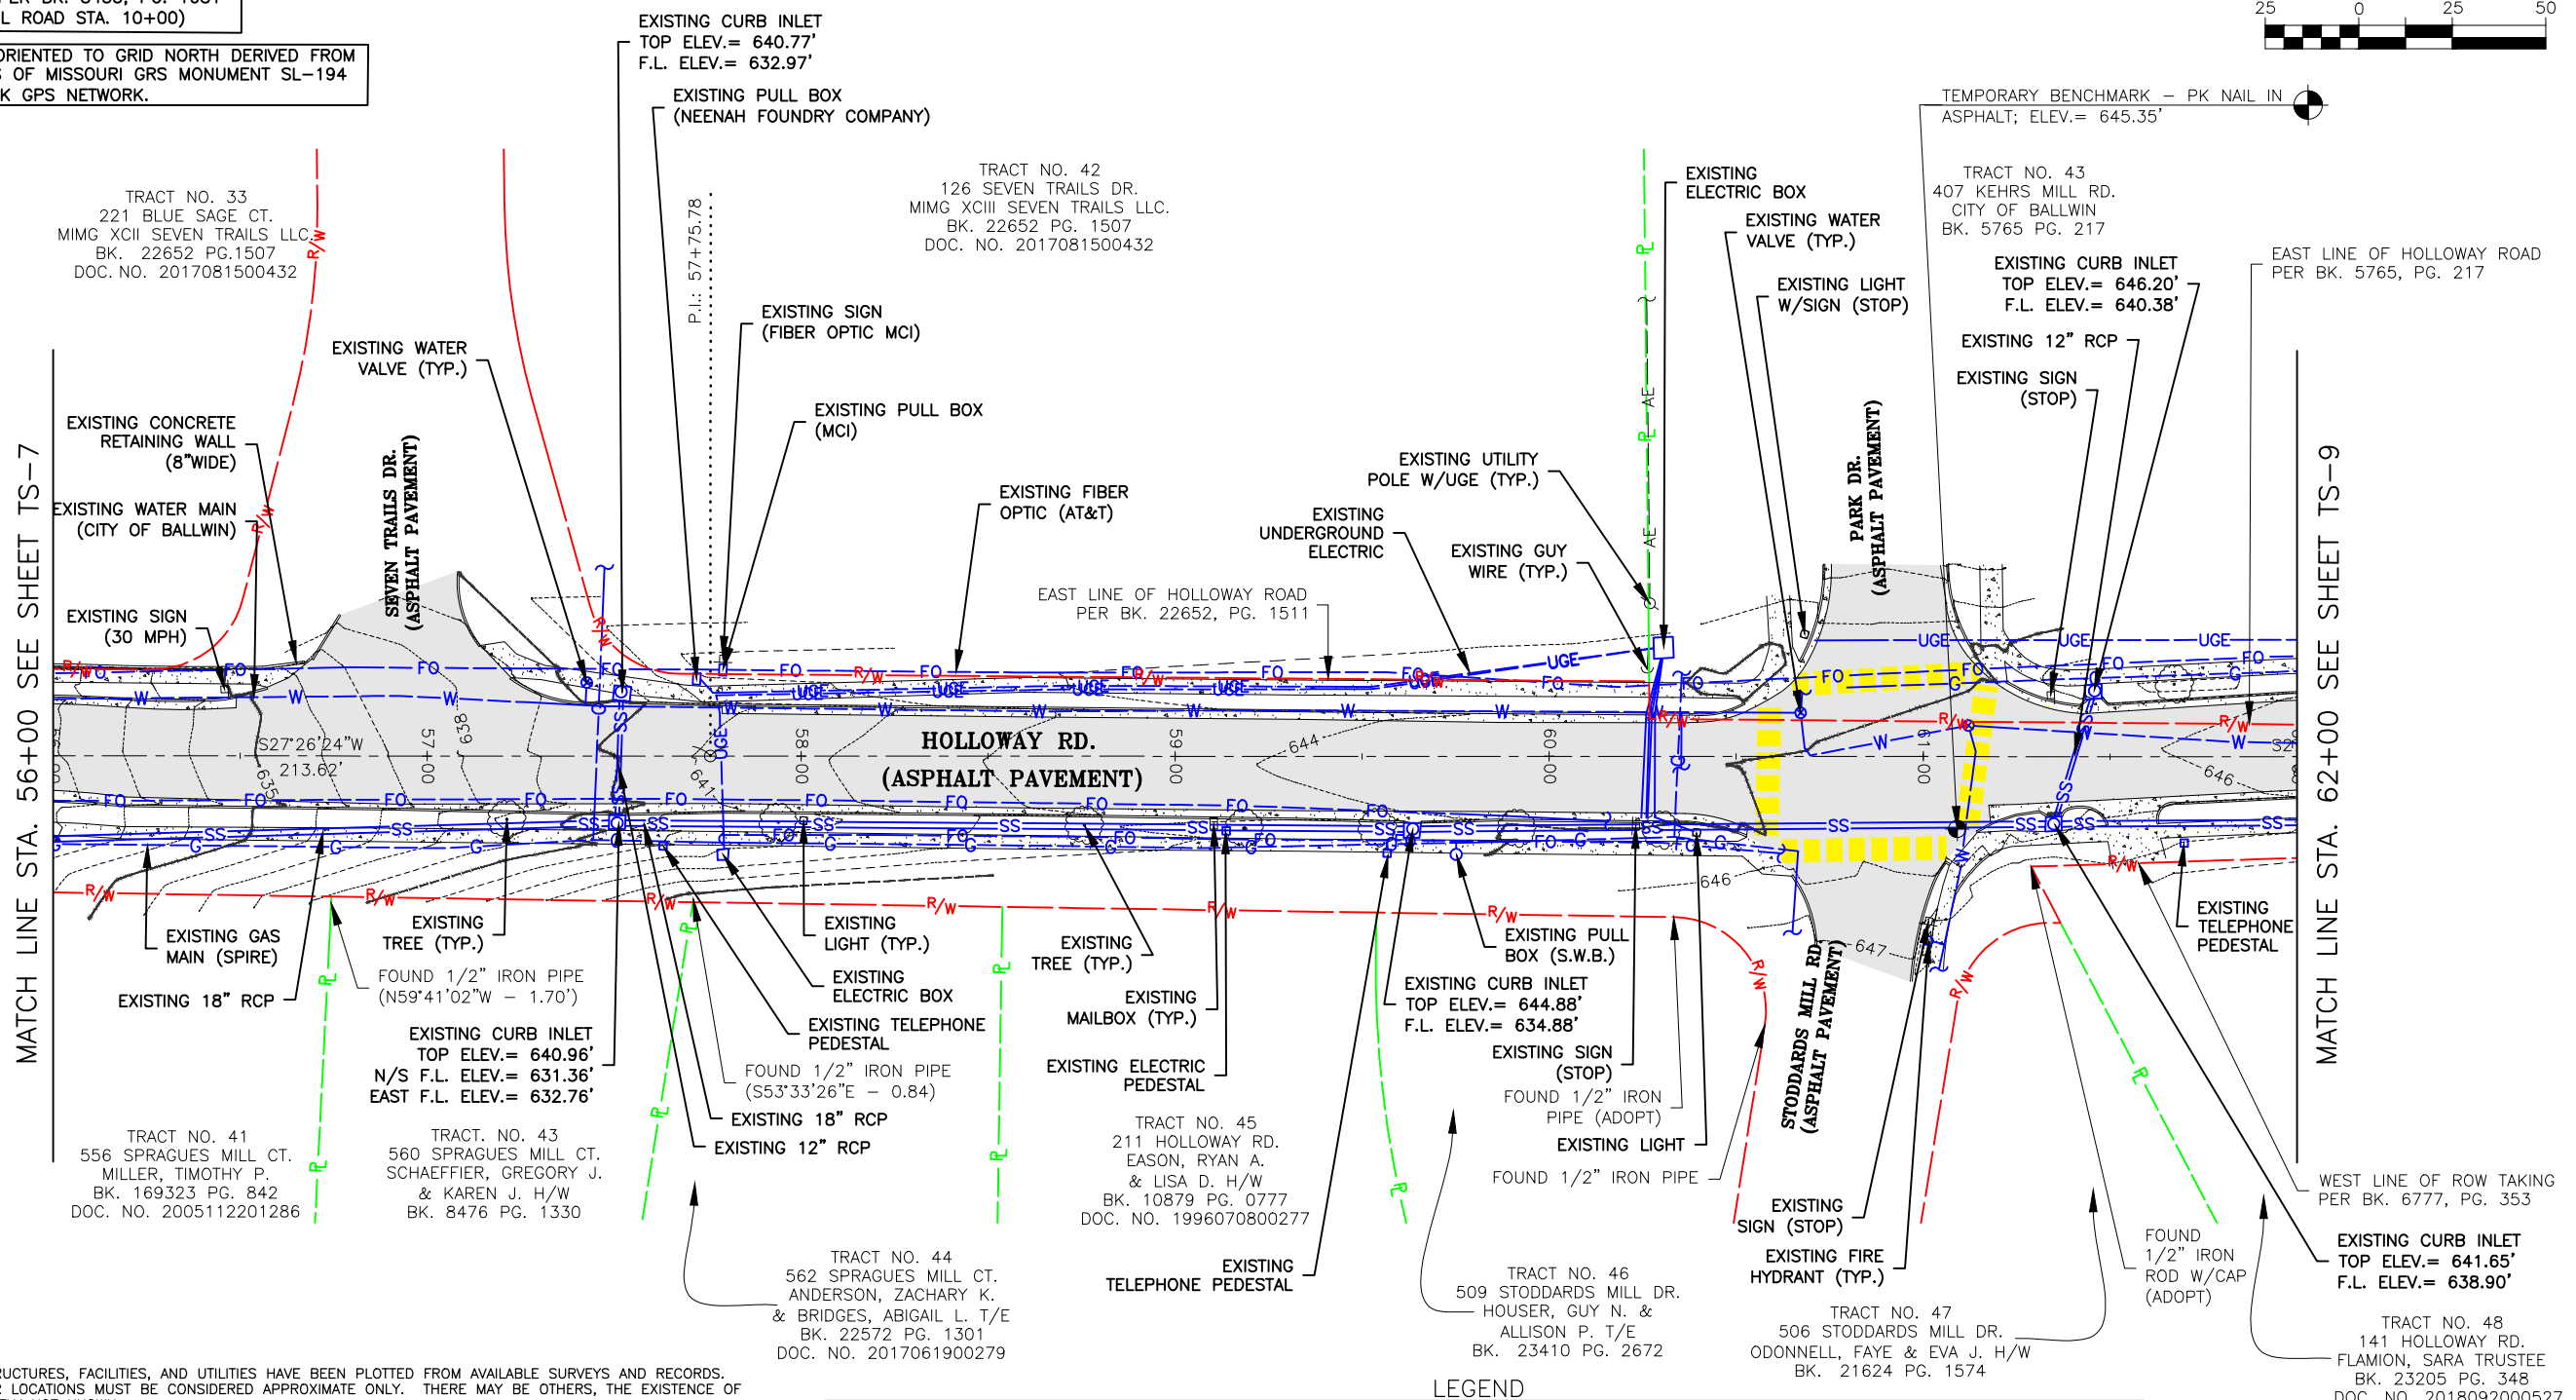DATE: 1/28/21

SCALE: 1" = 50'

PROJ. NO.: SC19-981

DWG. NO.: TS-8

Drawing name: U:\SC19-981 Holloway Road, Ballwin, MO\AUTOCAD DRAWINGS\TOPOGRAPHIC SURVEY.dwg Tab: TS-8 Plotted on: Feb 09, 2021 - 10:28am Plotted by: kweliff


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TRACT NO. 52
118 N. HOLLOWAY RD.
STAFFORD, CAROLE L.
TRUSTEE
BK. 17610 PG. 4835
DOC. NO. 2007071200738



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LEGEND			
PROPERTY LINE	---P---	EXISTING UTILITY POLE	⊙
RIGHT-OF-WAY	---R/W---	EXISTING SANITARY SEWER	---SAN---
CENTERLINE OF ROAD	---	EXISTING WATER MAIN	---W---
EXISTING STRIPING	---	EXISTING GAS MAIN	---G---
EXISTING MAJOR CONTOUR	---970---	EXISTING STORM SEWER	---SS---
EXISTING MINOR CONTOUR	---	EXISTING UNDERGROUND TELEPHONE	---UGT---
EXISTING BUILDING	▒▒▒	EXISTING UNDERGROUND ELECTRIC	---UGE---
EXISTING CONCRETE PAVEMENT	▒▒▒	EXISTING TELEPHONE PEDESTAL	□
EXISTING GRAVEL	▒▒▒	EXISTING WATER VALVE	⊗
EXISTING ASPHALT PAVEMENT	▒▒▒	EXISTING WATER METER	⊕
EXISTING AERIAL ELECTRIC	---AE---	EXISTING FIBER OPTIC	---FO---
		EXISTING GAS VALVE	⊙
		EXISTING FIRE HYDRANT	⊕
		EXISTING MAILBOX	□
		EXISTING SIGN	▒
		EXISTING FENCE	---X---
		EXISTING LIGHT	⊙
		EXISTING BUSH	⊕
		EXISTING TREE	⊕
		EXISTING UTILITY (TERMINUS UNKNOWN)	⌋
		EXISTING GUY WIRE	---
		EXISTING EDGE OF WOODS	⌋

314-842-4033 (tel.)
314-842-5957 (fax)
www.cochraneng.com

737 RUBBER ROAD
FENTON, MISSOURI 65026

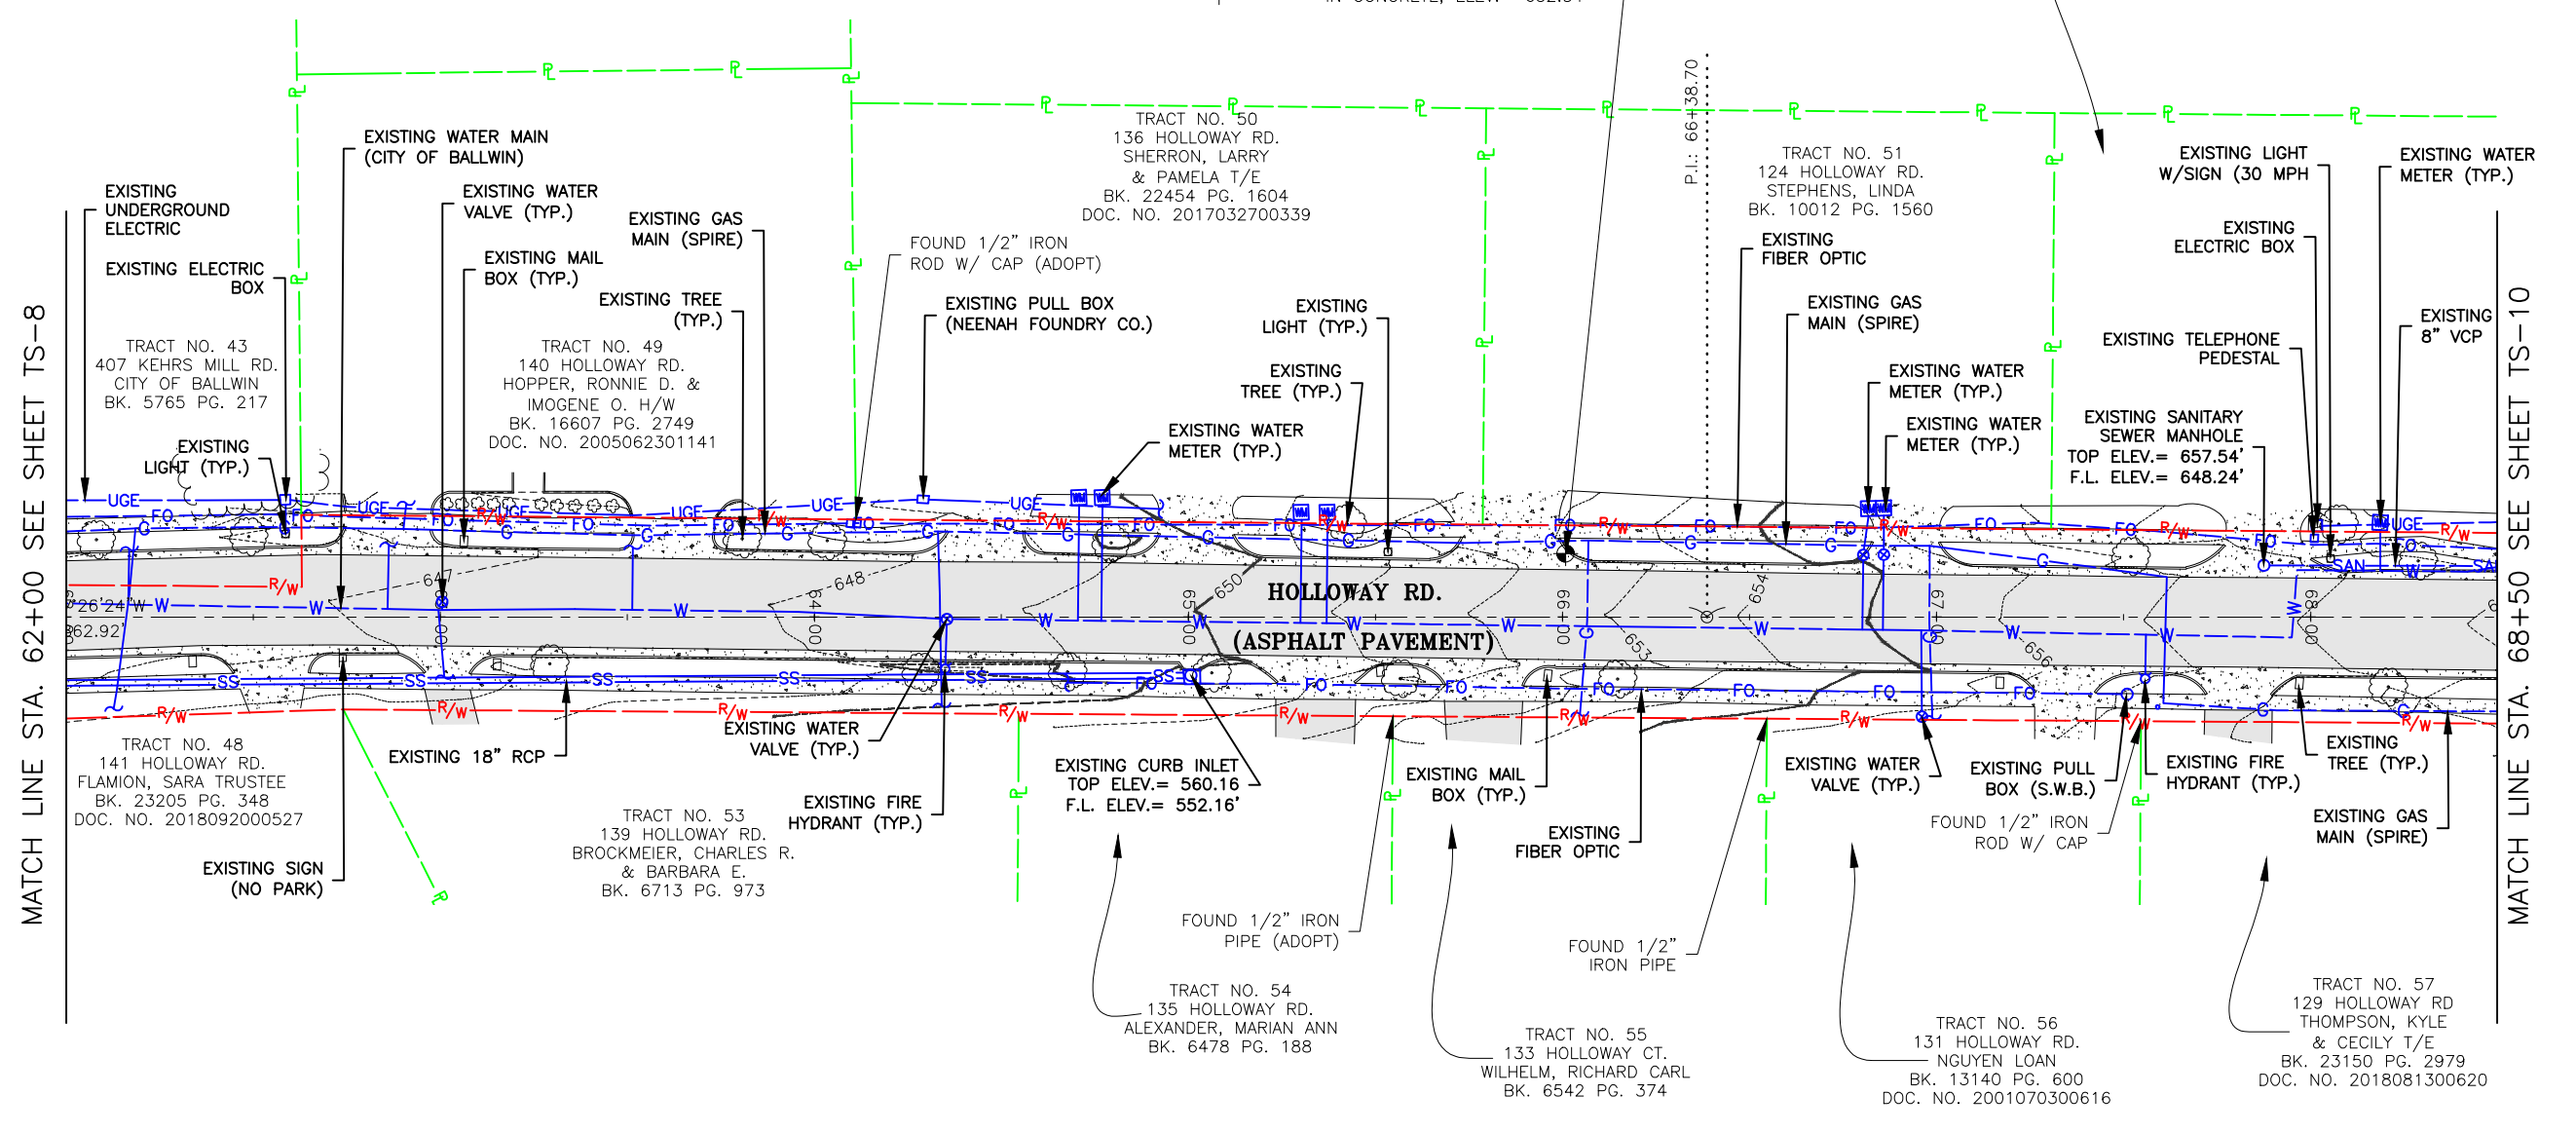COCHRAN

Civil Engineering
Land Surveying
Architecture
Site Development
Master Planning
General Consulting

ENGINEERING CERTIFICATE OF AUTHORITY NUMBER - 2007004529
LAND SURVEYING CERTIFICATE OF AUTHORITY NUMBER - 2007004529

STATE OF MISSOURI

TIMOTHY J. VAN LEER

NUMBER PLS-200700007

1/28/21

TIMOTHY J. VAN LEER
NO. PLS-200700007
STATE OF MISSOURI
PROFESSIONAL LAND SURVEYOR
FOR SC ENGINEERING LLC,
DBA COCHRAN

THIS SHEET HAS BEEN SIGNED,
SEALED AND DATED ELECTRONICALLY.

HOLLOWAY ROAD IMPROVEMENTS
FEDERAL PROJECT NO. STP-4939(608)
CITY OF BALLWIN, MISSOURI

TOPOGRAPHIC SURVEY

DATE: _____

DATE: _____

DATE: JANUARY 2021

SCALE: 1" = 50'

PROJ. NO.: SC19-981

DWG. NO.: TS-9

DWN. BY: Z.B.H. APPD. BY: T.J.V.


Drawing name: U:\SC19-981 Holloway Road, Ballwin, MO\AUTOCAD DRAWINGS\TOPOGRAPHIC SURVEY.dwg Tab: TS-9 Plotted on: Feb 09, 2021 - 10:28am Plotted by: kwolf

THIS SITE LIES WITHIN SEC 26 AND SEC 35, AND USS 1908, T45N, R4E

LAND TIE: FOUND 1/2" IRON ROD (ADOPT) AT NE CORNER OF ROW EXCEPTION TO BK. 17760, PG. 3499 PER BK. 8455, PG. 1081 (S04°54'21"E OF CL ROAD STA. 10+00)

THIS PROJECT IS ORIENTED TO GRID NORTH DERIVED FROM GPS OBSERVATIONS OF MISSOURI GRS MONUMENT SL-194 USING MODOT'S RTK GPS NETWORK.

TOPOGRAPHIC SURVEY

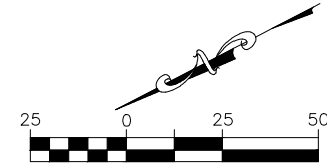

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314-842-5957 (fax)
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General Consulting

ENGINEERING CERTIFICATE OF AUTHORITY NUMBER - 2007006937
LAND SURVEYING CERTIFICATE OF AUTHORITY NUMBER - 2007004529

STATE OF MISSOURI

TIMOTHY J. VAN LEER

NUMBER PLS-200700007

1/28/21

TIMOTHY J. VAN LEER
NO. PLS-200700007
STATE OF MISSOURI
PROFESSIONAL LAND SURVEYOR
FOR SC ENGINEERING LLC,
DBA COCHRAN


THIS SHEET HAS BEEN SIGNED,
SEALED AND DATED ELECTRONICALLY.

THE PROFESSIONAL'S SEAL AFFIXED TO THIS SHEET APPLIES ONLY TO ITEMS ON THIS SHEET. ALL DRAWINGS OR OTHER DOCUMENTS NOT EXHIBITING THIS SEAL SHALL NOT BE CONSIDERED PREPARED BY THIS PROFESSIONAL.

HOLLOWAY ROAD IMPROVEMENTS
FEDERAL PROJECT NO. STP-4939(608)
CITY OF BALLWIN, MISSOURI

TOPOGRAPHIC SURVEY

DATE:	REVISION:
DWN. BY:	APPD. BY:
Z.B.H.	T.J.V.
DATE:	JANUARY 2021
SCALE:	1" = 50'
PROJ. NO.:	SC19-981
DWG. NO.:	TS-10

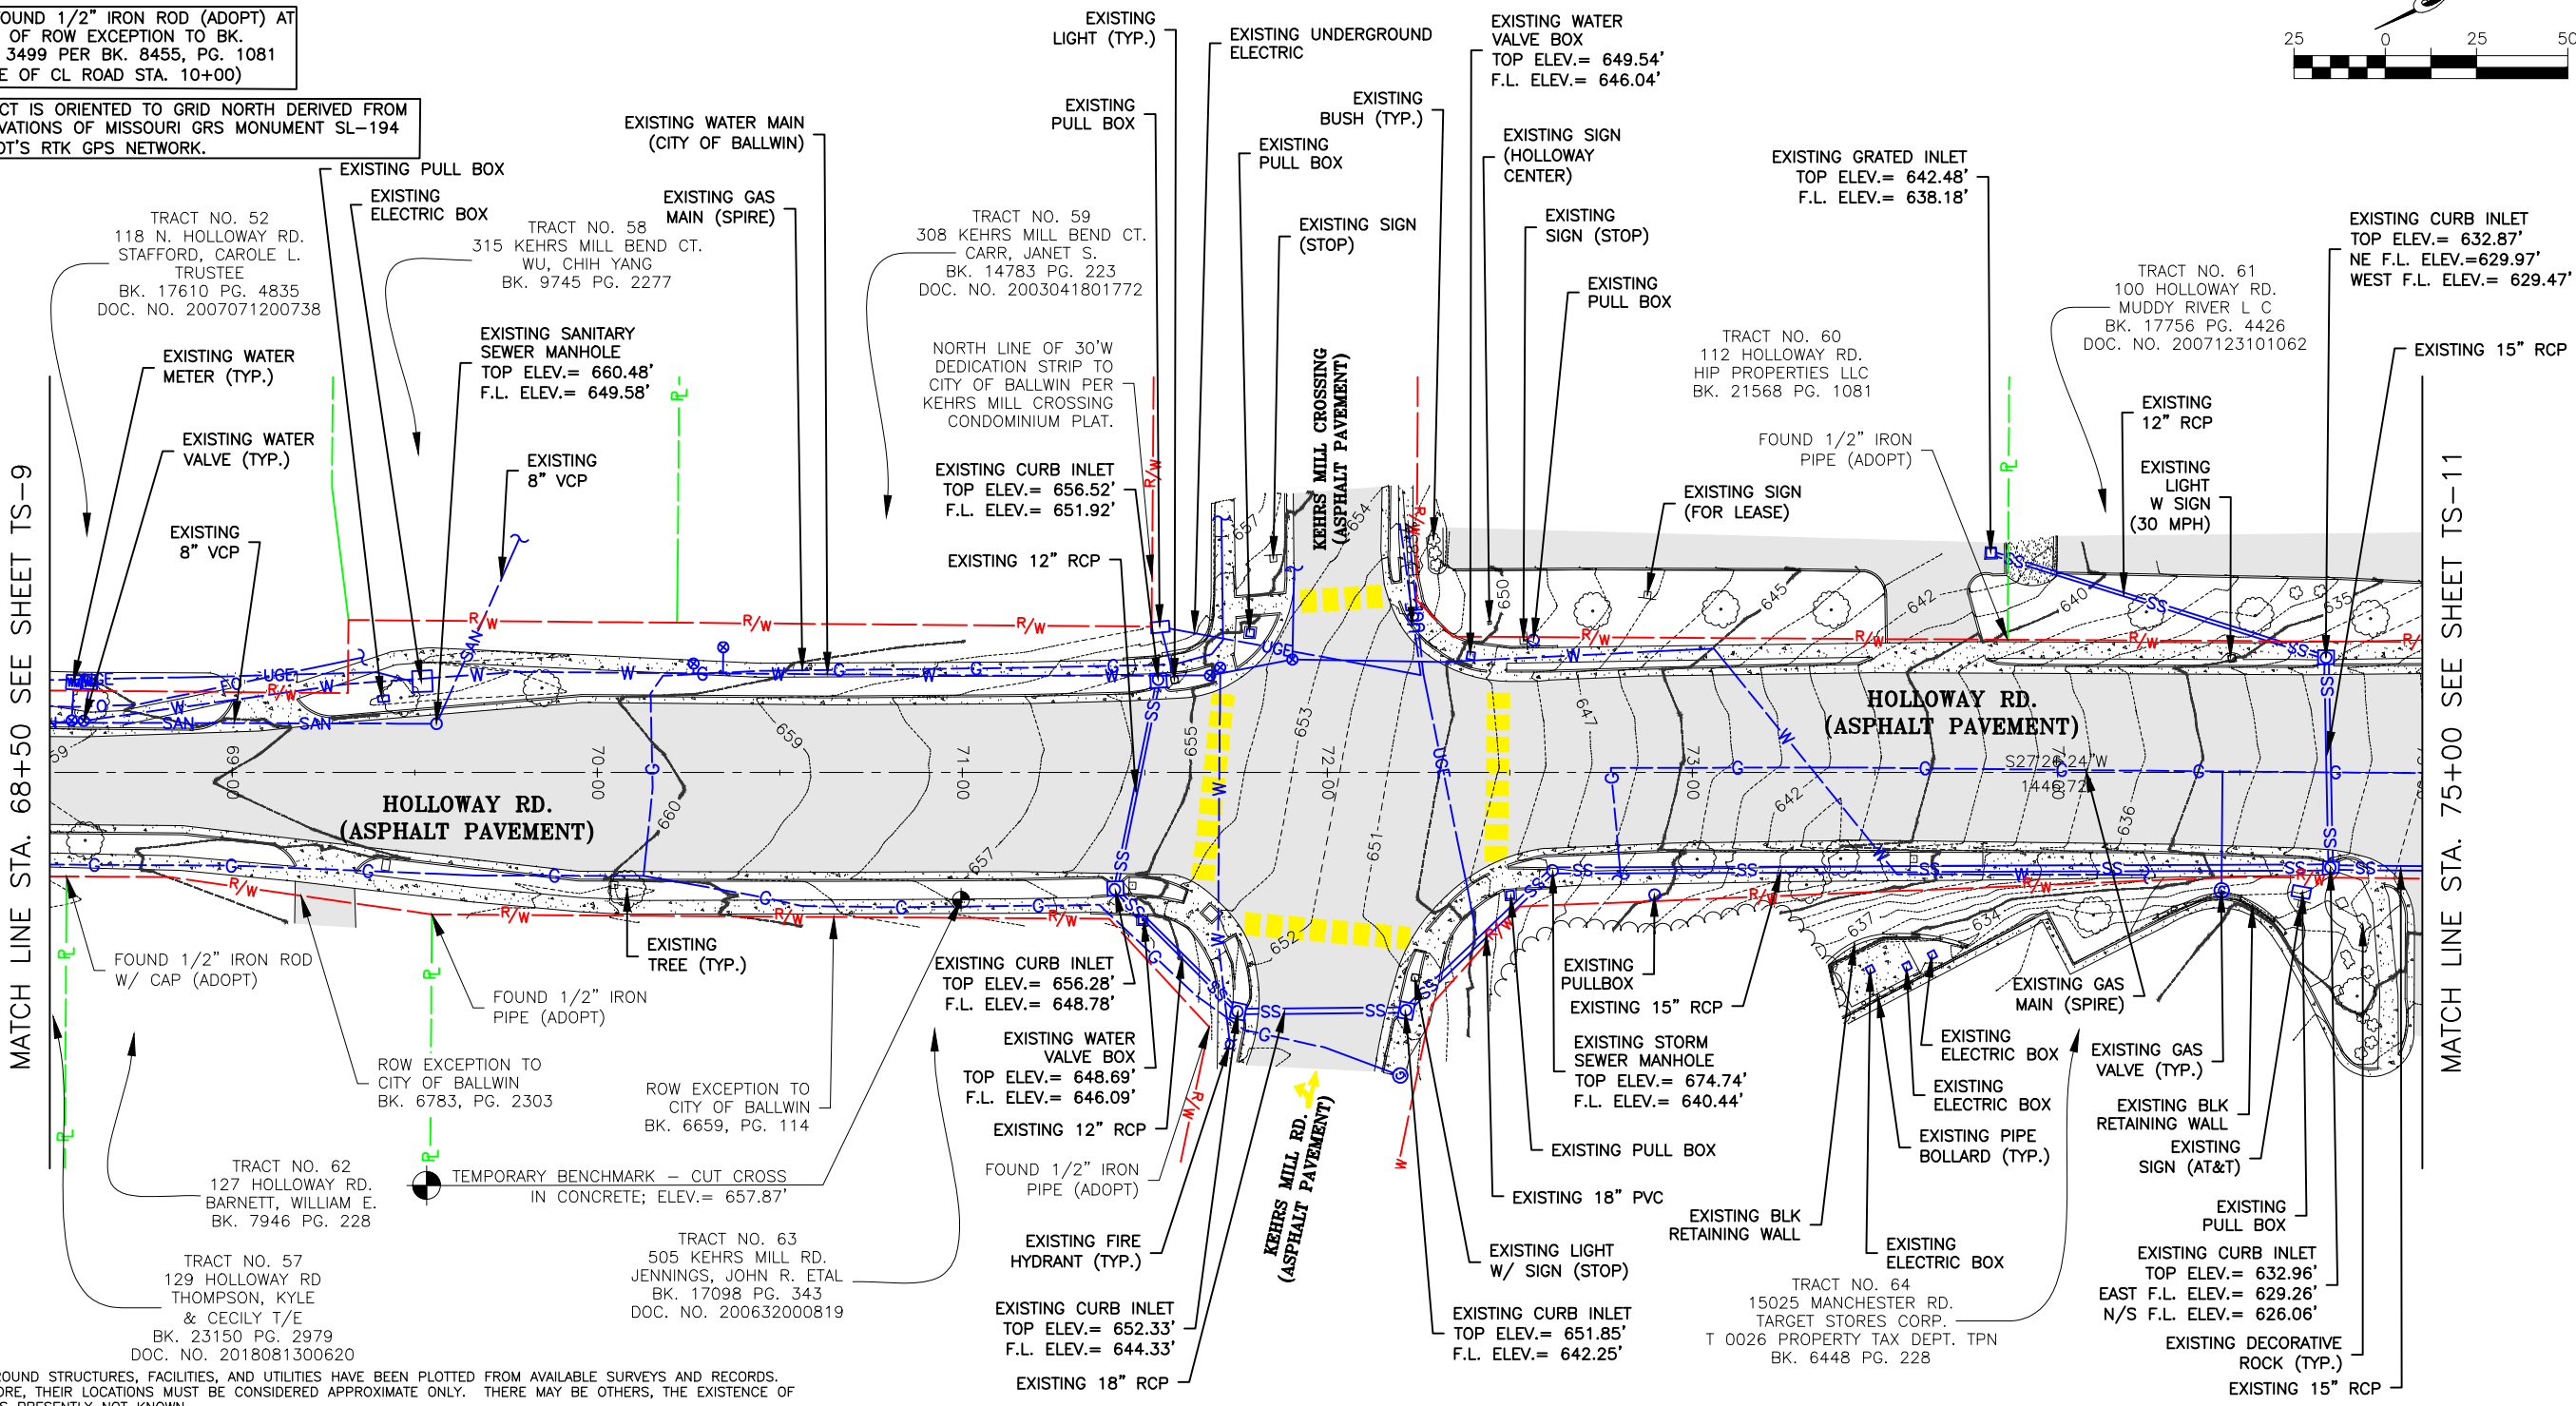

- NOTES:
- UNDERGROUND STRUCTURES, FACILITIES, AND UTILITIES HAVE BEEN PLOTTED FROM AVAILABLE SURVEYS AND RECORDS. THEREFORE, THEIR LOCATIONS MUST BE CONSIDERED APPROXIMATE ONLY. THERE MAY BE OTHERS, THE EXISTENCE OF WHICH IS PRESENTLY NOT KNOWN.
 - SITE BENCHMARK IS MISSOURI GRS MONUMENT SL-194, ELEV.= 562.47 FEET (NAVD88). TEMPORARY BENCHMARK IS A CROSS CUT IN THE CONCRETE ON THE WEST SIDE OF HOLLOWAY RD. AT APPROXIMATELY STA. 70+90 AS SHOWN ABOVE, ELEV.= 657.87.
 - THE CONTRACTOR IS SPECIFICALLY CAUTIONED THAT THE LOCATION AND/OR ELEVATION OF EXISTING UTILITIES AS SHOWN ON THESE PLANS IS BASED ON RECORDS OF VARIOUS UTILITY COMPANIES AND, WHERE POSSIBLE, MEASUREMENTS TAKEN IN THE FIELD. THE INFORMATION IS NOT TO BE RELIED ON AS BEING EXACT OR COMPLETE. THE CONTRACTOR SHALL FIELD VERIFY THE LOCATION AND ELEVATION OF ALL POTENTIAL UTILITY CONFLICTS PRIOR TO ORDERING MATERIALS FOR CONSTRUCTION. THE CONTRACTOR MUST CALL THE APPROPRIATE UTILITY COMPANY AT LEAST 48 HOURS BEFORE ANY EXCAVATION TO REQUEST EXACT FIELD LOCATION OF UTILITIES. LOCATION, RELOCATION AND CONNECTION OF THE UTILITIES SHALL BE COORDINATED WITH THE UTILITY COMPANIES.
 - TOPOGRAPHIC INFORMATION AS SHOWN HEREON PER FIELD WORK PERFORMED BY J.W.B., Z.B.H., AND A.M.T.B. OF COCHRAN, DATED SEPTEMBER 2019.
 - THIS PROJECT IS ORIENTED TO GRID NORTH DERIVED FROM GPS OBSERVATIONS OF MISSOURI GRS MONUMENT SL-194 USING MODOT'S RTK GPS NETWORK.
 - THIS SITE LIES WITHIN "ZONE X", AREAS DETERMINED TO BE OUTSIDE THE 0.2% ANNUAL CHANCE FLOODPLAIN, AREAS OF 0.2% ANNUAL CHANCE FLOOD; AREAS OF 1% ANNUAL CHANCE FLOOD WITH AVERAGE DEPTHS OF LESS THAN 1 FOOT OR WITH DRAINAGE AREAS LESS THAN 1 SQUARE MILE PER FEMA FLOOD INSURANCE RATE MAP NUMBER 29189C0281K, EFFECTIVE DATE FEBRUARY 4, 2015.
 - THIS TOPOGRAPHIC SURVEY DOES NOT CONSTITUTE A PROPERTY BOUNDARY SURVEY.

LEGEND

PROPERTY LINE	---R---	EXISTING UTILITY POLE	⊙	EXISTING GAS VALVE	⊙
RIGHT-OF-WAY	---R/W---	EXISTING SANITARY SEWER	---SAN---	EXISTING FIRE HYDRANT	⊕
CENTERLINE OF ROAD	---CL---	EXISTING WATER MAIN	---W---	EXISTING MAILBOX	□
EXISTING STRIPING	---S---	EXISTING GAS MAIN	---G---	EXISTING SIGN	⊠
EXISTING MAJOR CONTOUR	---970---	EXISTING STORM SEWER	---SS---	EXISTING FENCE	---X---
EXISTING MINOR CONTOUR	---M---	EXISTING UNDERGROUND TELEPHONE	---UGT---	EXISTING LIGHT	□
EXISTING BUILDING	▒	EXISTING UNDERGROUND ELECTRIC	---UGE---	EXISTING BUSH	⊙
EXISTING CONCRETE PAVEMENT	▒	EXISTING TELEPHONE PEDESTAL	□	EXISTING TREE	⊙
EXISTING GRAVEL	▒	EXISTING WATER VALVE	⊙	EXISTING UTILITY (TERMINUS UNKNOWN)	⌋
EXISTING ASPHALT PAVEMENT	▒	EXISTING WATER METER	⊕	EXISTING GUY WIRE	→
EXISTING AERIAL ELECTRIC	---AE---	EXISTING FIBER OPTIC	---FO---	EXISTING EDGE OF WOODS	⌋

Drawing name: I:\SC19-981 Holloway Road, Ballwin, MO\AUTOCAD DRAWINGS\TOPOGRAPHIC SURVEY.dwg Tab: TS-10 Plotted on: Feb 09, 2021 - 10:28am Plotted by: kwolf

THIS SITE LIES WITHIN SEC 26 AND SEC 35, AND USS 1908, T45N, R4E

LAND TIE: FOUND 1/2" IRON ROD (ADOPT) AT NE CORNER OF ROW EXCEPTION TO BK. 17760, PG. 3499 PER BK. 8455, PG. 1081 (S04°54'21"E OF CL ROAD STA. 10+00)

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NORTH LINE OF ROW CONVEYED TO CITY OF BALLWIN PER BK. 11246, PG. 1842

TRACT NO. 61
100 HOLLOWAY RD.
MUDDY RIVER L C
BK. 17756 PG. 4426
DOC. NO. 2007123101062

TRACT NO. 65
14949 MANCHESTER RD.
T C M REALTY 2 LLC
BK. 16423 PG. 89
DOC. NO. 2005031801212

EXISTING GAS MAIN (SPIRE)
EAST RIGHT-OF-WAY OF HOLLOWAY ROAD PER HOLLOWAY CENTER P.B. 195, PG. 8

EXISTING CURB INLET
TOP ELEV.= 628.74'
F.L. ELEV.= 624.24'

EXISTING 12" RCP
EXISTING WATER VALVE (TYP.)

EXISTING 12" RCP
EXISTING WATER VALVE (TYP.)

EXISTING GRATED INLET
TOP ELEV.= 621.29'
F.L. ELEV.= 616.19'

EXISTING CURB INLET
TOP ELEV.= 618.40'

EXISTING WATER VALVE (TYP.)

EXISTING 12" RCP

EXISTING 12" RCP

EXISTING 12" RCP

EXISTING 12" RCP

EXISTING 12" RCP

EXISTING 12" RCP

EXISTING 12" RCP

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EXISTING 12" RCP

EXISTING 12" RCP

EXISTING 12" RCP

TOPOGRAPHIC SURVEY

EXISTING LIGHT (TYP.)

EXISTING PULL BOX (S.W.B.)

EXISTING PULL BOX (S.W.B.)

EXISTING LIGHT (TYP.)

EXISTING WATER VALVE (TYP.)

EXISTING GRATED INLET
TOP ELEV.= 605.30'
F.L. ELEV.= 602.10'

EXISTING 12" RCP

EXISTING 12" RCP

EXISTING 12" RCP

EXISTING 12" RCP

EXISTING 12" RCP

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EXISTING 12" RCP

EXISTING 12" RCP

MANCHESTER ROAD (ASPHALT PAVEMENT)

EXISTING SIGN (LANE SPLIT)

EXISTING CONC. ISLAND

EXISTING STORM SEWER MANHOLE
TOP ELEV.= 605.57'

EXISTING UNDERGROUND ELECTRIC (TRAFFIC SENSOR)

EXISTING SANITARY SEWER MANHOLE
TOP ELEV.= 604.87'

EXISTING GAS VALVE (TYP.)

EXISTING PULLBOX (UGE)

EXISTING CONC ISLAND

EXISTING LIGHT (X WALK)

EXISTING GRATED INLET
TOP ELEV.= 603.72'

EXISTING PULL BOX (S.W.B.)

EXISTING LIGHT 3' CONC BASE (TRAFFIC SIGNAL)

EXISTING 12" RCP

EXISTING 21" RCP

EXISTING GRATED INLET
TOP ELEV.= 602.31'
F.L. ELEV.= 599.01'

EXISTING PULL BOX (SBC GLOBAL)

EXISTING PULLBOX

EXISTING TELEPHONE PEDESTAL (CHARTER)

TEMPORARY BENCHMARK - CUT CROSS IN CONCRETE; ELEV.= 605.05'

EXISTING 12" RCP

EXISTING 12" RCP

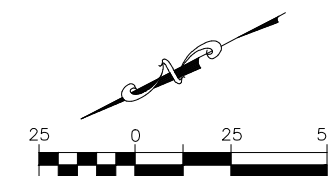

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737 RUBBER ROAD
FENTON, MISSOURI 63026

ENGINEERING CERTIFICATE OF AUTHORITY NUMBER - 2007006937
LAND SURVEYING CERTIFICATE OF AUTHORITY NUMBER - 2007004529

STATE OF MISSOURI
TIMOTHY J. VAN LEER
NUMBER PLS-200700007
1/28/21
TIMOTHY J. VAN LEER
NO. PLS-200700007
STATE OF MISSOURI
PROFESSIONAL LAND SURVEYOR
FOR SO ENGINEERING LLC, DBA COCHRAN

THIS SHEET HAS BEEN SIGNED, SEALED AND DATED ELECTRONICALLY.

HOLLOWAY ROAD IMPROVEMENTS
FEDERAL PROJECT NO. STP-4939(608)
CITY OF BALLWIN, MISSOURI

TOPOGRAPHIC SURVEY

DATE: _____
DATE: _____
DATE: _____
DATE: _____

DWN. BY: Z.B.H. APPD. BY: T.J.V.
DATE: JANUARY 2021

SCALE: 1" = 50'

PROJ. NO.: SC19-981
DWG. NO.: TS-11

MATCH LINE STA. 75+00 SEE SHEET TS-10


WEST RIGHT-OF-WAY OF HOLLOWAY ROAD PER FRANKS-BALLWIN P.B. 241, PG 64

TRACT NO. 64
15025 MANCHESTER RD.
TARGET STORES CORP.
T 0026 PROPERTY TAX DEPT. TPN
BK. 6448 PG. 228

- NOTES:
- UNDERGROUND STRUCTURES, FACILITIES, AND UTILITIES HAVE BEEN PLOTTED FROM AVAILABLE SURVEYS AND RECORDS. THEREFORE, THEIR LOCATIONS MUST BE CONSIDERED APPROXIMATE ONLY. THERE MAY BE OTHERS, THE EXISTENCE OF WHICH IS PRESENTLY NOT KNOWN.
 - SITE BENCHMARK IS MISSOURI GRS MONUMENT SL-194, ELEV.= 562.47 FEET (NAVD88). TEMPORARY BENCHMARK IS CROSS CUT IN THE CONCRETE ON THE SOUTH SIDE OF HOLLOWAY RD. AT APPROXIMATELY STA. 80+25 AS SHOWN ABOVE, ELEV.= 605.05.
 - THE CONTRACTOR IS SPECIFICALLY CAUTIONED THAT THE LOCATION AND/OR ELEVATION OF EXISTING UTILITIES AS SHOWN ON THESE PLANS IS BASED ON RECORDS OF VARIOUS UTILITY COMPANIES AND, WHERE POSSIBLE, MEASUREMENTS TAKEN IN THE FIELD. THE INFORMATION IS NOT TO BE RELIED ON AS BEING EXACT OR COMPLETE. THE CONTRACTOR SHALL FIELD VERIFY THE LOCATION AND ELEVATION OF ALL POTENTIAL UTILITY CONFLICTS PRIOR TO ORDERING MATERIALS FOR CONSTRUCTION. THE CONTRACTOR MUST CALL THE APPROPRIATE UTILITY COMPANY AT LEAST 48 HOURS BEFORE ANY EXCAVATION TO REQUEST EXACT FIELD LOCATION OF UTILITIES. LOCATION, RELOCATION AND CONNECTION OF THE UTILITIES SHALL BE COORDINATED WITH THE UTILITY COMPANIES.
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 - THIS TOPOGRAPHIC SURVEY DOES NOT CONSTITUTE A PROPERTY BOUNDARY SURVEY.

LEGEND	
PROPERTY LINE	---R---
RIGHT-OF-WAY	---R/W---
CENTERLINE OF ROAD	---
EXISTING STRIPING	---
EXISTING MAJOR CONTOUR	---970---
EXISTING MINOR CONTOUR	---
EXISTING BUILDING	---
EXISTING CONCRETE PAVEMENT	---
EXISTING GRAVEL	---
EXISTING ASPHALT PAVEMENT	---
EXISTING AERIAL ELECTRIC	---AE---
EXISTING UTILITY POLE	⊙
EXISTING SANITARY SEWER	---SAN---
EXISTING WATER MAIN	---W---
EXISTING GAS MAIN	---G---
EXISTING STORM SEWER	---SS---
EXISTING UNDERGROUND TELEPHONE	---UGT---
EXISTING UNDERGROUND ELECTRIC	---UGE---
EXISTING TELEPHONE PEDESTAL	□
EXISTING WATER VALVE	⊕
EXISTING WATER METER	⊕
EXISTING FIBER OPTIC	---FO---
EXISTING GAS VALVE	⊕
EXISTING FIRE HYDRANT	⊕
EXISTING MAILBOX	□
EXISTING SIGN	⊕
EXISTING FENCE	---X---
EXISTING LIGHT	⊕
EXISTING BUSH	⊕
EXISTING TREE	⊕
EXISTING UTILITY (TERMINUS UNKNOWN)	---
EXISTING GUY WIRE	---
EXISTING EDGE OF WOODS	---

CORING SAMPLES

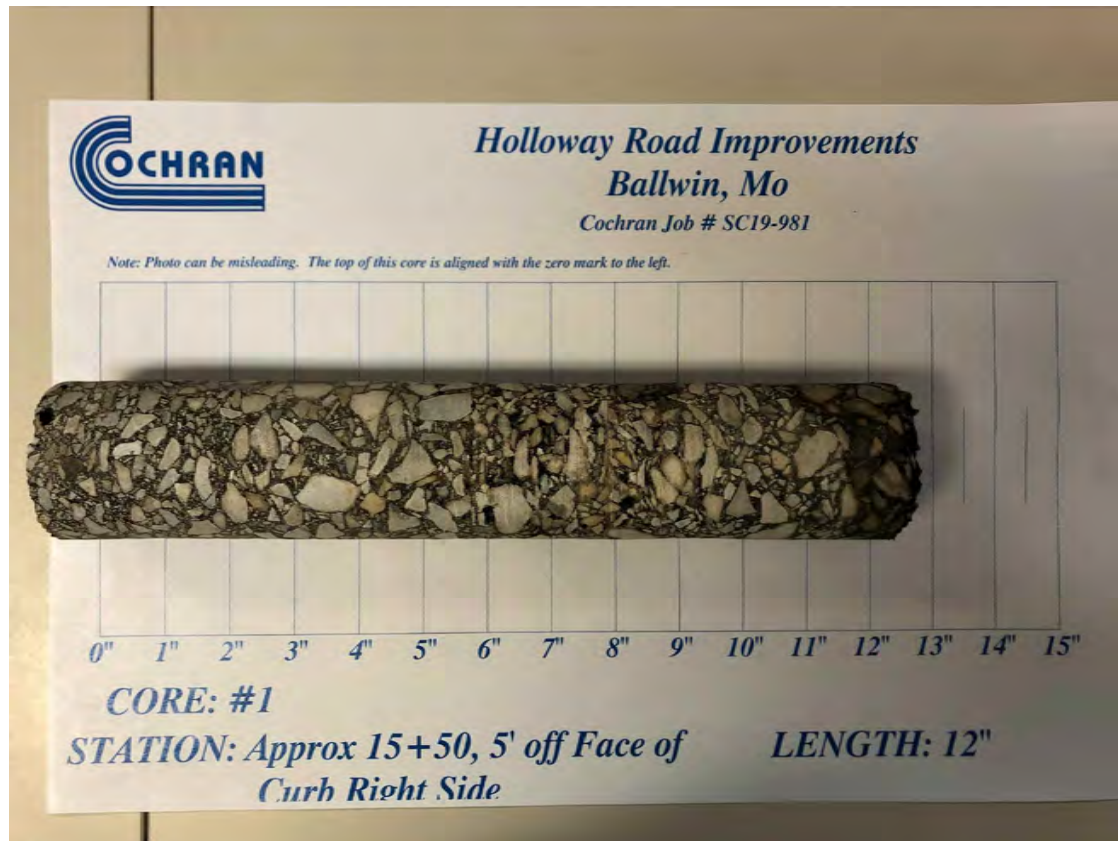

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 FENTON, MISSOURI 65026

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 ENGINEERING CERTIFICATE OF AUTHORITY NUMBER - 2007006937
 LAND SURVEYING CERTIFICATE OF AUTHORITY NUMBER - 2007004529

STATE OF MISSOURI
 KEVIN J. WOLFF, P.E.
 1/28/21
 NO. PE-200400859
 STATE OF MISSOURI
 REGISTERED PROFESSIONAL ENGINEER
 FOR SC ENGINEERING LLC,
 DBA COCHRAN

THIS SHEET HAS BEEN SIGNED,
 SEALED AND DATED ELECTRONICALLY

THE PROFESSIONAL'S SEAL AFFIXED TO
 THIS SHEET APPLIES ONLY TO ITEMS
 ON THIS SHEET. ALL DRAWINGS OR
 OTHER DOCUMENTS NOT EXHIBITING
 THIS SEAL SHALL NOT BE CONSIDERED
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HOLLOWAY ROAD IMPROVEMENTS
FEDERAL PROJECT NO. STP-4939(608)
CITY OF BALLWIN, MISSOURI

NO.	DATE	REVISION

DWN. BY: K.J.W. APPD. BY: M.D.S.
 DATE: JANUARY 2021
 SCALE: NO SCALE
 PROJ. NO: SC19-981
 DWG. NO: **CS-1**

Drawing name: I:\SC19-981 Holloway Road, Ballwin, MO\AUTOCAD DRAWINGS\CORING SAMPLES.dwg Tab: CS-1 Plotted on: Feb 09, 2021 - 10:29am Plotted by: kwolff

LEGEND AND GENERAL NOTES

LEGEND, GENERAL NOTES AND ABBREVIATIONS SHALL APPLY TO ALL SHEETS UNLESS OTHERWISE NOTED ON INDIVIDUAL SHEET

LEGEND

EXISTING		NEW		EXISTING		NEW	
	INDEX CONTOUR		500		TREE		
	INTERMEDIATE CONTOUR		498		TREELINE		
	RIGHT-OF-WAY		R/W		LIGHT		
	LOT LINE		PE		COBRAHEAD LIGHT		
	PERMANENT EASEMENT		AE		LOAD CENTER		
	AERIAL ELECTRIC		AE		HAND HOLE		
	UTILITY POLE		AE		MAILBOX		
	GUY WIRE		AE		SIGN		
	UNDERGROUND ELECTRIC		UGE		CORING LOCATION		
	UNDERGROUND CABLE TV		CATV		CONCRETE PAVEMENT		
	UNDERGROUND TELEPHONE		UGT		ASPHALT PAVEMENT		
	UNDERGROUND FIBER OPTIC		FO		CONCRETE APPROACH		
	SANITARY SEWER LINE		SAN		CONCRETE ISLAND		
	SANITARY FORCEMAIN		FM		CONCRETE SIDEWALK		
	SANITARY SEWER MANHOLE				CURB RAMP		
	STORM SEWER LINE				ASPHALT DRIVEWAY		
	STORM SEWER MANHOLE				AGGREGATE DRIVEWAY		
	CURB/AREA INLET				CONCRETE VERTICAL CURB		
	GRATED INLET				CONCRETE CURB AND GUTTER		
	GRATED INLET W/ SIDE INTAKE				CONSTRUCTION LIMITS		
	FLARED END SECTION				SILT FENCE		
	SWALE				INLET CHECK		
	GAS LINE				DITCH CHECK		
	GAS VALVE				PROJECT BASELINE		
	GAS METER						
	WATER LINE						
	FIRE HYDRANT						
	WATER VALVE						
	WATER METER						
	GUARDRAIL						
	FENCE						

GENERAL NOTES

TOPOGRAPHIC SURVEY NOTES:

- UNDERGROUND STRUCTURES, FACILITIES, AND UTILITIES HAVE BEEN PLOTTED FROM AVAILABLE SURVEYS AND RECORDS. THEREFORE, THEIR LOCATIONS MUST BE CONSIDERED APPROXIMATE ONLY. THERE MAY BE OTHERS, THE EXISTENCE OF WHICH IS PRESENTLY NOT KNOWN.
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- THE CONTRACTOR IS SPECIFICALLY CAUTIONED THAT THE LOCATION AND/OR ELEVATION OF EXISTING UTILITIES AS SHOWN ON THESE PLANS IS BASED ON RECORDS OF VARIOUS UTILITY COMPANIES AND, WHERE POSSIBLE, MEASUREMENTS TAKEN IN THE FIELD. THE INFORMATION IS NOT TO BE RELIED ON AS BEING EXACT OR COMPLETE. THE CONTRACTOR SHALL FIELD VERIFY THE LOCATION AND ELEVATION OF ALL POTENTIAL UTILITY CONFLICTS PRIOR TO ORDERING MATERIALS FOR CONSTRUCTION. THE CONTRACTOR MUST CALL THE APPROPRIATE UTILITY COMPANY AT LEAST 48 HOURS BEFORE ANY EXCAVATION TO REQUEST EXACT FIELD LOCATION OF UTILITIES. LOCATION, RELOCATION AND CONNECTION OF THE UTILITIES SHALL BE COORDINATED WITH THE UTILITY COMPANIES.
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- THIS TOPOGRAPHIC SURVEY DOES NOT CONSTITUTE A PROPERTY BOUNDARY SURVEY.

DESIGN NOTES:

- CONTRACTOR SHALL RELOCATE ALL EXISTING SIGNS, PLANTERS, MAILBOXES, AND PRIVATE LIGHTS AS NECESSARY FOR THE CONSTRUCTION OF THE IMPROVEMENTS. NEW LOCATIONS SHALL BE AS DIRECTED BY THE ENGINEER.
- CONTRACTOR SHALL ADJUST TO GRADE ALL UTILITIES NECESSARY TO BRING THE UTILITY TO THE GRADE OF THE NEW CONSTRUCTION.
- CONTRACTOR SHALL FIELD VERIFY THE LOCATION AND ELEVATION OF ALL POTENTIAL UTILITY CONFLICTS PRIOR TO ORDERING STORM SEWER PIPE AND STRUCTURES.
- CONTRACTOR SHALL DISCUSS MILLING DEPTHS WITH THE ENGINEER PRIOR TO STARTING THE MILLING PROCESS. DEPTH SHOWN IS APPROXIMATE AND MAY VARY AS DIRECTED TO OBTAIN THE DESIRED CROSS SLOPE AND PROFILE. UNIT COST FOR THE MILLING WORK SHALL NOT CHANGE REGARDLESS OF THE MILLED THICKNESS, UNLESS THE BID FORM PROVIDES MULTIPLE MILLING DEPTH LINE ITEMS.
- CONTRACTOR SHALL REMOVE AND REPLACE ALL EXISTING PRIVATE SIDEWALKS AS NECESSARY FOR THE CONSTRUCTION OF THE IMPROVEMENTS. PRIVATE SIDEWALKS SHALL BE SAW CUT AT THE RIGHT-OF-WAY OR NEAREST JOINT AS DIRECTED BY THE ENGINEER.
- EXISTING CULVERT PIPES, WHICH ARE UNDER DRIVEWAYS BEING REPLACED BY THE CONSTRUCTION OF IMPROVEMENTS, SHALL BE REMOVED.
- OBLITERATE ANY EXISTING STRIPING THAT CONFLICTS WITH THE PROPOSED PAVEMENT MARKING PLAN. THE PROCESS FOR REMOVAL SHALL BE APPROVED BY THE ENGINEER PRIOR TO BEGINNING (INCIDENTAL TO CONSTRUCTION).
- THE LOCATION OF THE NEW UNDERGROUND ELECTRIC FOR STREET LIGHTING AS SHOWN IS APPROXIMATE AND SHALL NOT INTERFERE WITH ANY NEW OR EXISTING UTILITIES, SIGNS, TREES, OR IMPROVEMENTS OF ANY KIND. THEREFORE, THE CONTRACTOR SHALL COORDINATE THE INSTALLATION OF UNDERGROUND ELECTRIC WITH EXISTING UTILITIES AND ANY OTHER IMPROVEMENTS ASSOCIATED WITH THIS PROJECT.
- ALL AREAS OF CLEARING, GRUBBING AND STRIPPING NOT SHOWN IN PLANS, CONTRACTOR SHALL CONDUCT CLEARING, GRUBBING AND STRIPPING AS NECESSARY UNLESS OTHERWISE NOTED IN PLANS.

ABBREVIATIONS

AI - AREA INLET	MH - MANHOLE	VPT - VERTICAL POINT OF TANGENCY
ARC - ARC LENGTH	MIN - MINIMUM	∅ - DIAMETER
ATG - ADJUST TO GRADE	NO - NUMBER	CL - CENTERLINE
BF - BOTTOM OF FOOTING	O/S - OFFSET	(1) - KEYED NOTE
BOP - BEGINNING OF PAVEMENT	OC - ON CENTER	
BW - BOTTOM OF WALL	PC - POINT OF CURVATURE	
CB - CHORD BEARING	PCC - POINT OF COMPOUND CURVATURE	
CHD - CHORD LENGTH	PE - PERMANENT EASEMENT	
CI - CURB INLET	PI - POINT OF INTERSECTION	
CMP - CORRUGATED METAL PIPE	PRC - POINT OF REVERSE CURVATURE	
DCI - DOUBLE CURB INLET	PT - POINT OF TANGENCY	
DGI - DOUBLE GRATED INLET	R/W - RIGHT-OF-WAY	
ELEV - ELEVATION	RAD - RADIUS	
EOP - END OF PAVEMENT	RCP - RE-INFORCED CONCRETE PIPE	
FES - FLARED END SECTION	RT - RIGHT	
FL - FLOW LINE	SSD - STOPPING SIGHT DISTANCE	
GCI - GRATED CURB INLET	STA - STATION	
GI - GRATED INLET	TBR - TO BE REMOVED	
GIS - GRATED INLET WITH SIDE INTAKE	TBR&R - TO BE REMOVED AND REPLACED	
HDPE - HIGH-DENSITY POLYETHYLENE	TCE - TEMPORARY CONSTRUCTION EASEMENT	
JB - JUNCTION BOX	TW - TOP OF WALL	
LF - LINEAR FEET	TYP - TYPICAL	
LT - LEFT	VPC - VERTICAL POINT OF CURVATURE	
MAX - MAXIMUM	VPI - VERTICAL POINT OF INTERSECTION	

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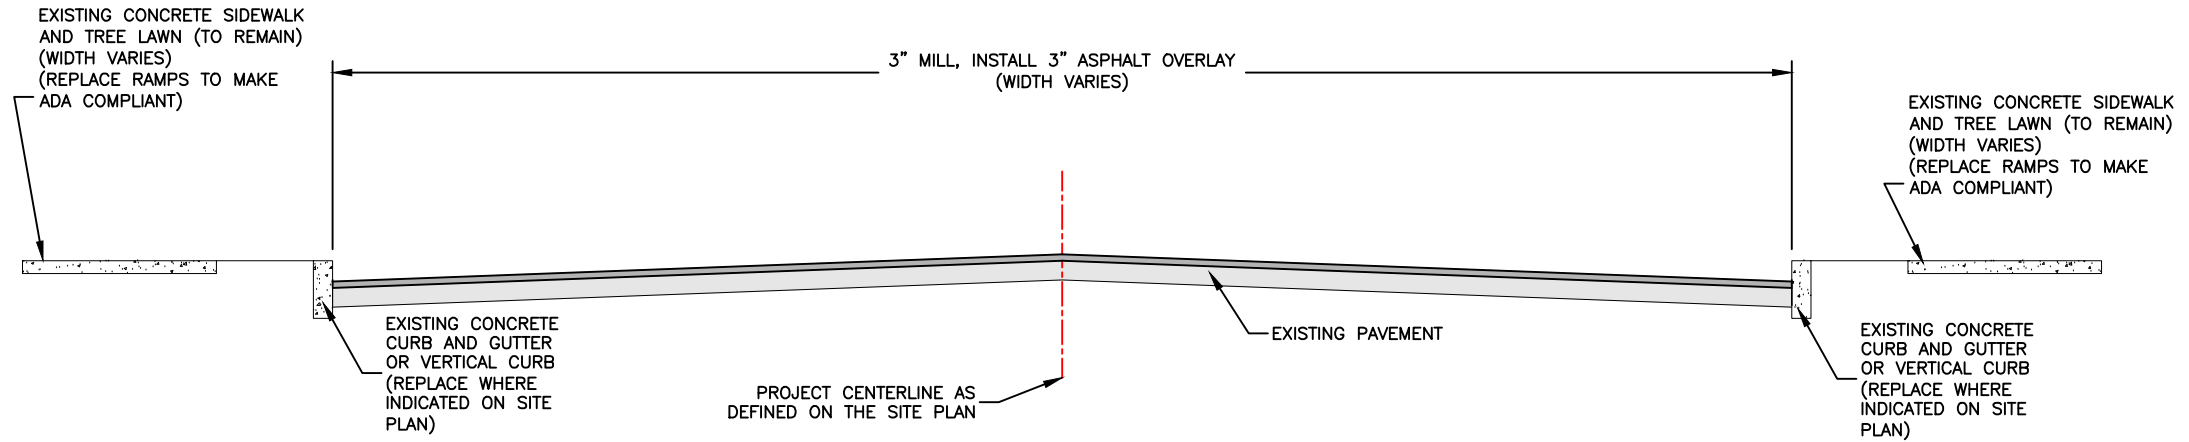
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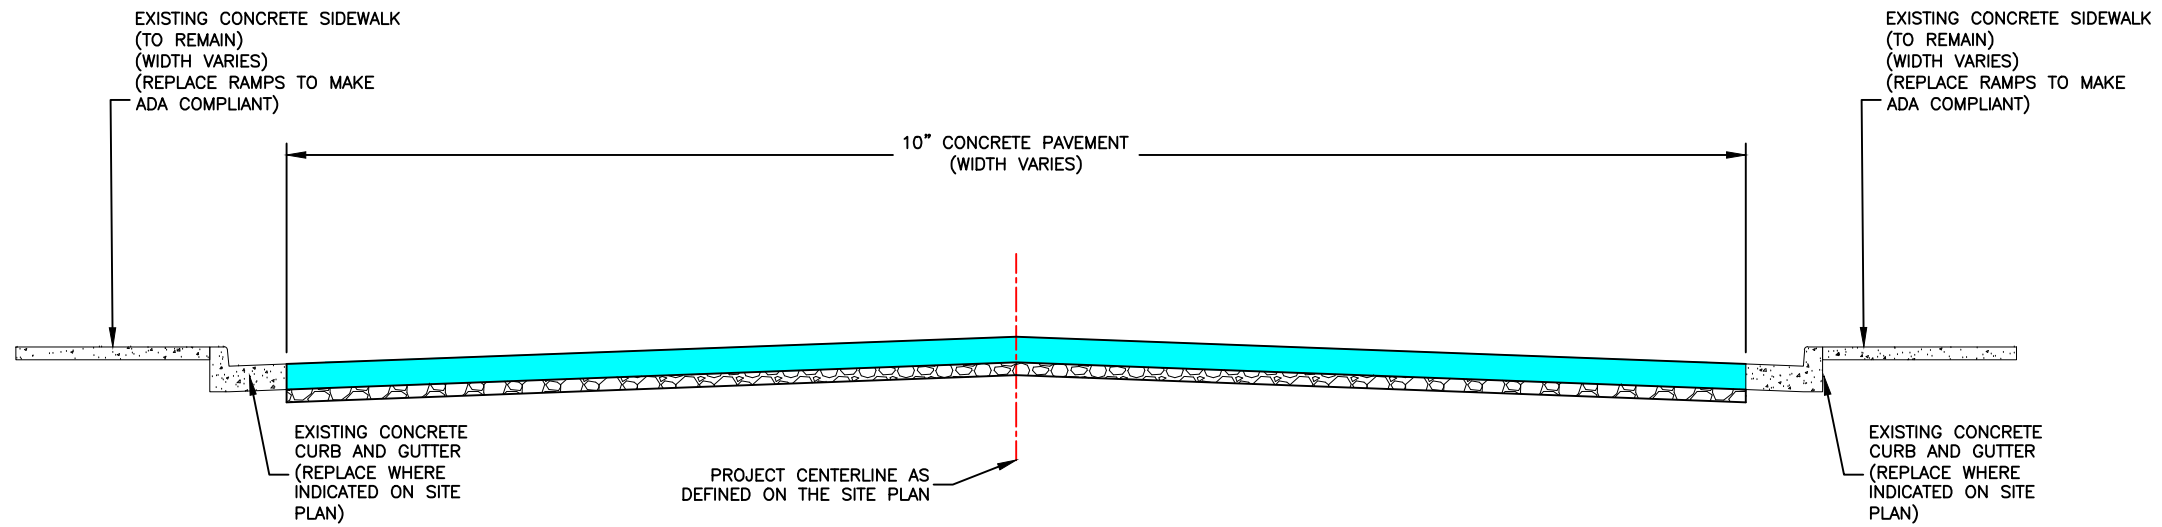
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CITY OF BALLWIN, MISSOURI

LEGEND AND GENERAL NOTES	
DATE	REVISION
DWN BY:	APPD BY:
K.J.W.	M.D.S.
DATE:	JANUARY 2021
SCALE:	1" = 20'
PROJ. NO.:	SC19-981
DWG. NO.:	LG-1



TYPICAL SECTION
STA. 13+17 TO 77+32



TYPICAL SECTION
STA. 77+32 TO 80+71

SITE PLAN



TRACT NO. 1
246 CEDAR TRAIL DR.
SIMMONS, MARY L.
BK. 8488 PG. 1034

TRACT NO. 2
244 CEDAR TRAIL DR.
KATZ, JANET
BK. 18926 PG. 2788

TRACT NO. 3
242 CEDAR TRAIL DR.
KORVAS, ROBERT G.
& MARGARET K. H/W
BK. 17531 PG. 3400


TRACT NO. 4
6 PARKROSE CT.
THE DILLON FAMILY, TRUST
BK. 20660 PG. 1506

TRACT NO. 5
7 PARKROSE CT.
HAUN, DANIEL & LORI H/W
BK. 17760 PG. 3498

TRACT NO. 6
8 PARKROSE CT.
SCHNEIDER, JOAN
LIVING TRUST
BK. 21261 PG. 503

TRACT NO. 7
9 PARKROSE CT.
RITCHEY, CELIA A.
BK. 11899 PG. 350

TRACT NO. 9
333 HOLLOWAY RD.
CITY OF BALLWIN
BK. 6706 PG. 1598

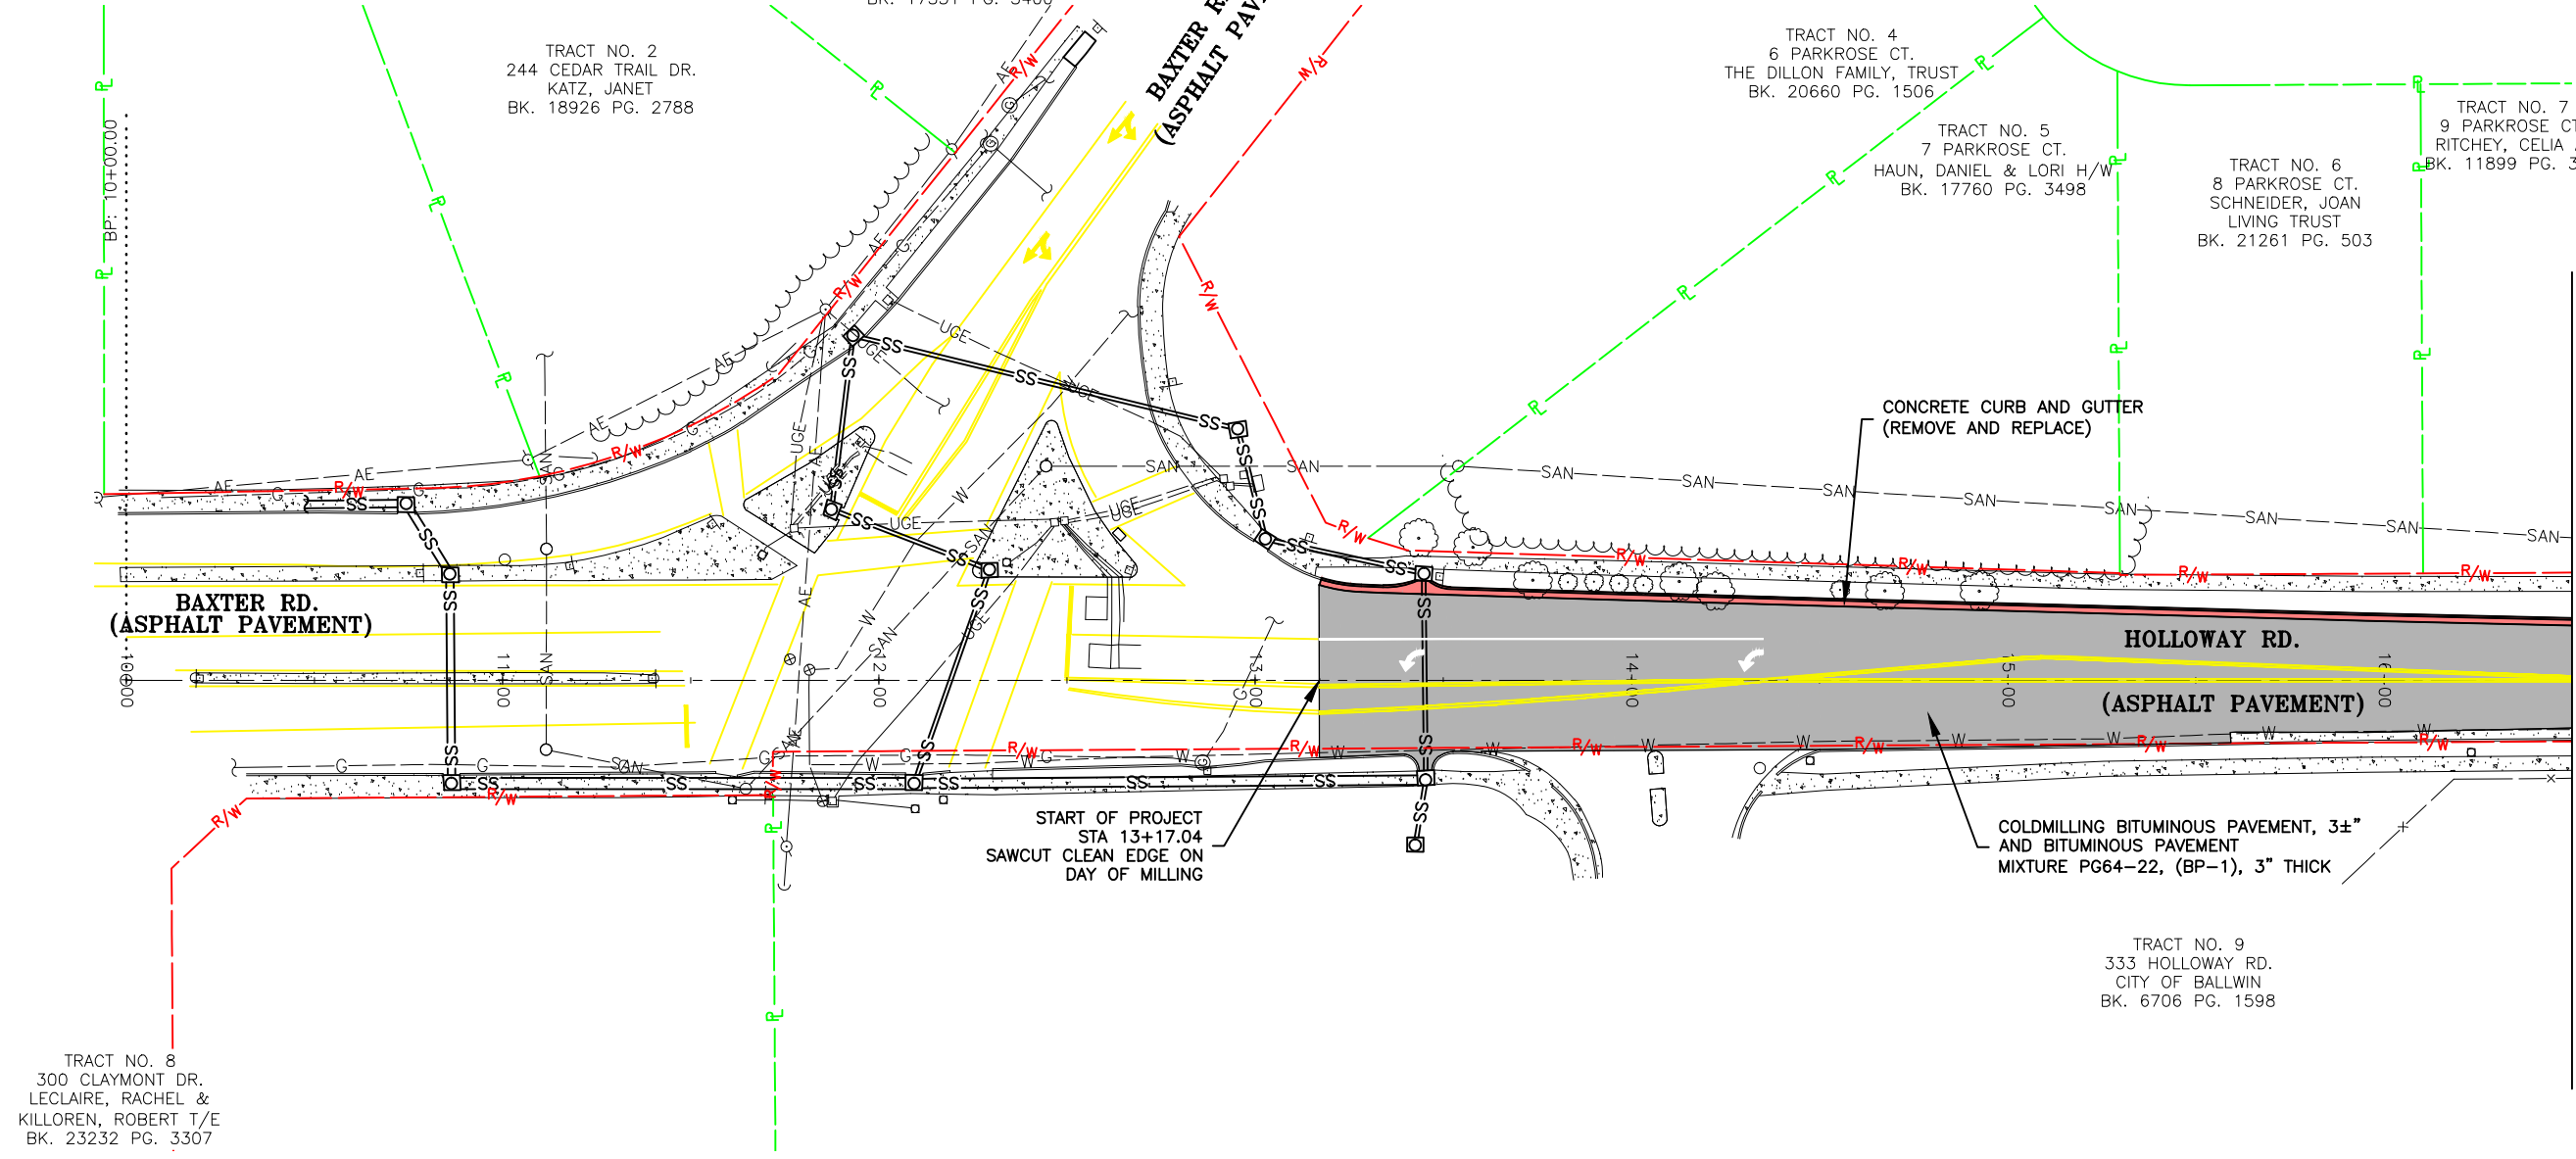

MATCH LINE STA. 16+50 SEE SHEET S-2

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Professional Engineer
No. PE-200400859
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REGISTERED PROFESSIONAL ENGINEER
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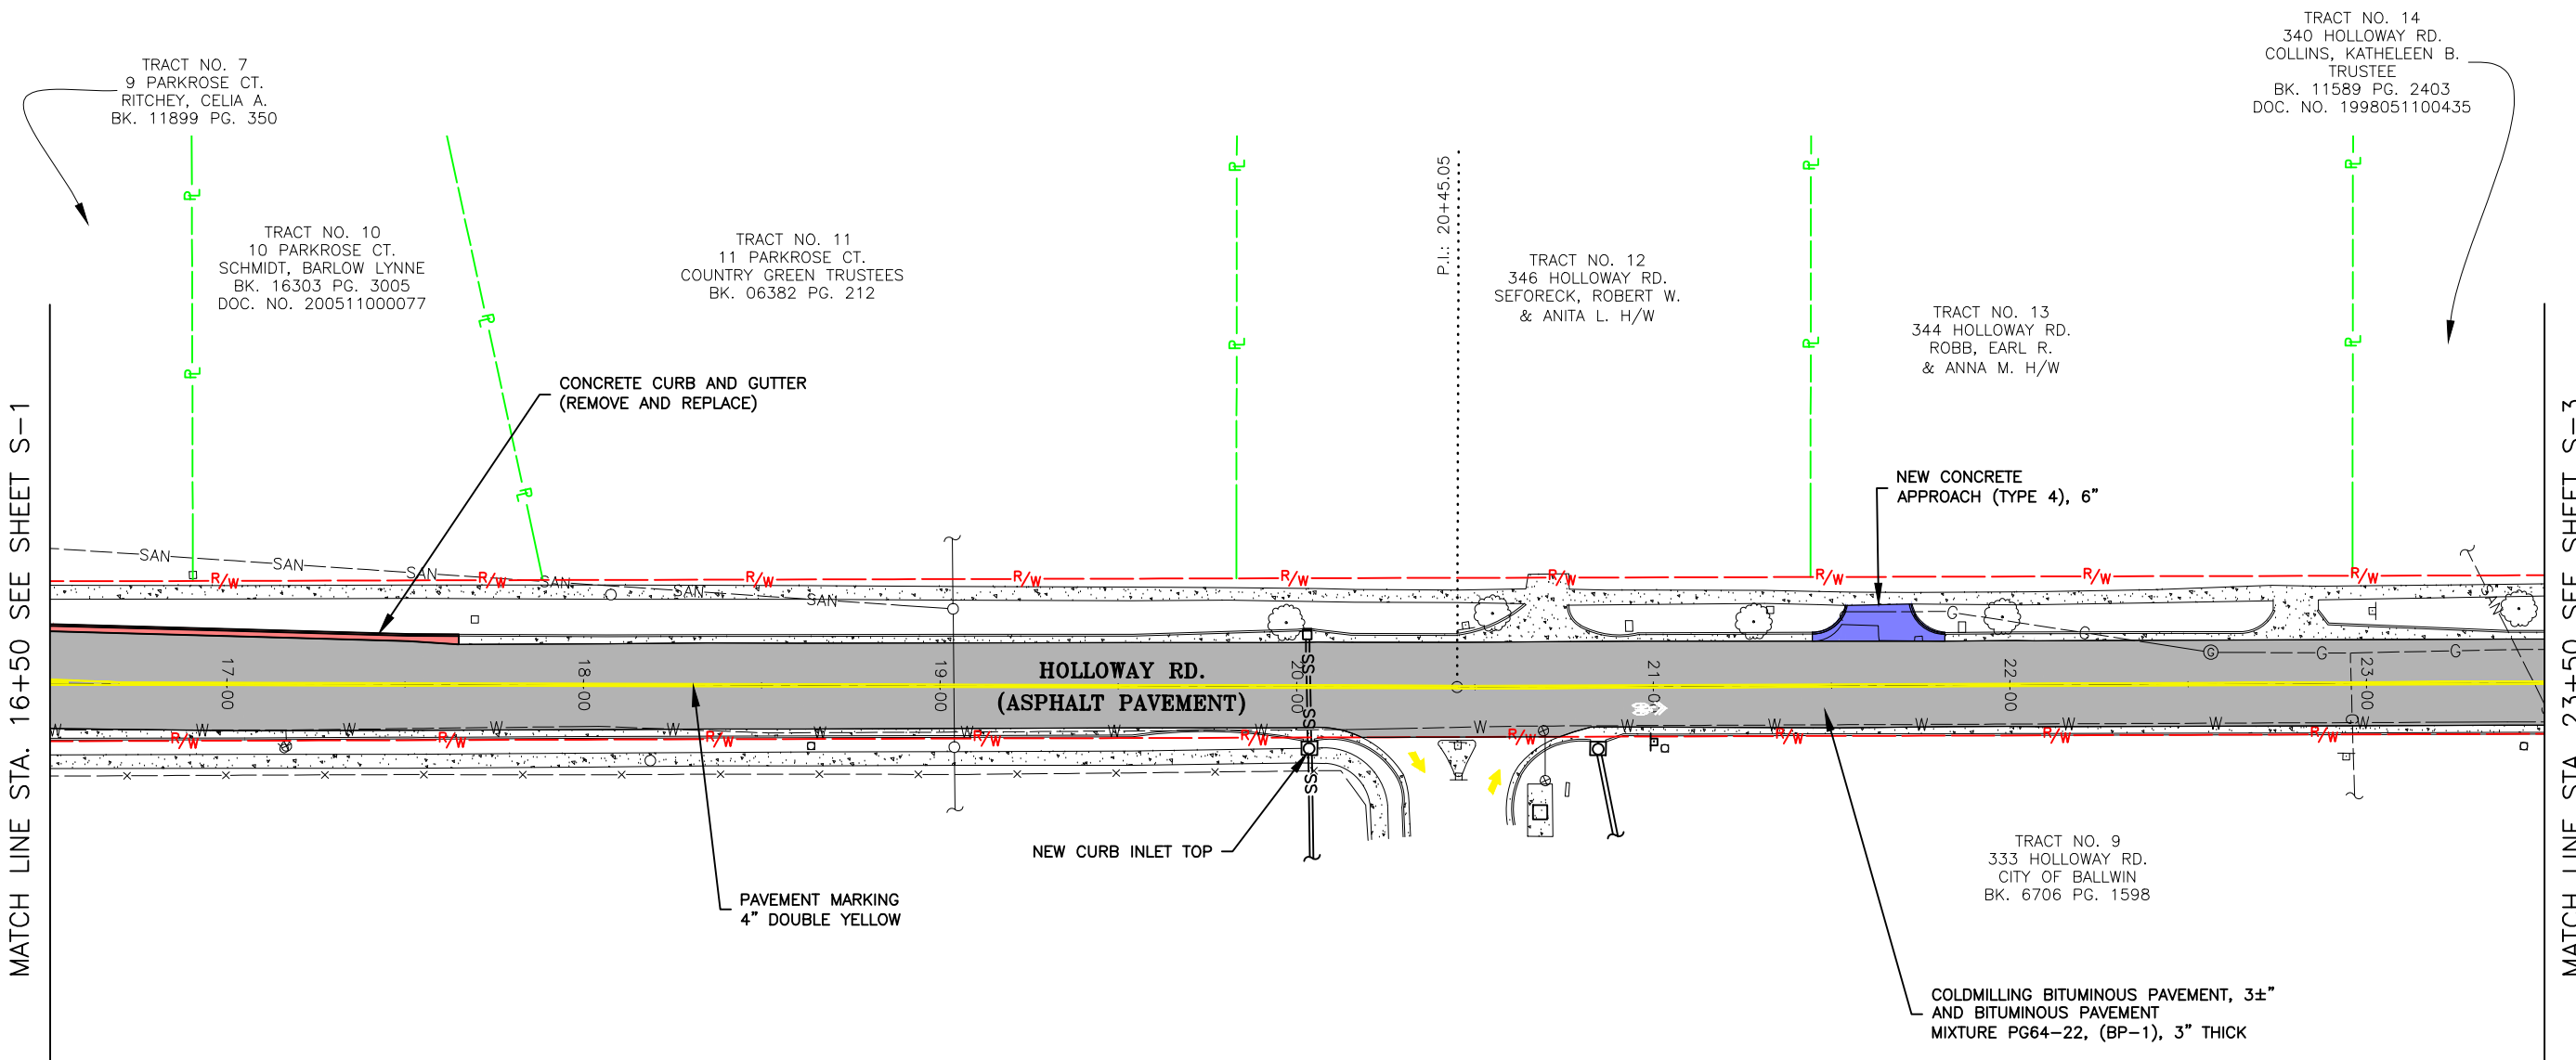
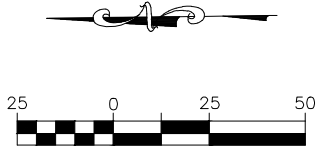
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DATE: JANUARY 2021
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SITE PLAN



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MATCH LINE STA. 23+50 SEE SHEET S-3

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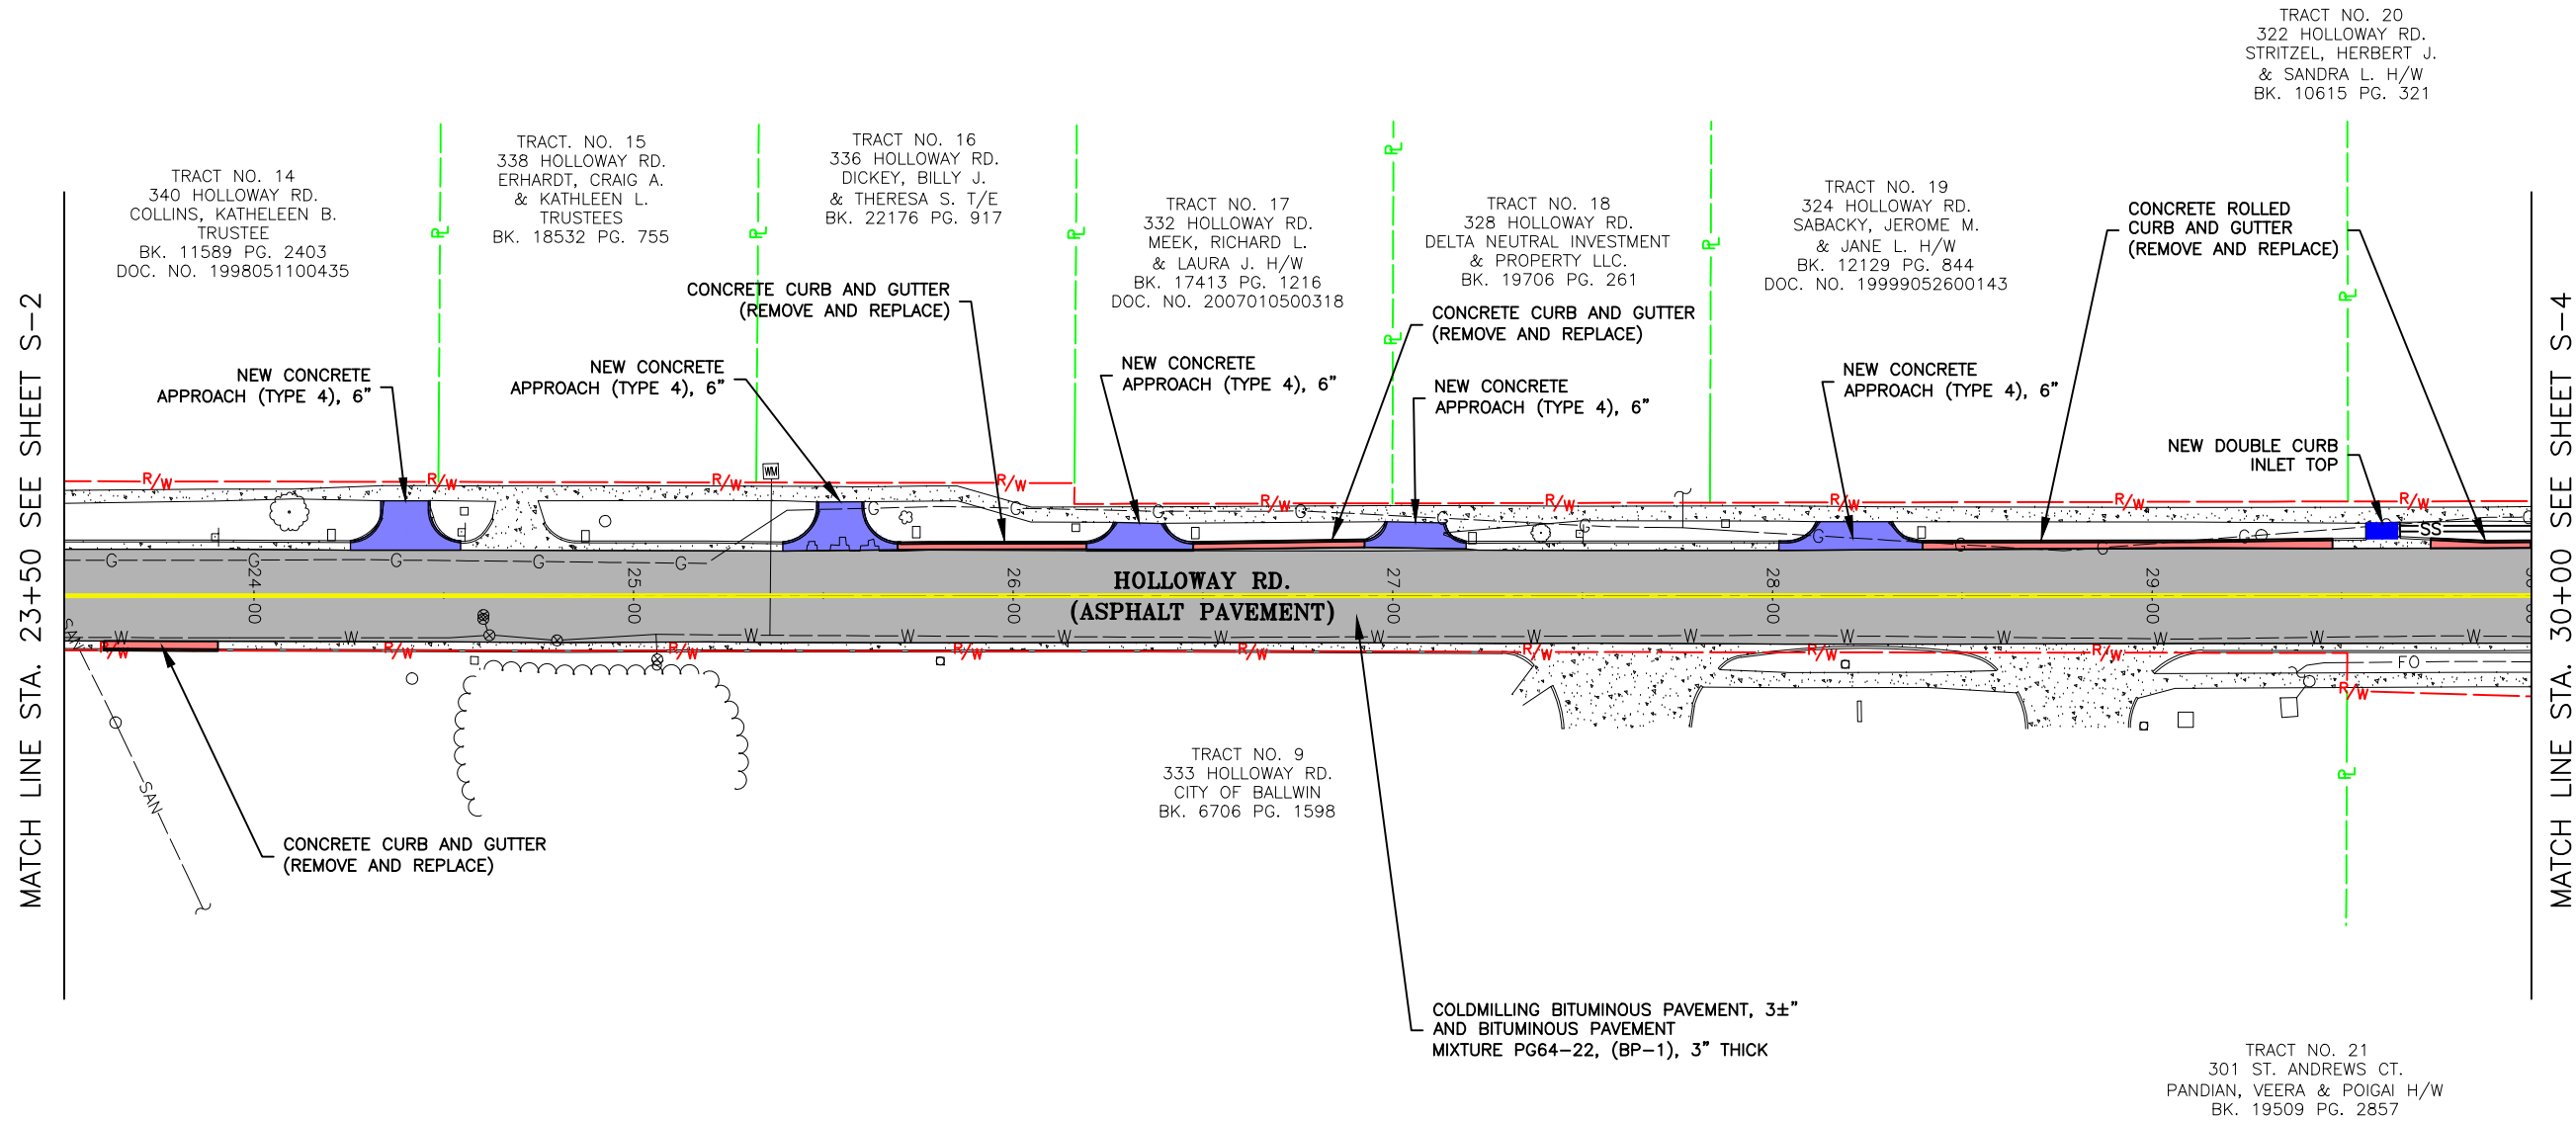
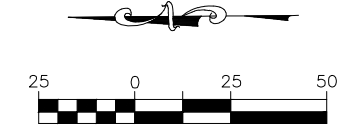
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DWG. NO.:	S-2

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MATCH LINE STA. 30+00 SEE SHEET S-4

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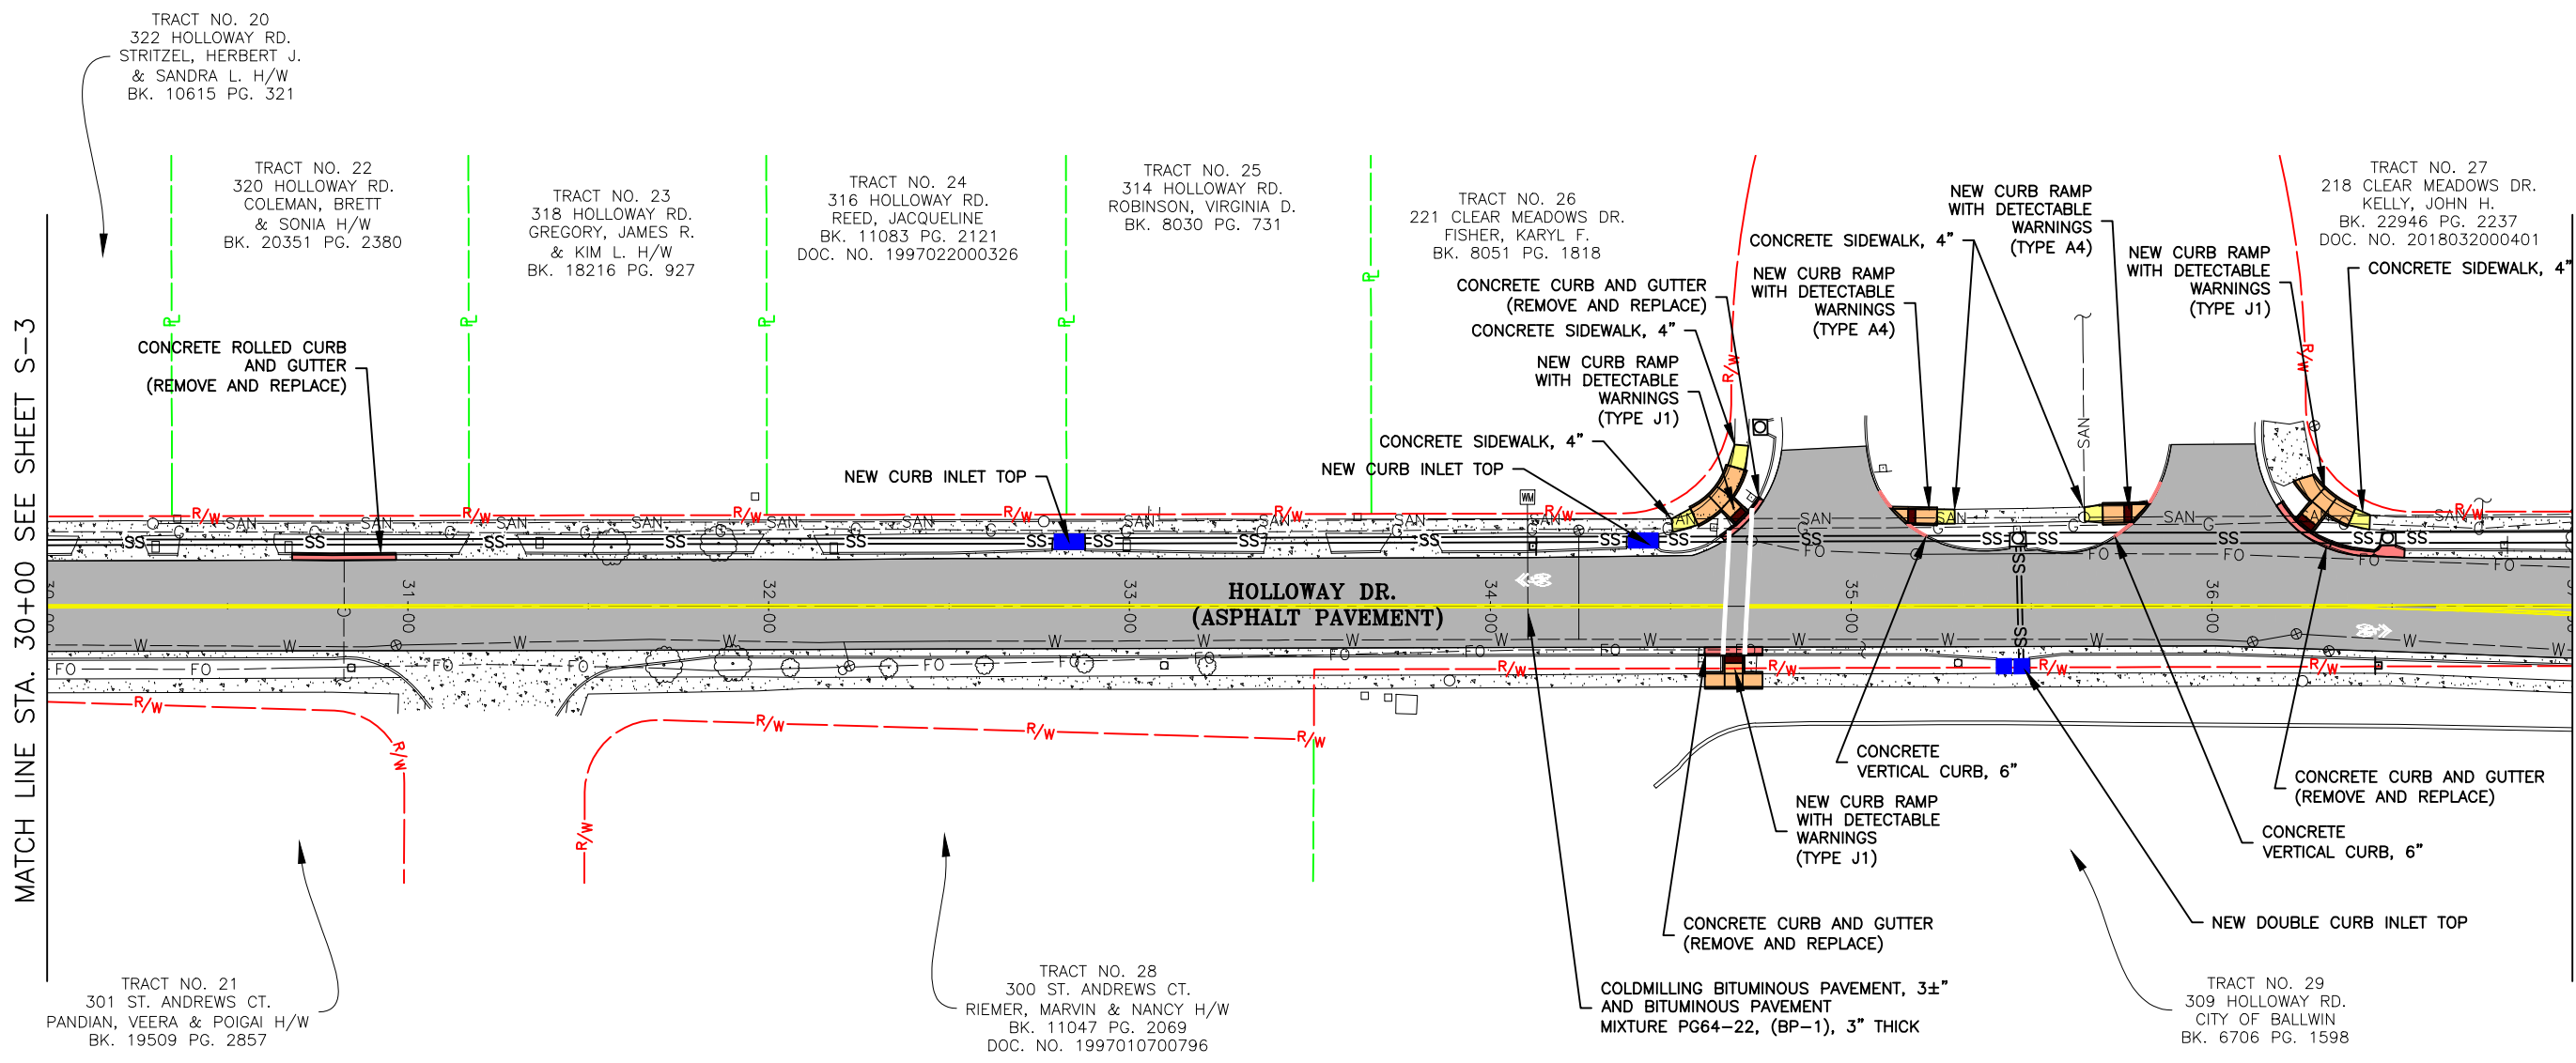
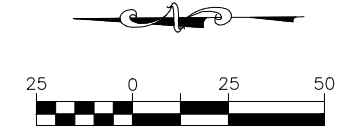
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 DWG. NO: S-3

SITE PLAN



MATCH LINE STA. 30+00 SEE SHEET S-3

MATCH LINE STA. 37+00 SEE SHEET S-5

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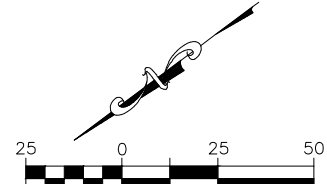
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PROJ. NO: SC19-981
DWG. NO: S-4

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SITE PLAN



TRACT NO. 31
304 HOLLOWAY RD.
MURPHY, WILLIAM G. &
TURNER, HELEN H/W
BK. 14674 PG. 1852
DOC. NO. 2003031800355

TRACT NO. 32
302 HOLLOWAY RD.
SCHIECHTER, JAMES
& PATRICIA T/E
BK. 23144 PG. 2341
DOC. NO. 2018080800438


TRACT NO. 29
309 HOLLOWAY RD.
CITY OF BALLWIN
BK. 6706 PG. 1598

TRACT NO. 29
309 HOLLOWAY RD.
CITY OF BALLWIN
BK. 6706 PG. 1598

TRACT NO. 33
221 BLUE SAGE CT.
MIMG XCH SEVEN TRAILS LLC.
BK. 22652 PG.1507
DOC. NO. 2017081500432

50' TRACT OF LAND
CONVEYED TO CITY
OF BALLWIN
BK. 6480, PG. 987

TRACT NO. 27
218 CLEAR MEADOWS DR.
KELLY, JOHN H.
BK. 22946 PG. 2237
DOC. NO. 2018032000401

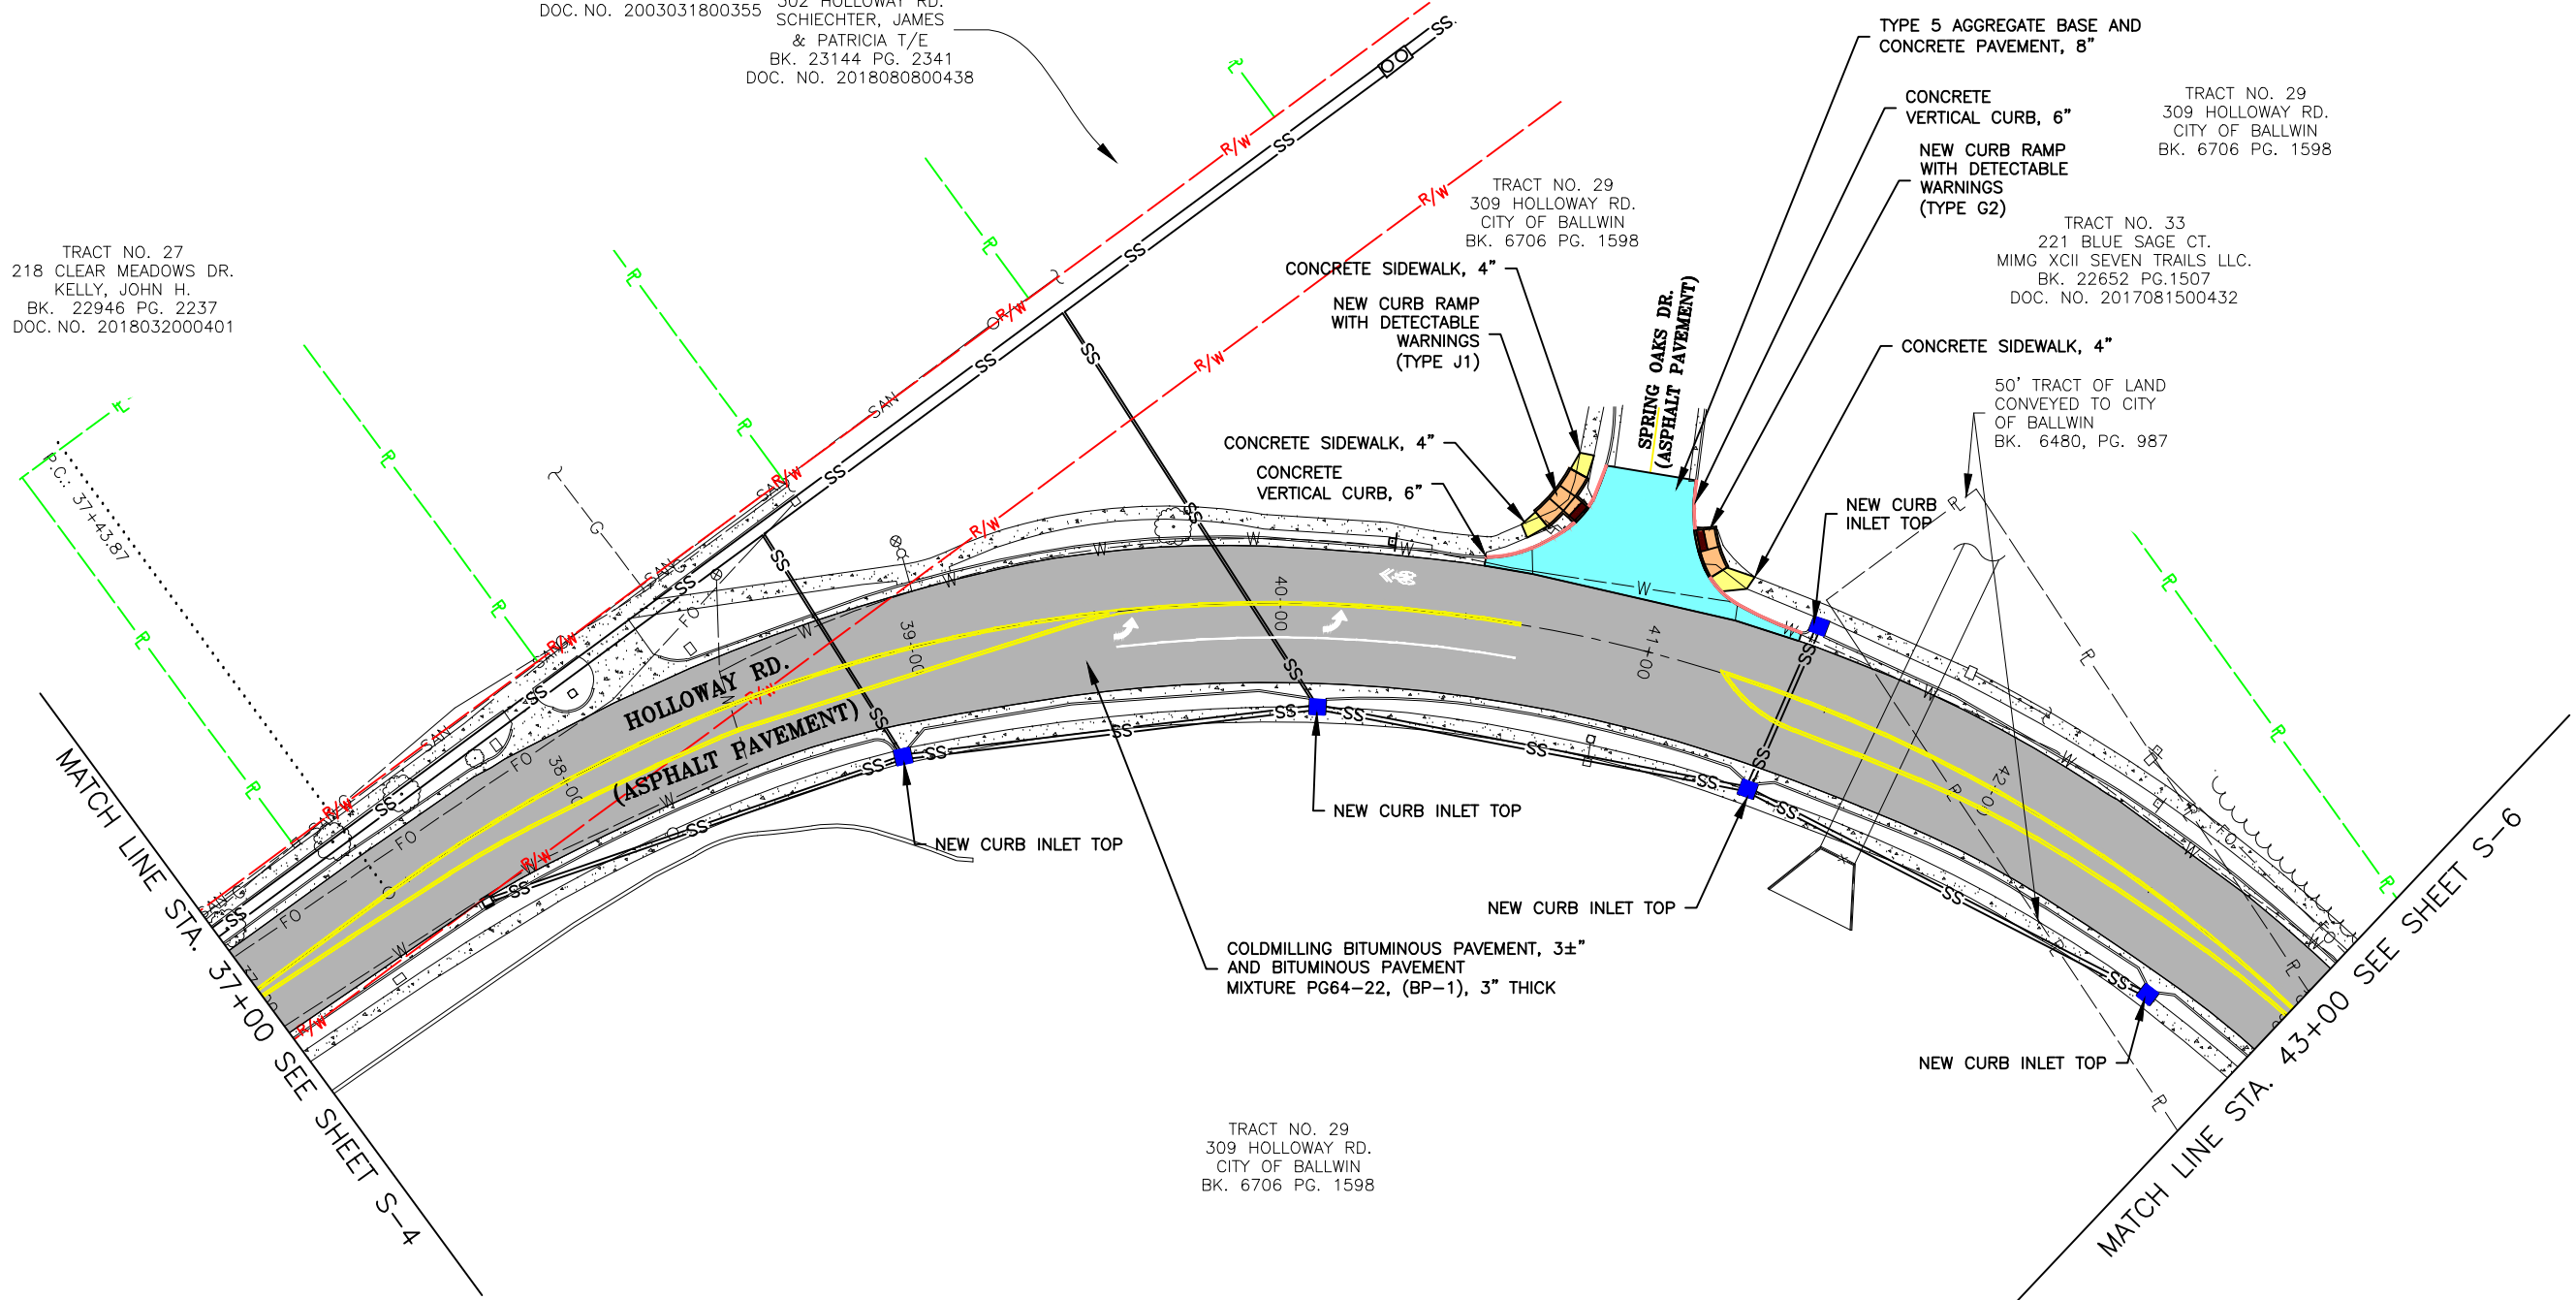

TRACT NO. 29
309 HOLLOWAY RD.
CITY OF BALLWIN
BK. 6706 PG. 1598

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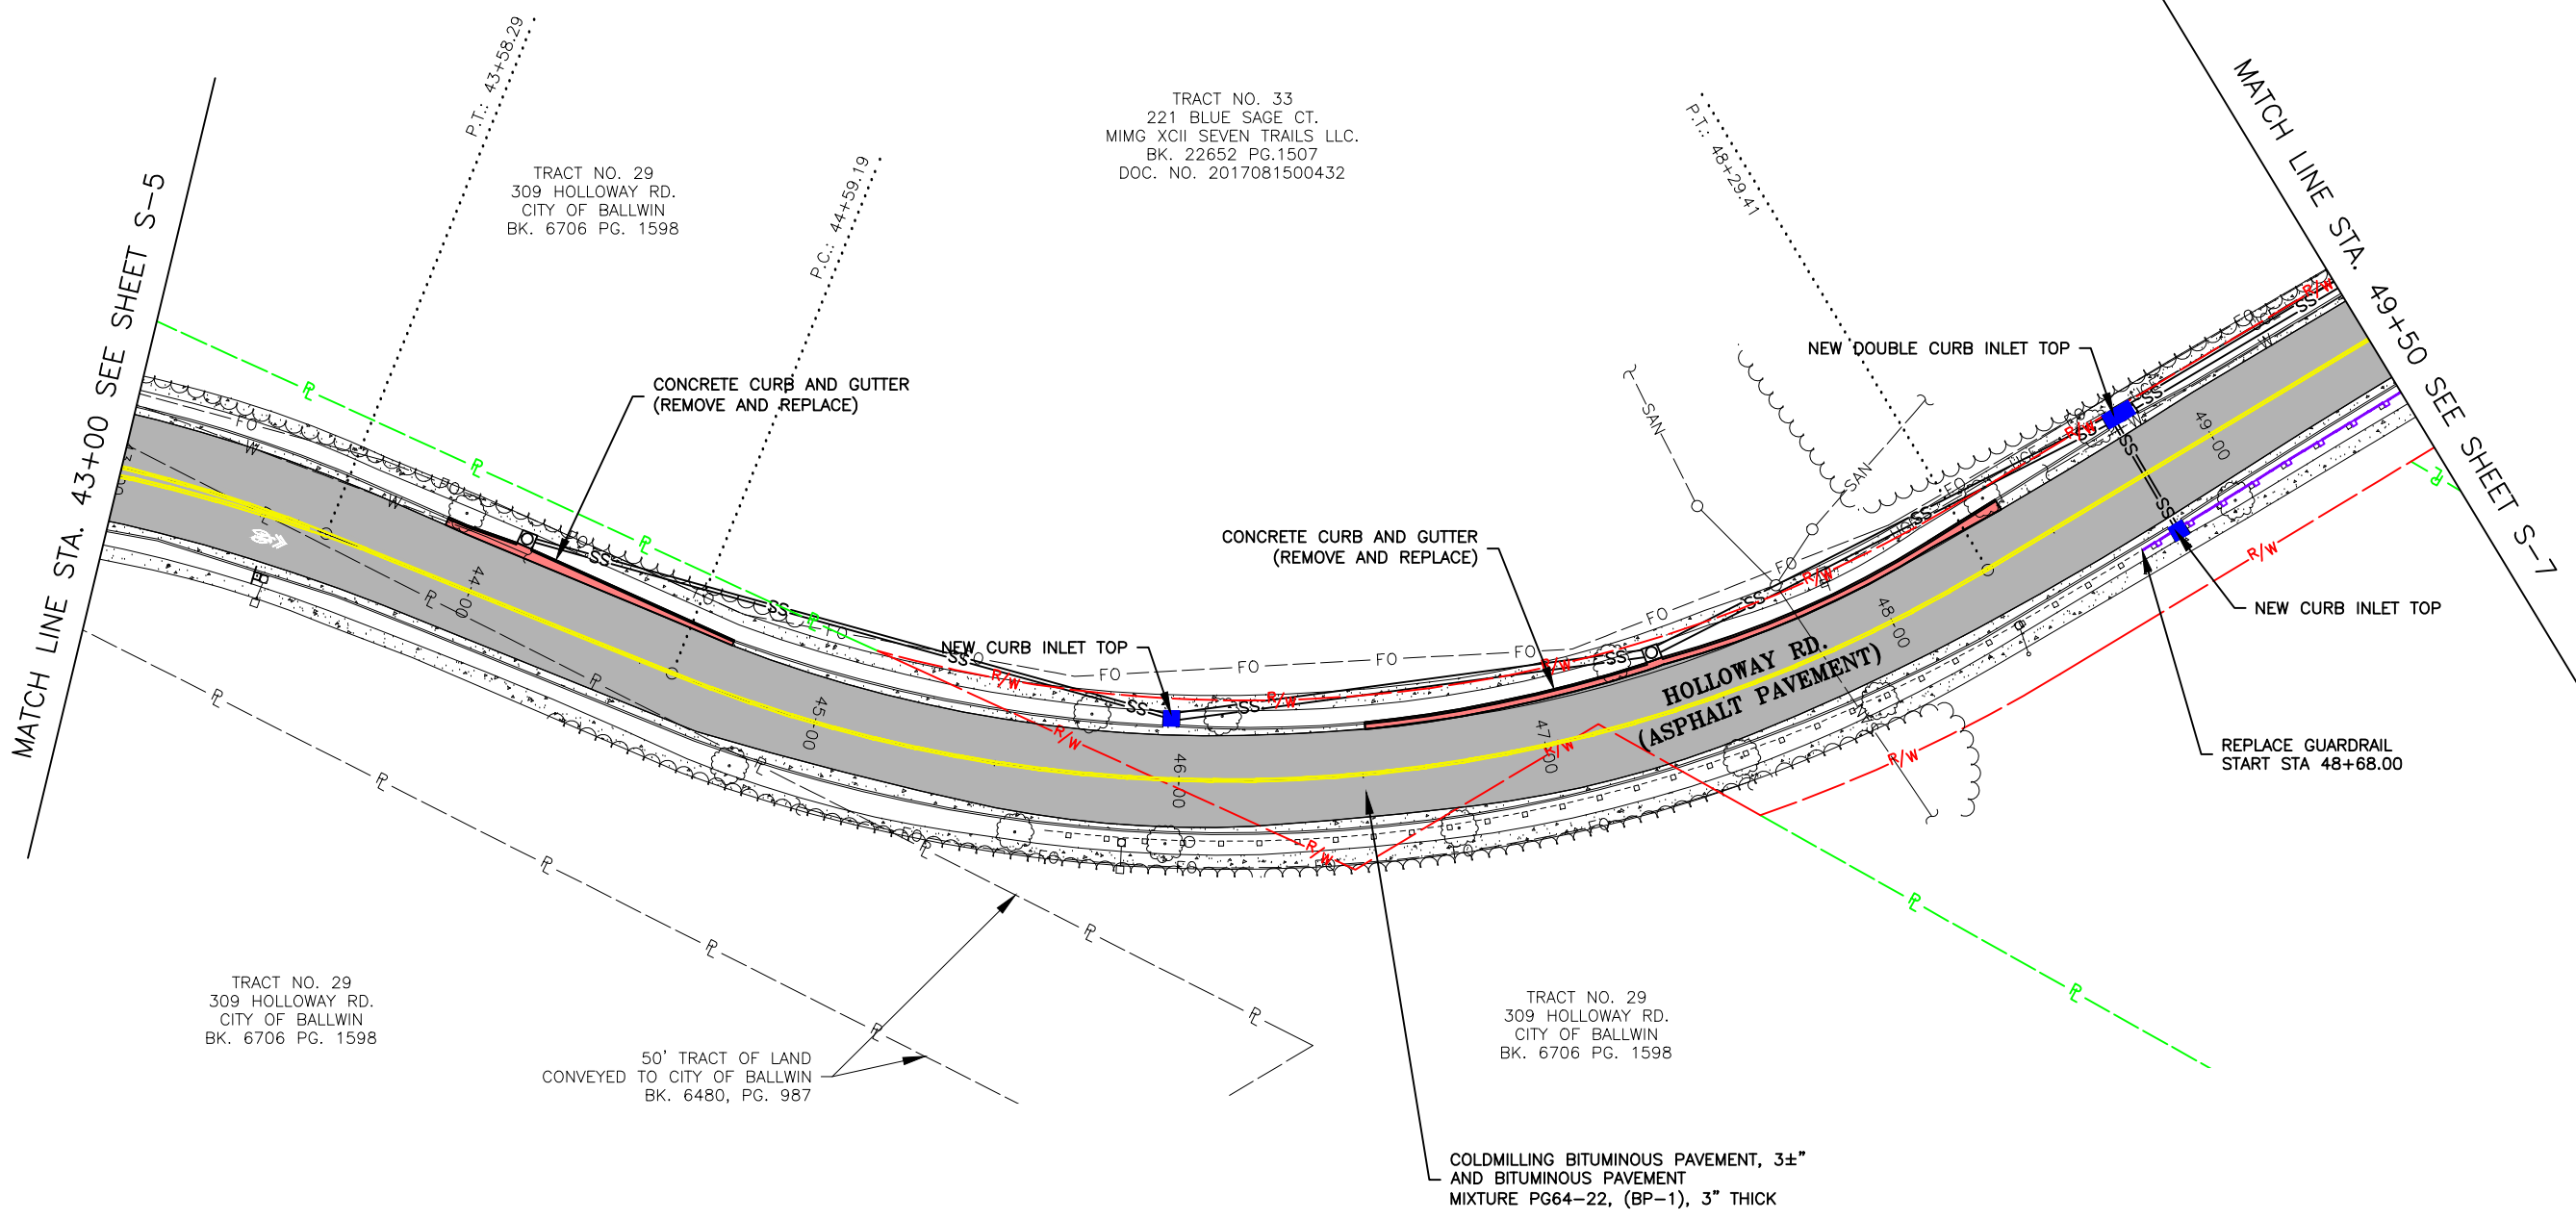
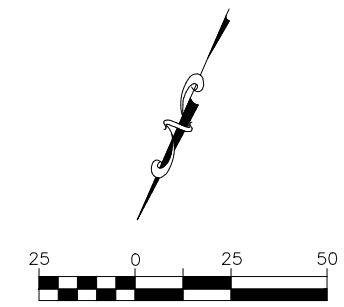
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CITY OF BALLWIN, MISSOURI

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 PROJ. NO: SC19-981
 DWG. NO: S-5

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SITE PLAN



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DATE: JANUARY 2021	
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PROJ. NO: SC19-981	
DWG. NO: S-6	

SITE PLAN



TRACT NO. 35
333 HOLLOWAY RIDGE CT
HOLLOWAY RIDGE
CONDOMINIUM ASSOCIATION
BK. 17638 PG. 4084
DOC. NO. 20070801243

TRACT NO. 35
333 HOLLOWAY RIDGE CT
HOLLOWAY RIDGE
CONDOMINIUM ASSOCIATION
BK. 17638 PG. 4084
DOC. NO. 20070801243

TRACT NO. 33
221 BLUE SAGE CT.
MIMG XCII SEVEN TRAILS LLC.
BK. 22652 PG.1507
DOC. NO. 2017081500432

TRACT NO. 33
221 BLUE SAGE CT.
MIMG XCII SEVEN TRAILS LLC.
BK. 22652 PG.1507
DOC. NO. 2017081500432

TRACT NO. 36
510 WINDSOR MILL DR.
MAY, DAVID ETAL
BK. 23364 PG. 2258
DOC. NO. 2019011800419


TRACT NO. 37
248 ESSEX MILL DR.
HOMYK, BARBARA A.
BK. 9117 PG. 1999

TRACT NO. 38
241 ESSEX MILL DR.
RILEY, TIMOTHY J.
& KATHLEEN H/W

TRACT NO. 39
552 SPRAGUES MILL CT
GAEHLE, ANNA MAY
BK. 11582 PG. 1134
DOC. NO. 1998050500614

TRACT NO. 40
554 SPRAGUES MILL CT.
MOSS, JOHN P. &
ELIZABETH DUCEY T/E

TRACT NO. 41
556 SPRAGUES MILL CT.
MILLER, TIMOTHY P.
BK. 169323 PG. 842
DOC. NO. 2005112201286

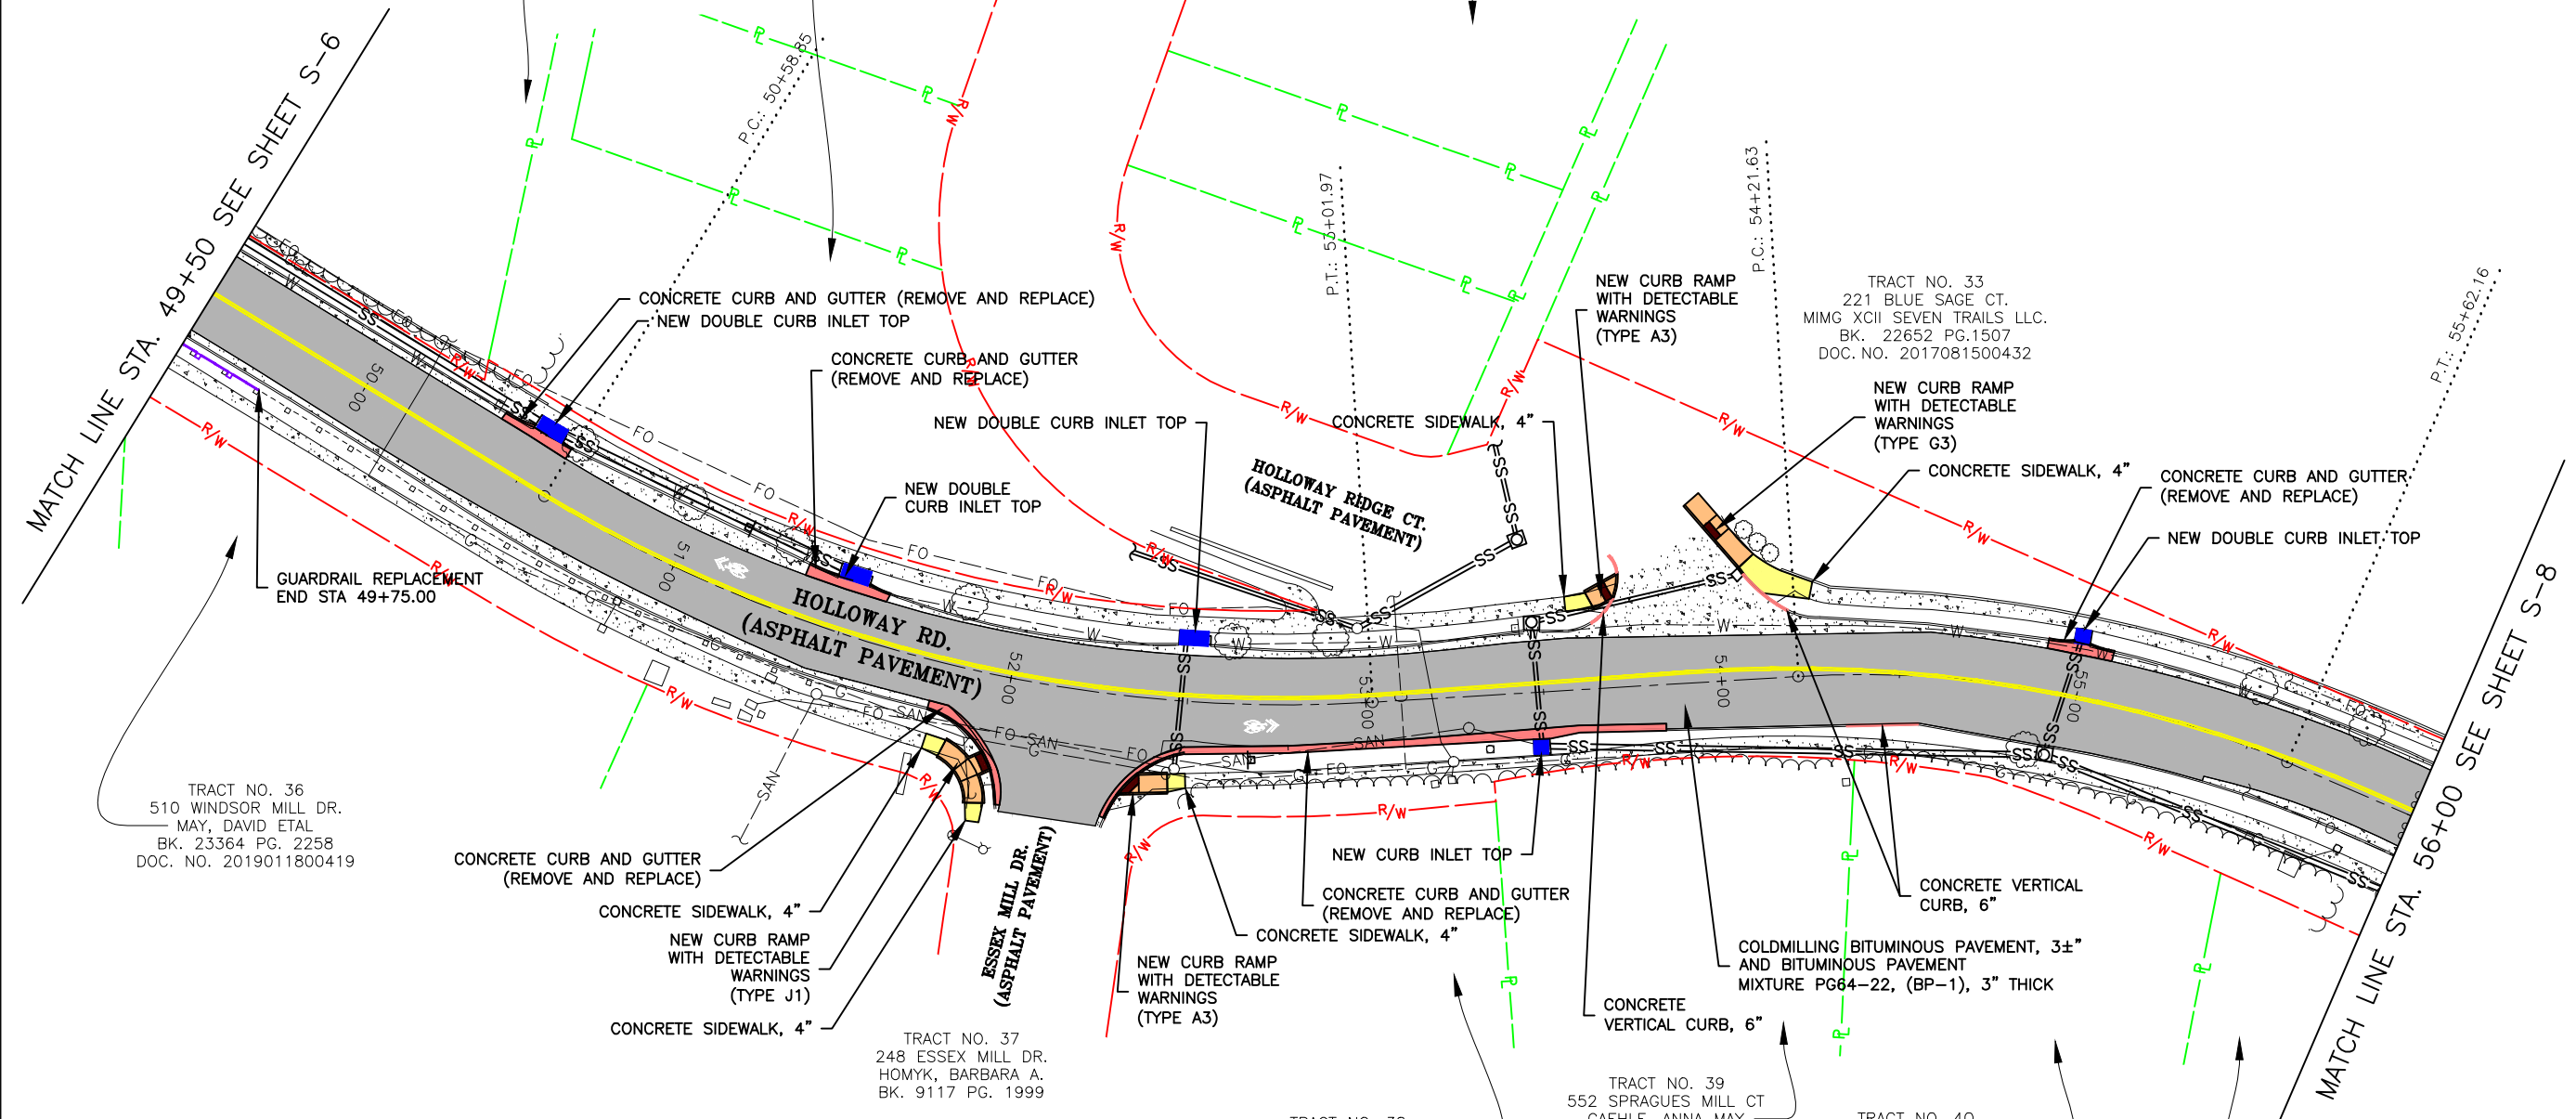

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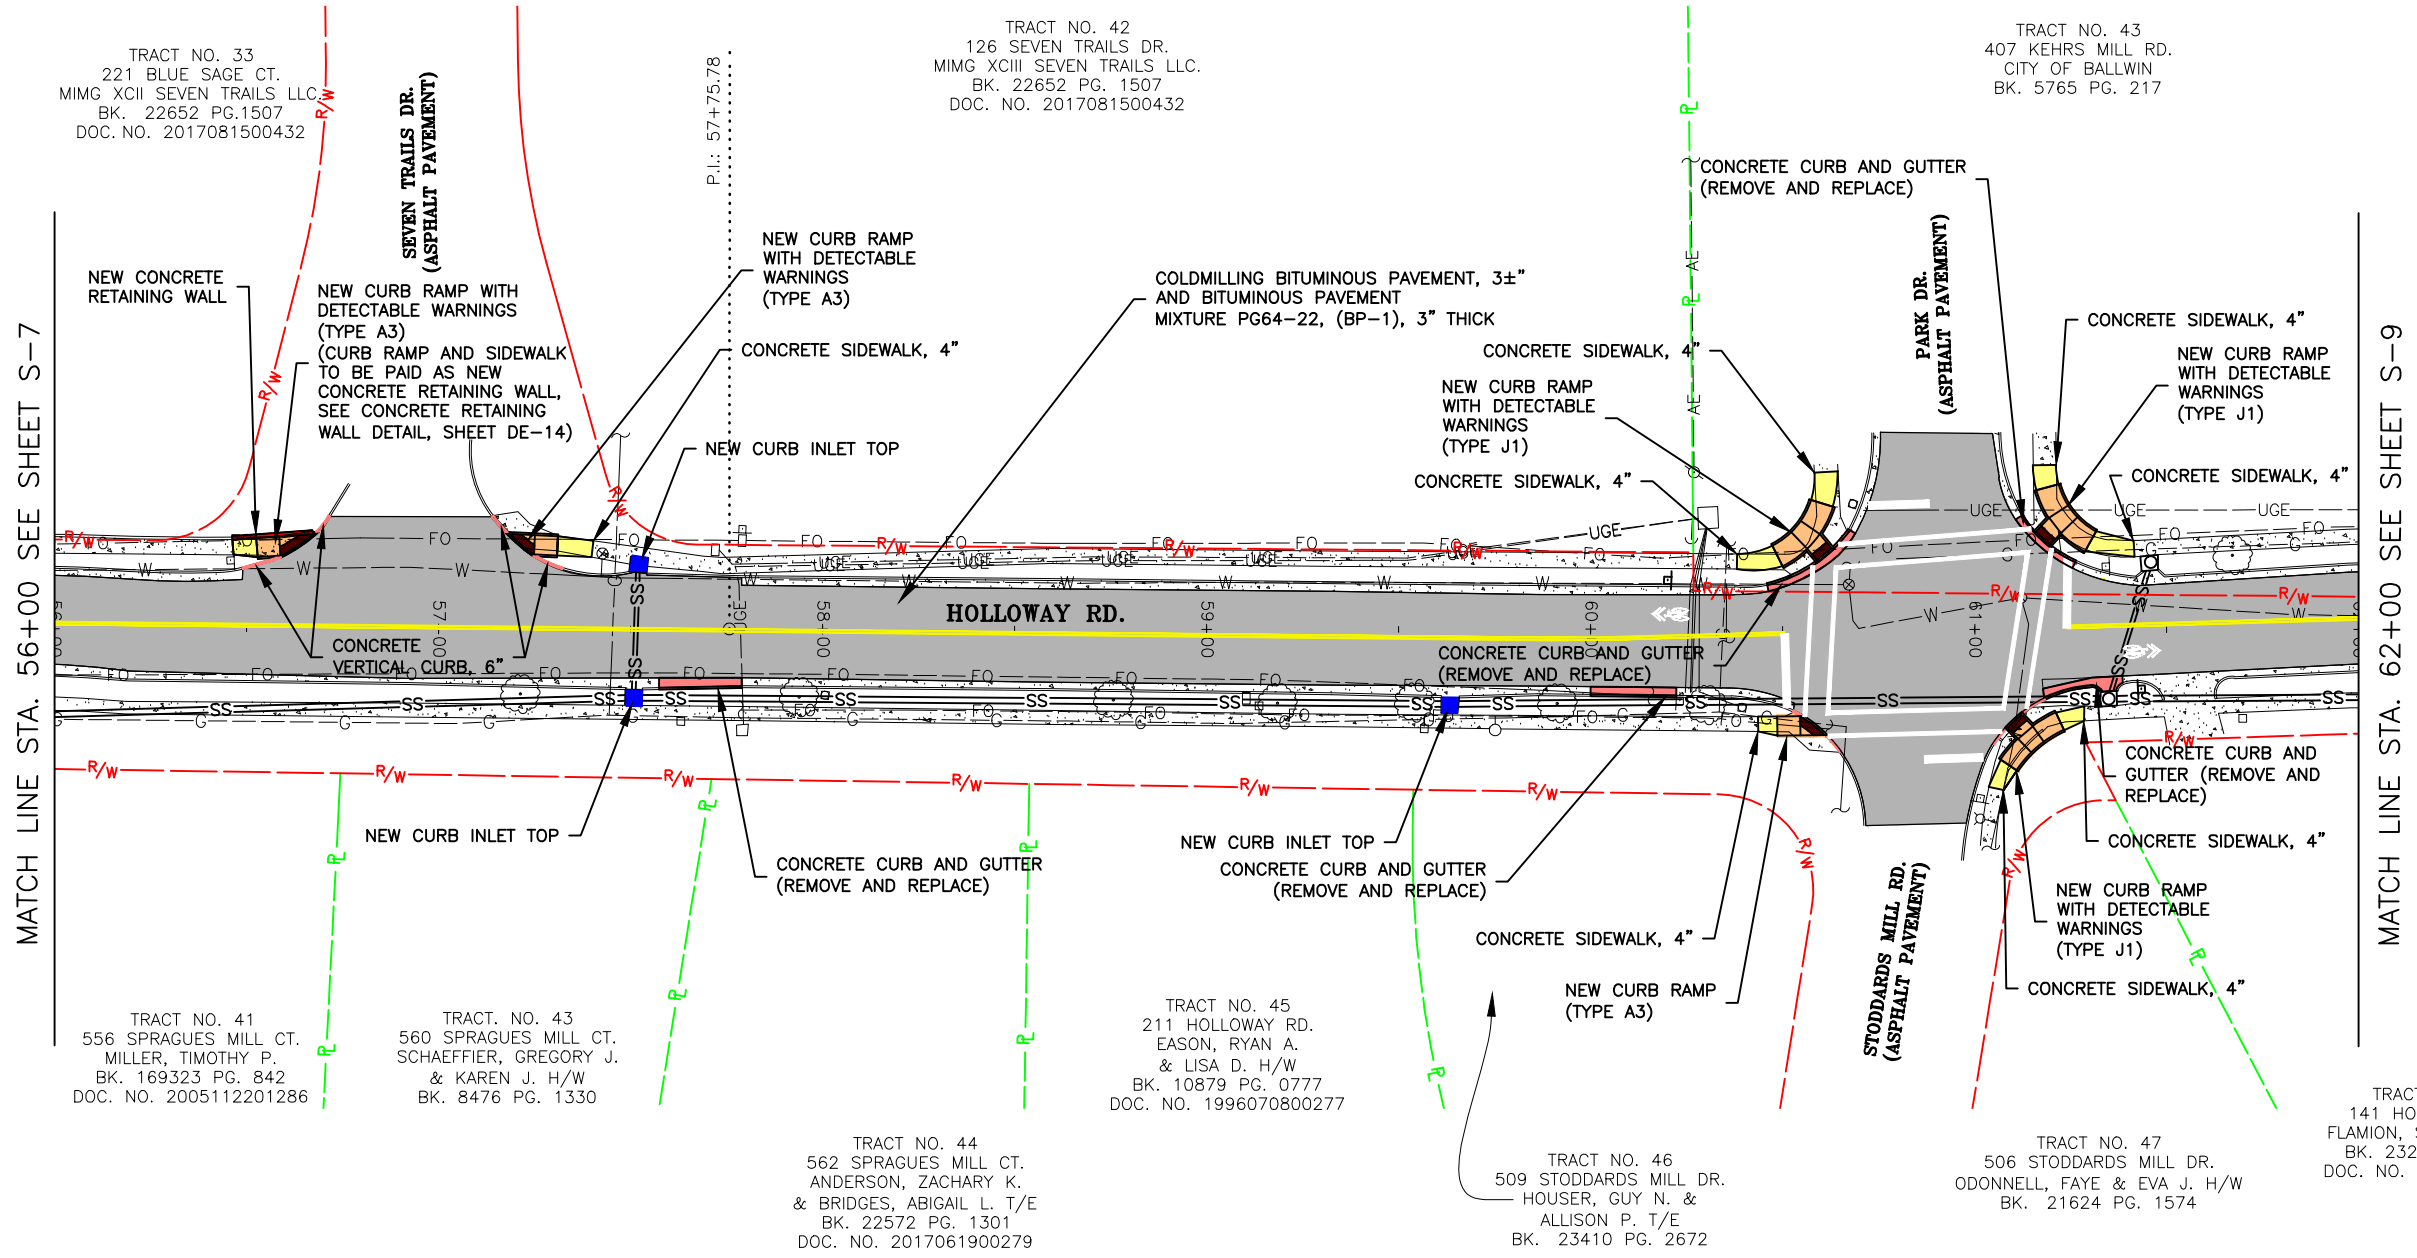
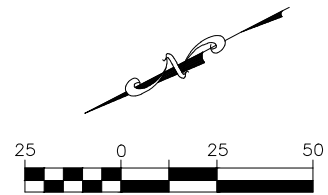
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CITY OF BALLWIN, MISSOURI

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DATE:	
JANUARY 2021	
SCALE:	
1" = 50'	
PROJ. NO.:	
SC19-981	
DWG. NO.:	
S-7	

SITE PLAN



MATCH LINE STA. 56+00 SEE SHEET S-7

MATCH LINE STA. 62+00 SEE SHEET S-9

TRACT NO. 33
221 BLUE SAGE CT.
MING XCII SEVEN TRAILS LLC
BK. 22652 PG.1507
DOC. NO. 2017081500432

TRACT NO. 42
126 SEVEN TRAILS DR.
MING XCIII SEVEN TRAILS LLC
BK. 22652 PG. 1507
DOC. NO. 2017081500432

TRACT NO. 43
407 KEHRS MILL RD.
CITY OF BALLWIN
BK. 5765 PG. 217

TRACT NO. 41
556 SPRAGUES MILL CT.
MILLER, TIMOTHY P.
BK. 169323 PG. 842
DOC. NO. 2005112201286

TRACT NO. 43
560 SPRAGUES MILL CT.
SCHAEFFIER, GREGORY J.
& KAREN J. H/W
BK. 8476 PG. 1330

TRACT NO. 44
562 SPRAGUES MILL CT.
ANDERSON, ZACHARY K.
& BRIDGES, ABIGAIL L. T/E
BK. 22572 PG. 1301
DOC. NO. 2017061900279

TRACT NO. 45
211 HOLLOWAY RD.
EASON, RYAN A.
& LISA D. H/W
BK. 10879 PG. 0777
DOC. NO. 1996070800277

TRACT NO. 46
509 STODDARDS MILL DR.
HOUSER, GUY N. &
ALLISON P. T/E
BK. 23410 PG. 2672

TRACT NO. 47
506 STODDARDS MILL DR.
ODONNELL, FAYE & EVA J. H/W
BK. 21624 PG. 1574

TRACT NO. 48
141 HOLLOWAY RD.
FLAMION, SARA TRUSTEE
BK. 23205 PG. 348
DOC. NO. 2018092000527

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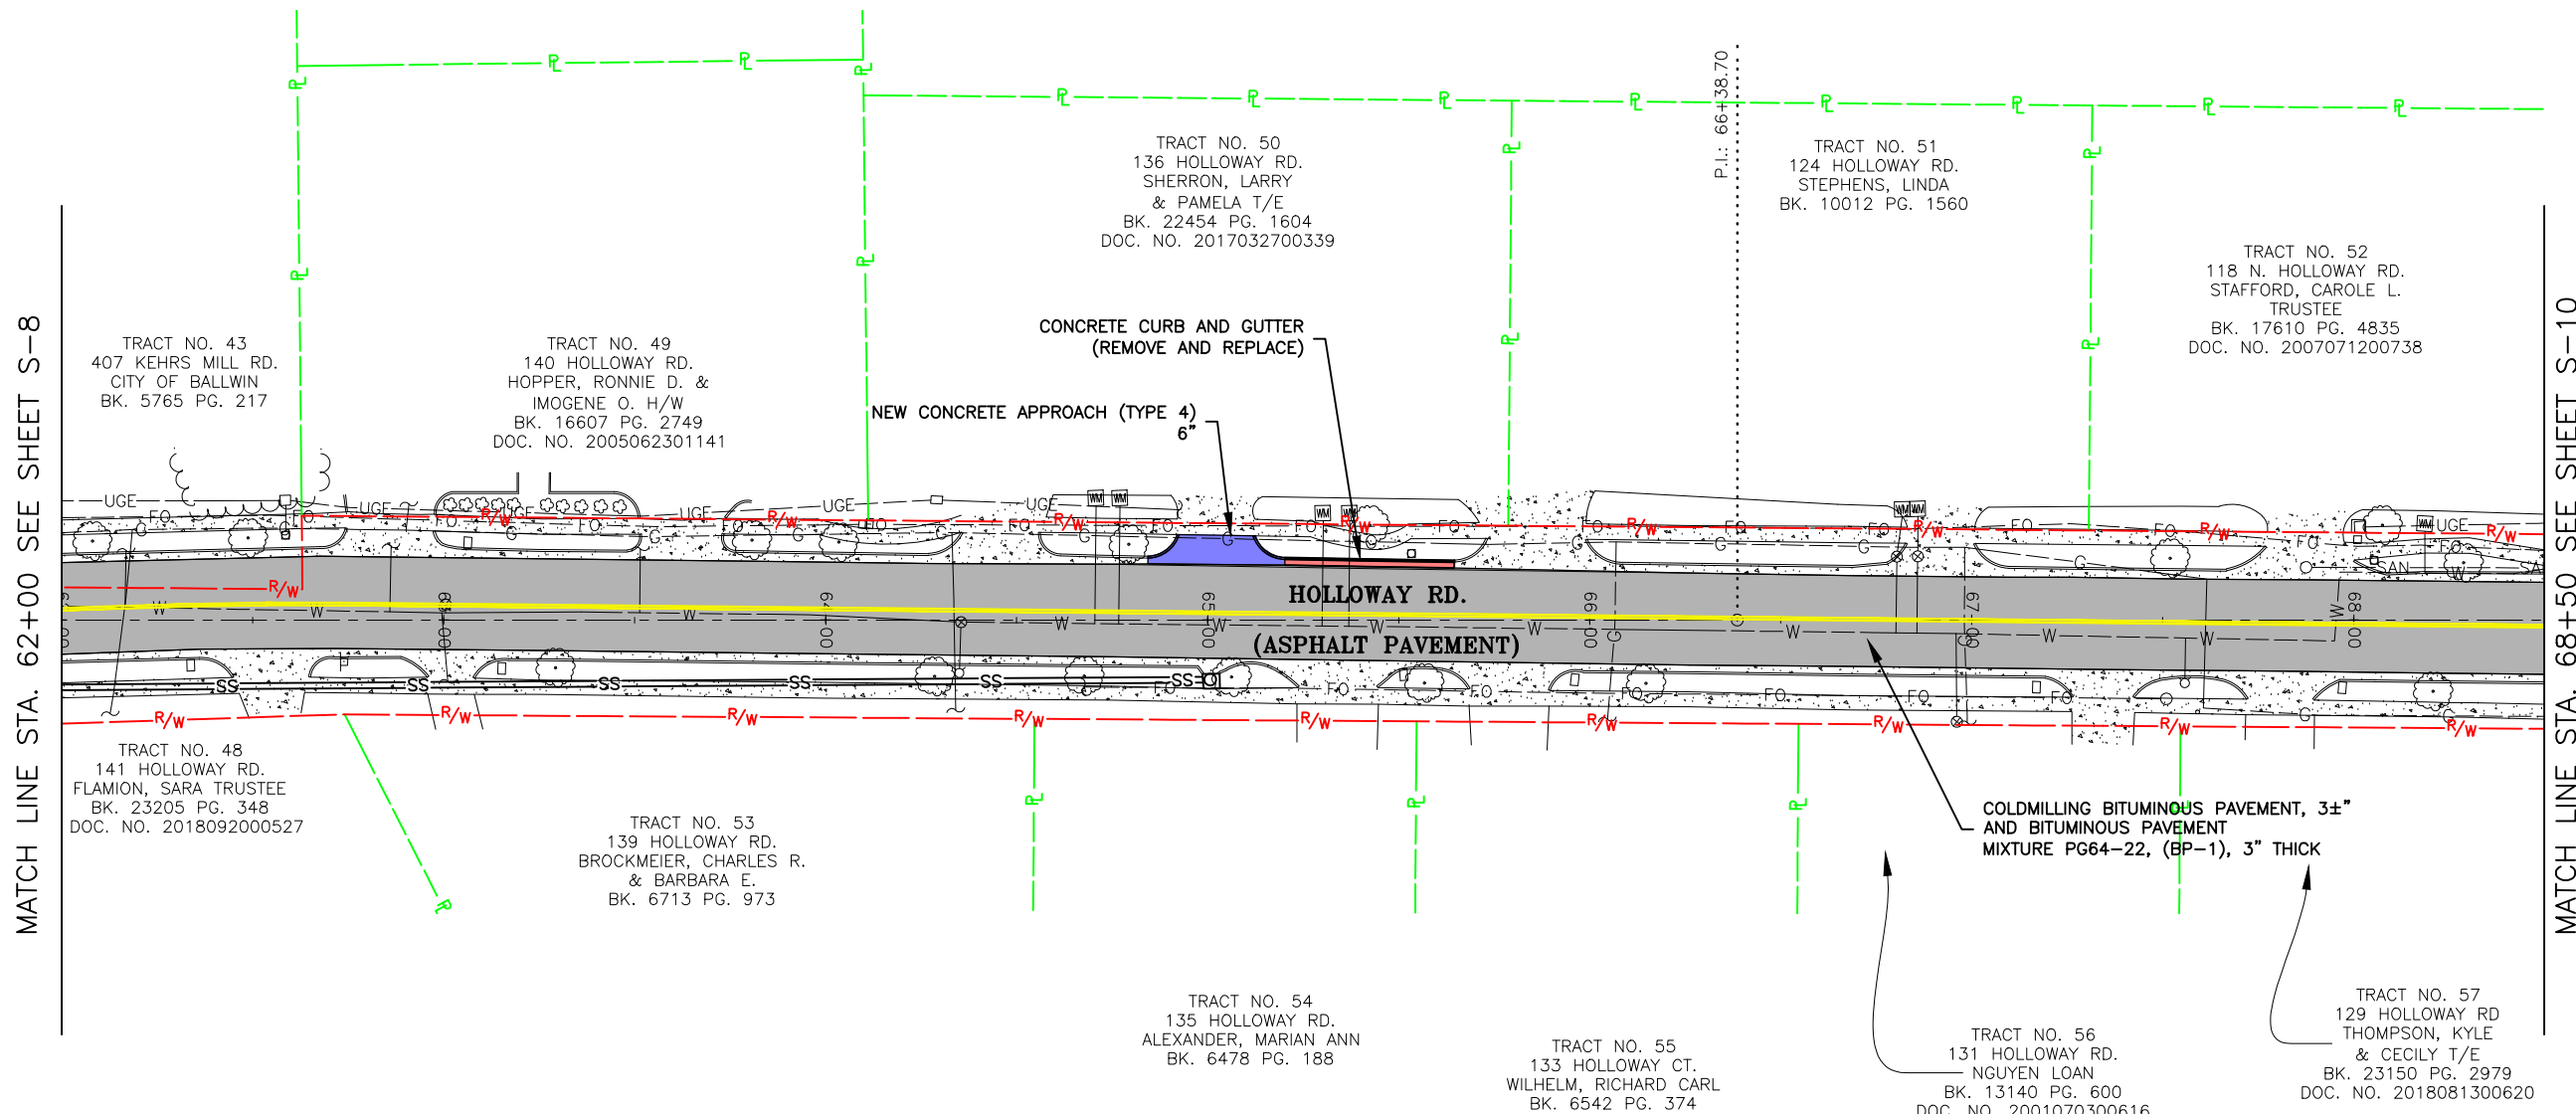
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DWG. NO.:	S-8

SITE PLAN



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MATCH LINE STA. 68+50 SEE SHEET S-10

TRACT NO. 43
407 KEHRS MILL RD.
CITY OF BALLWIN
BK. 5765 PG. 217

TRACT NO. 49
140 HOLLOWAY RD.
HOPPER, RONNIE D. &
IMOGENE O. H/W
BK. 16607 PG. 2749
DOC. NO. 2005062301141

TRACT NO. 50
136 HOLLOWAY RD.
SHERRON, LARRY
& PAMELA T/E
BK. 22454 PG. 1604
DOC. NO. 2017032700339

TRACT NO. 51
124 HOLLOWAY RD.
STEPHENS, LINDA
BK. 10012 PG. 1560

TRACT NO. 52
118 N. HOLLOWAY RD.
STAFFORD, CAROLE L.
TRUSTEE
BK. 17610 PG. 4835
DOC. NO. 2007071200738

TRACT NO. 48
141 HOLLOWAY RD.
FLAMION, SARA TRUSTEE
BK. 23205 PG. 348
DOC. NO. 2018092000527

TRACT NO. 53
139 HOLLOWAY RD.
BROCKMEIER, CHARLES R.
& BARBARA E.
BK. 6713 PG. 973

TRACT NO. 54
135 HOLLOWAY RD.
ALEXANDER, MARIAN ANN
BK. 6478 PG. 188

TRACT NO. 55
133 HOLLOWAY CT.
WILHELM, RICHARD CARL
BK. 6542 PG. 374

TRACT NO. 56
131 HOLLOWAY RD.
NGUYEN LOAN
BK. 13140 PG. 600
DOC. NO. 2001070300616

TRACT NO. 57
129 HOLLOWAY RD
THOMPSON, KYLE
& CECILY T/E
BK. 23150 PG. 2979
DOC. NO. 2018081300620

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STATE OF MISSOURI

KEVIN J. WOLFF P.E.

1/28/21

KEVIN J. WOLFF
NO. PE-200400889
STATE OF MISSOURI
REGISTERED PROFESSIONAL ENGINEER
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HOLLOWAY ROAD IMPROVEMENTS

FEDERAL PROJECT NO. STP-4939(608)

CITY OF BALLWIN, MISSOURI

DATE	REVISION

DWN BY: K.J.W. APPD BY: M.D.S.



DATE: JANUARY 2021

SCALE: 1" = 50'

PROJ. NO.: SC19-981

DWG. NO.: S-9

SITE PLAN

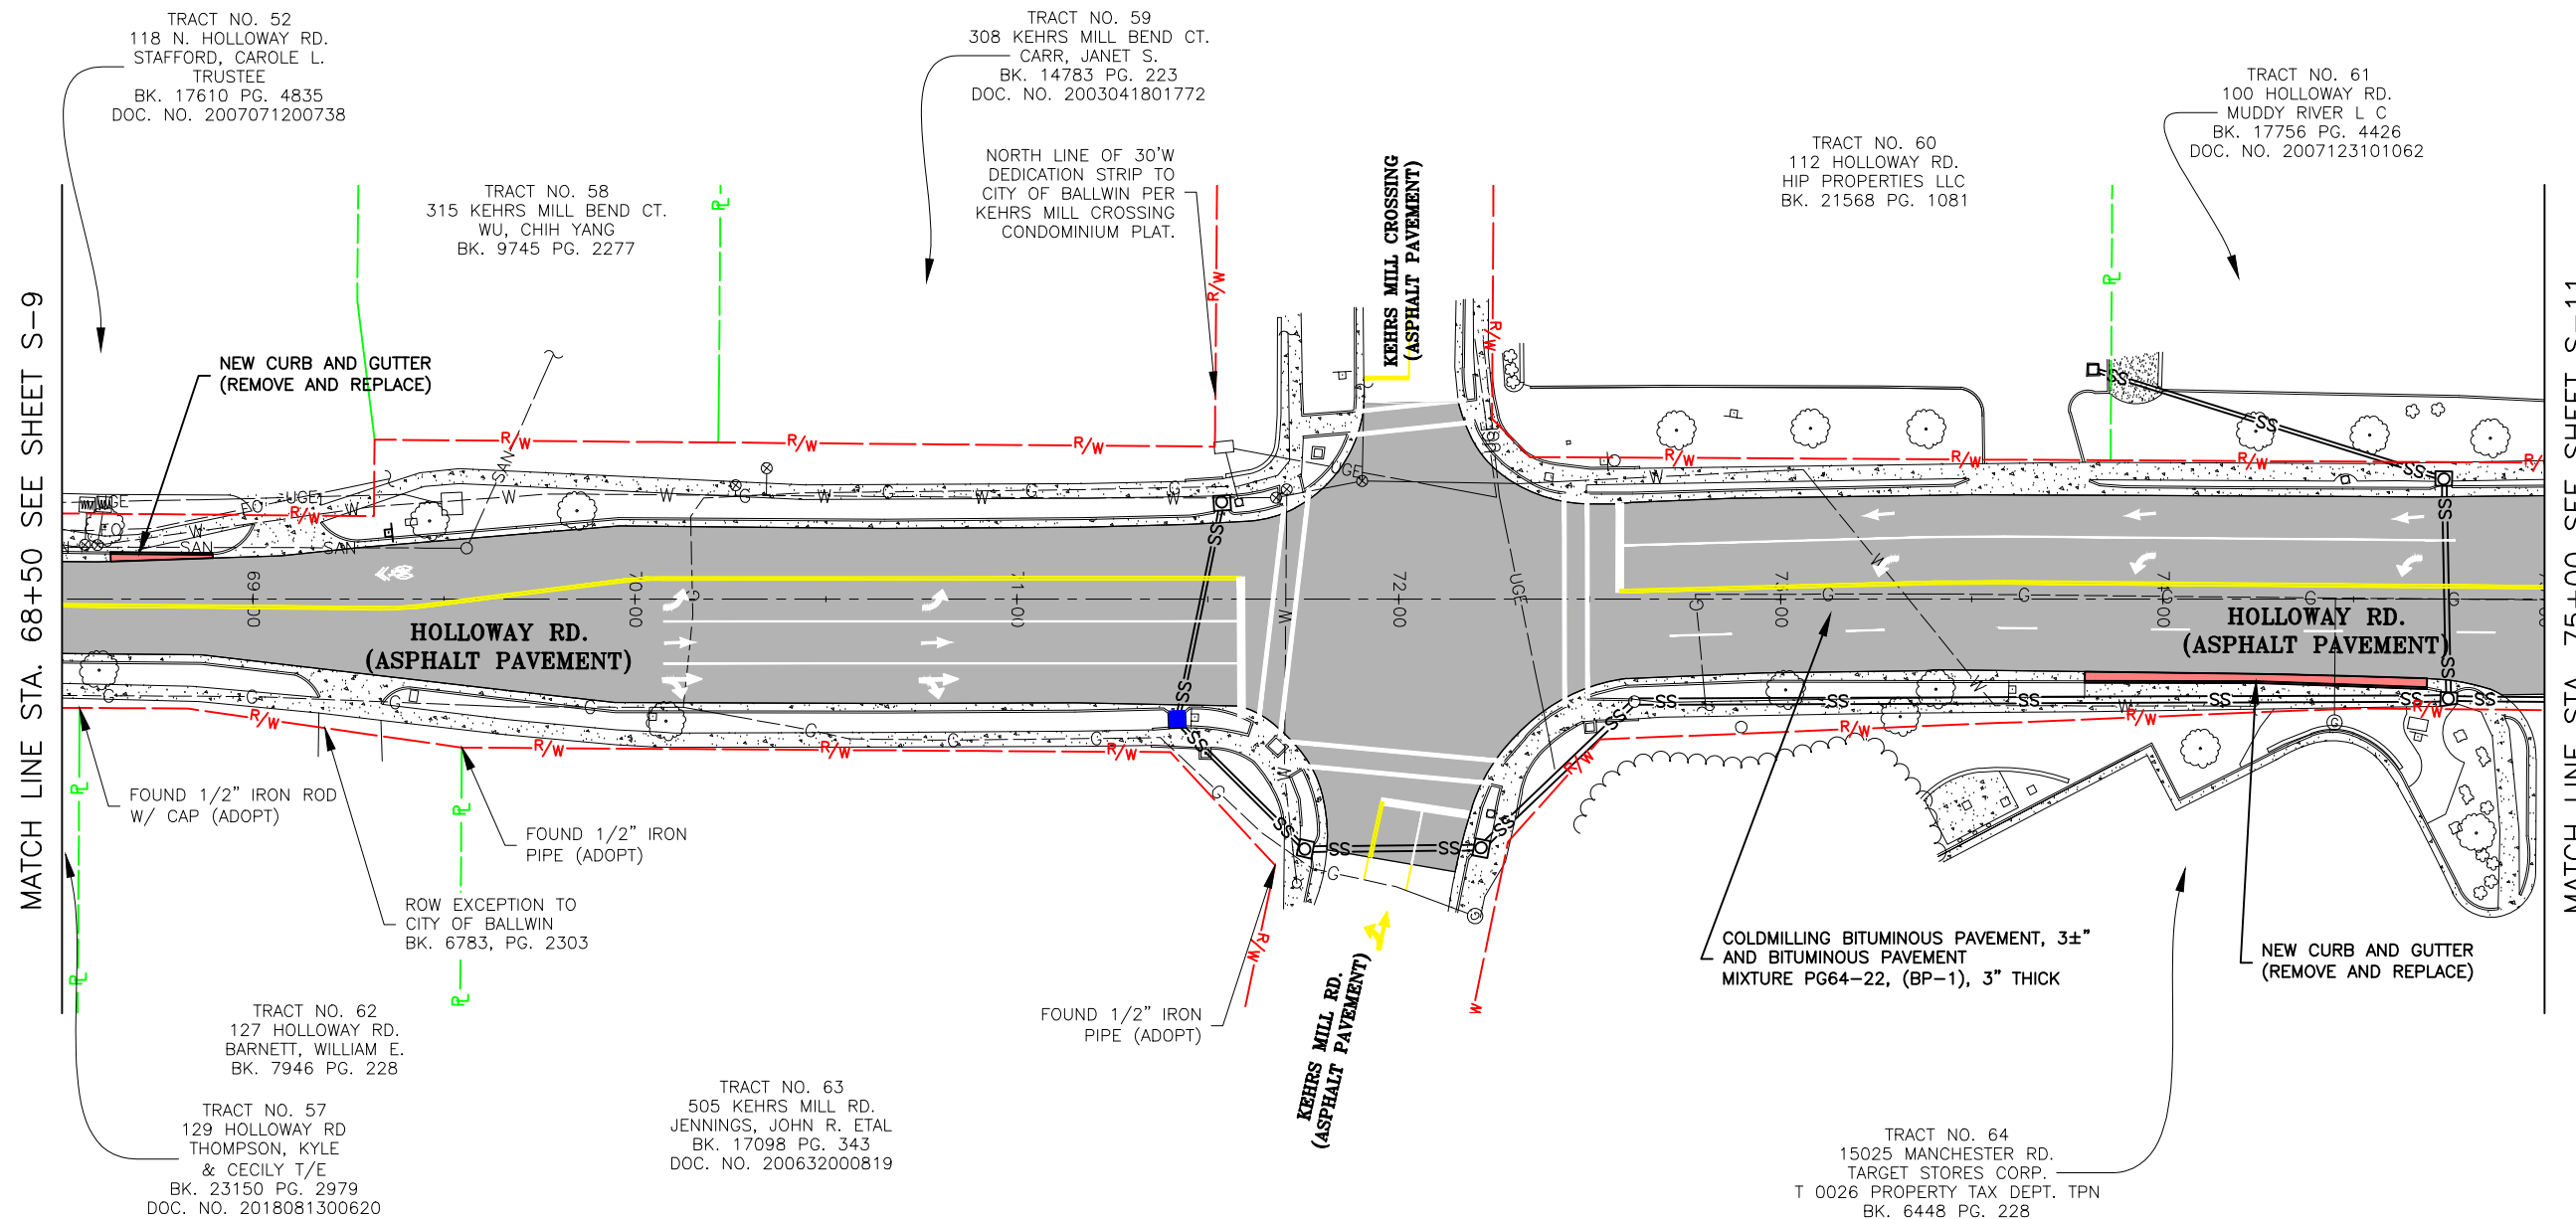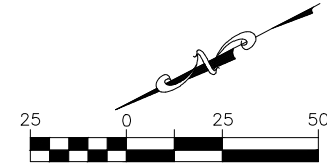

MATCH LINE STA. 68+50 SEE SHEET S-9

MATCH LINE STA. 75+00 SEE SHEET S-11

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N. J. Wolff
PE 200400889

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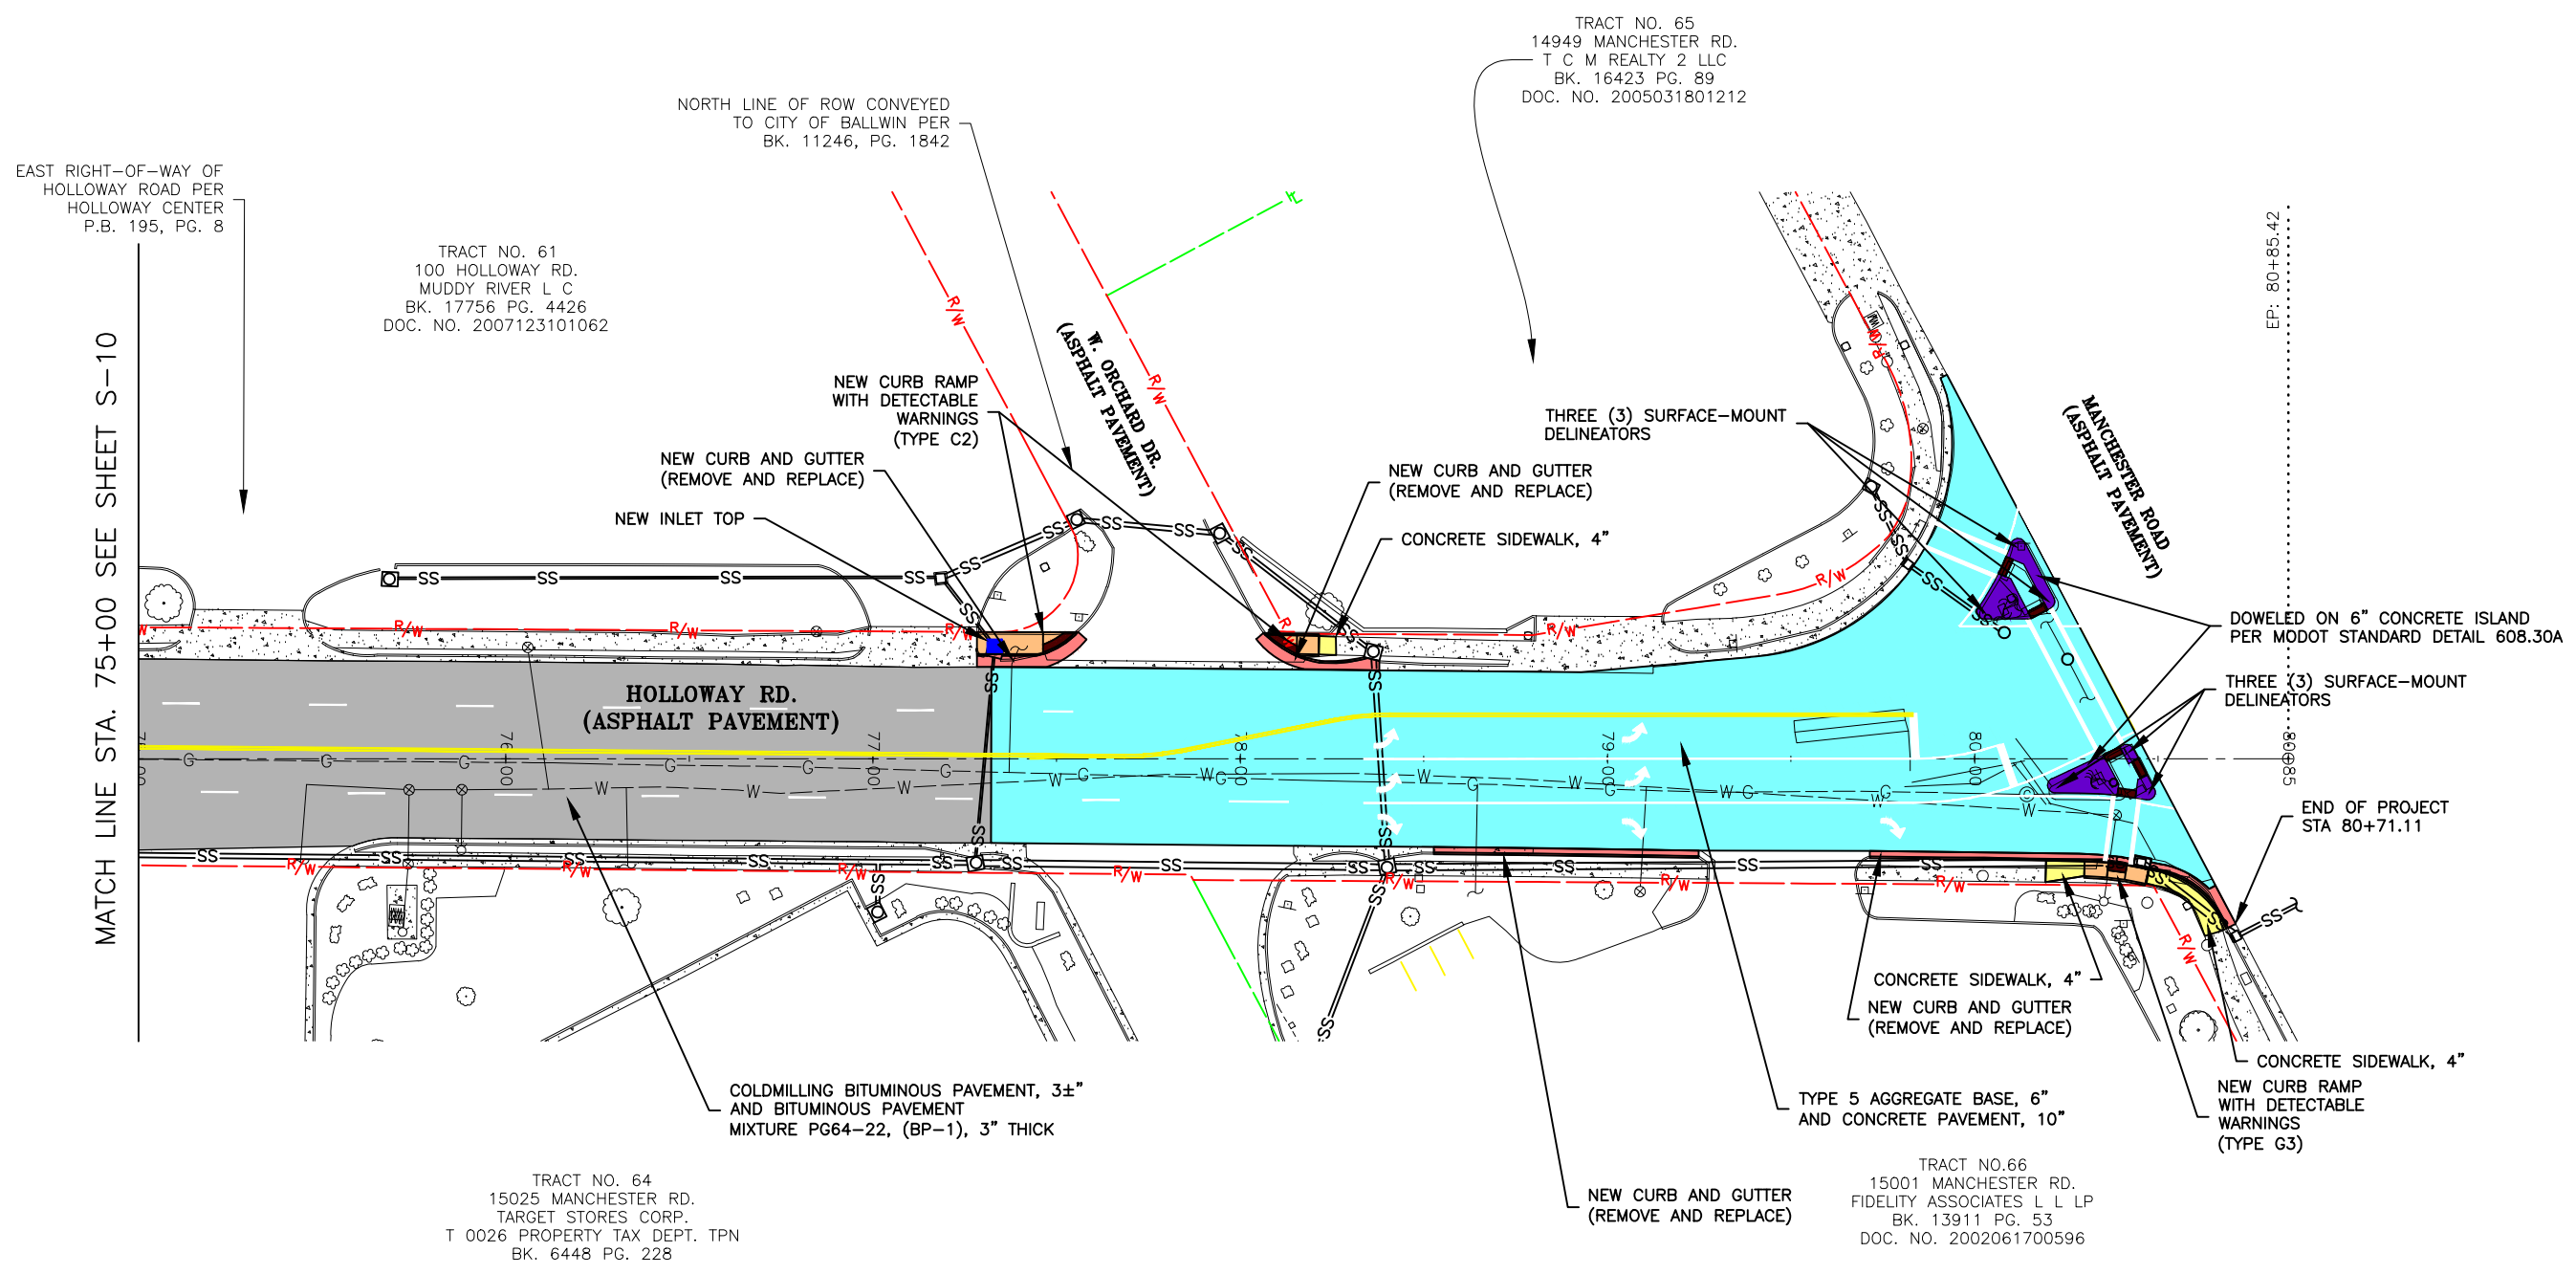
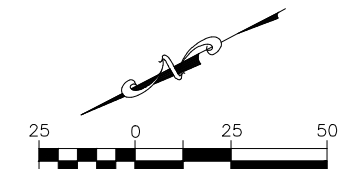
HOLLOWAY ROAD IMPROVEMENTS
FEDERAL PROJECT NO. STP-4939(608)
CITY OF BALLWIN, MISSOURI

DATE	REVISION

DWN. BY: K.J.W. APPD. BY: M.D.S.
DATE: JANUARY 2021
SCALE: 1" = 50'
PROJ. NO: SC19-981
DWG. NO: S-10

Drawing name: U:\SC19-981 Holloway Road, Ballwin, MO\AUTOCAD DRAWINGS\SITE PLAN.dwg Tab: S-10 Plotted on: Feb 09, 2021 - 10:29am Plotted by: kwofff

SITE PLAN



MATCH LINE STA. 75+00 SEE SHEET S-10

EP: 80+85.42

END OF PROJECT STA 80+71.11

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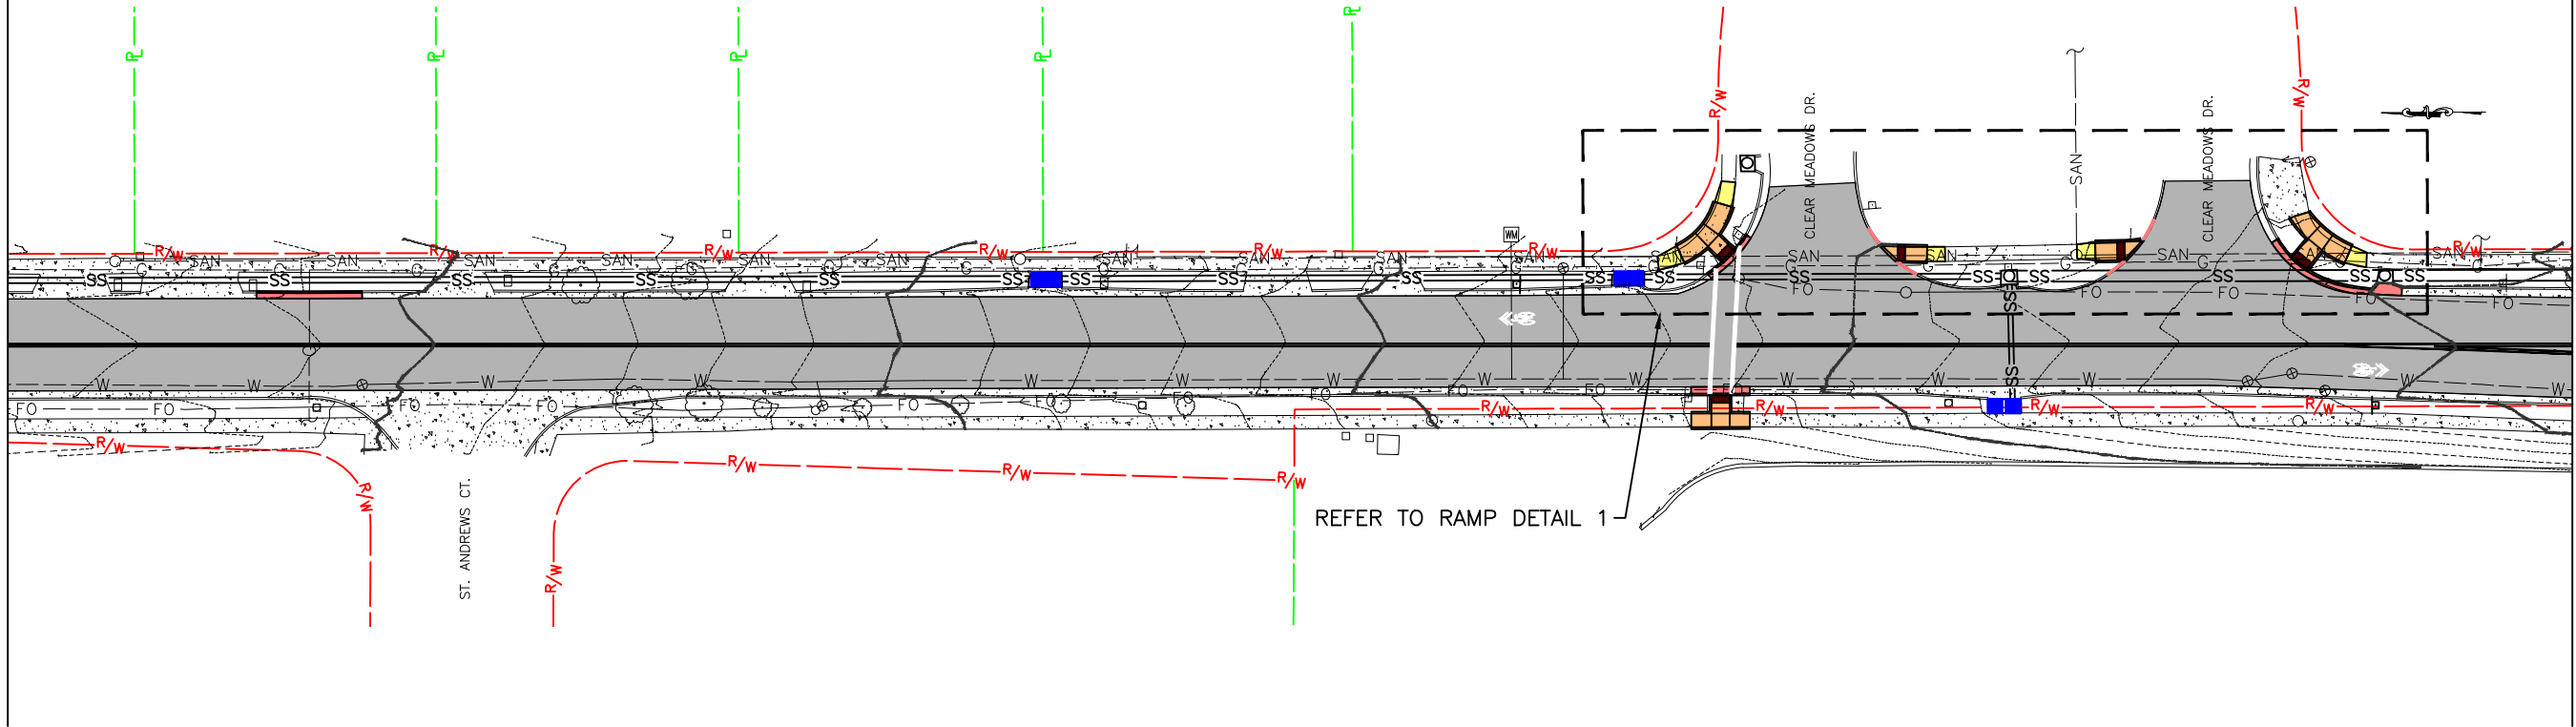
HOLLOWAY ROAD IMPROVEMENTS
FEDERAL PROJECT NO. STP-4939(608)
CITY OF BALLWIN, MISSOURI

DATE	REVISION


DWN BY: K.J.W.	APPD BY: M.D.S.
DATE: JANUARY 2021	
SCALE: 1" = 50'	
PROJ. NO: SC19-981	
DWG. NO: S-11	

Drawing name: U:\SC19-981 Holloway Road, Ballwin, MO\AUTOCAD DRAWINGS\SITE PLAN.dwg Tab: S-11 Plotted on: Feb 09, 2021 - 10:29am Plotted by: kwelff

MATCH LINE STA. 30+00 SEE SHEET S-3



MATCH LINE STA. 37+00 SEE SHEET S-5

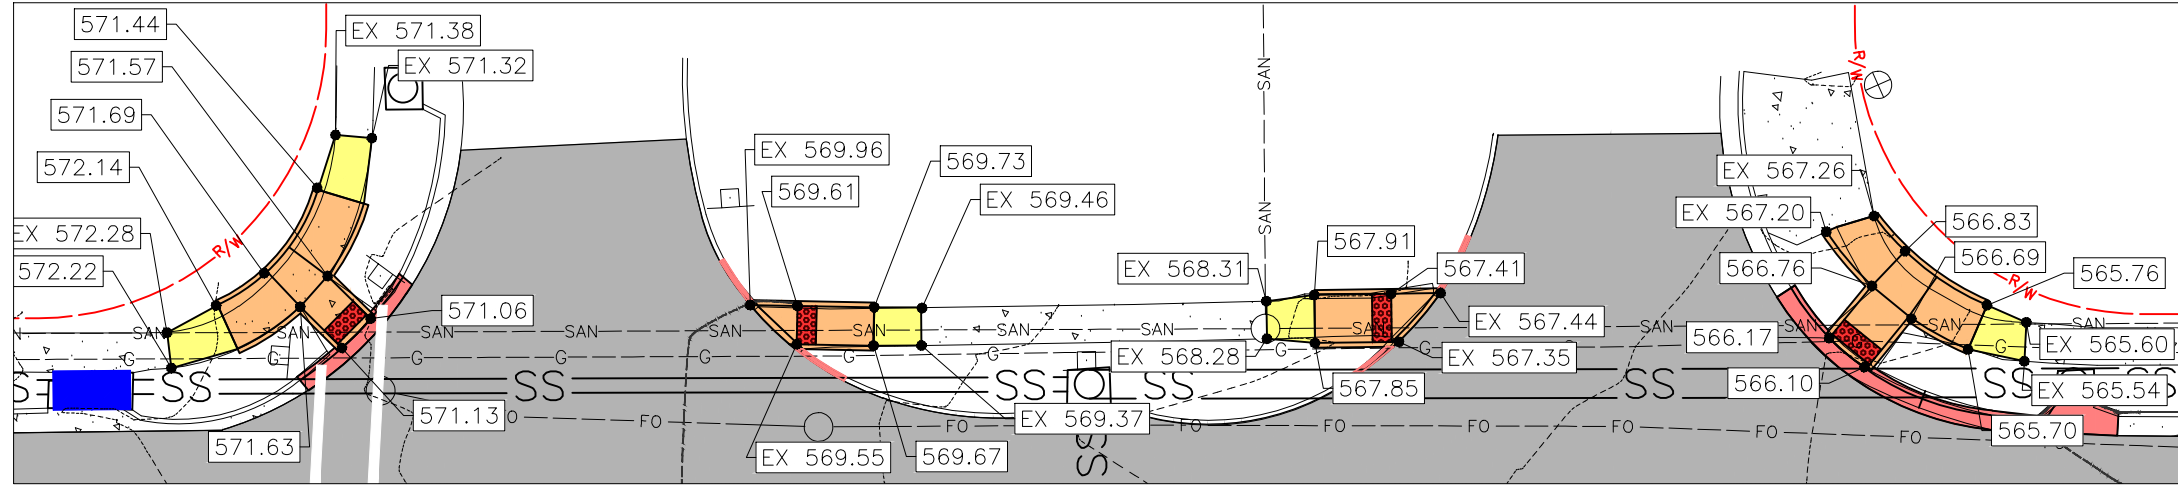

ENLARGED RAMP DETAIL 1
1"=20'

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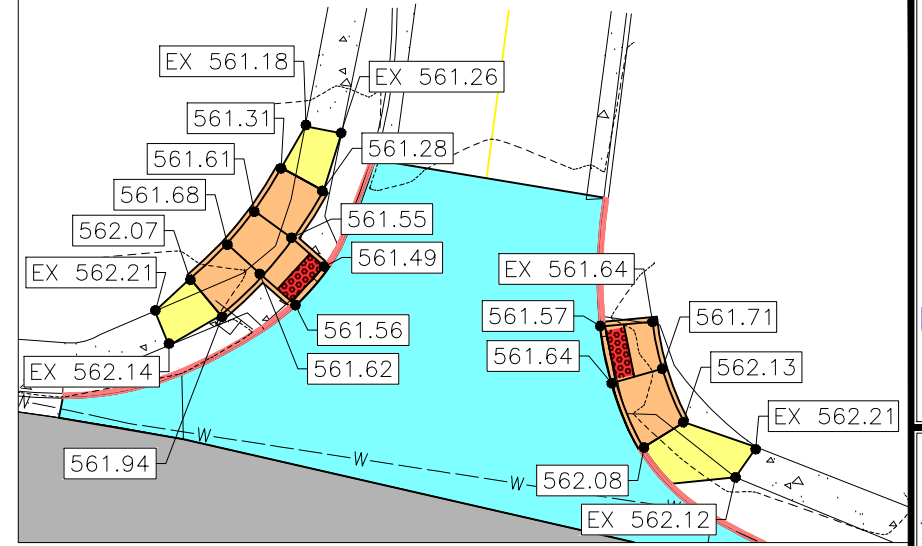
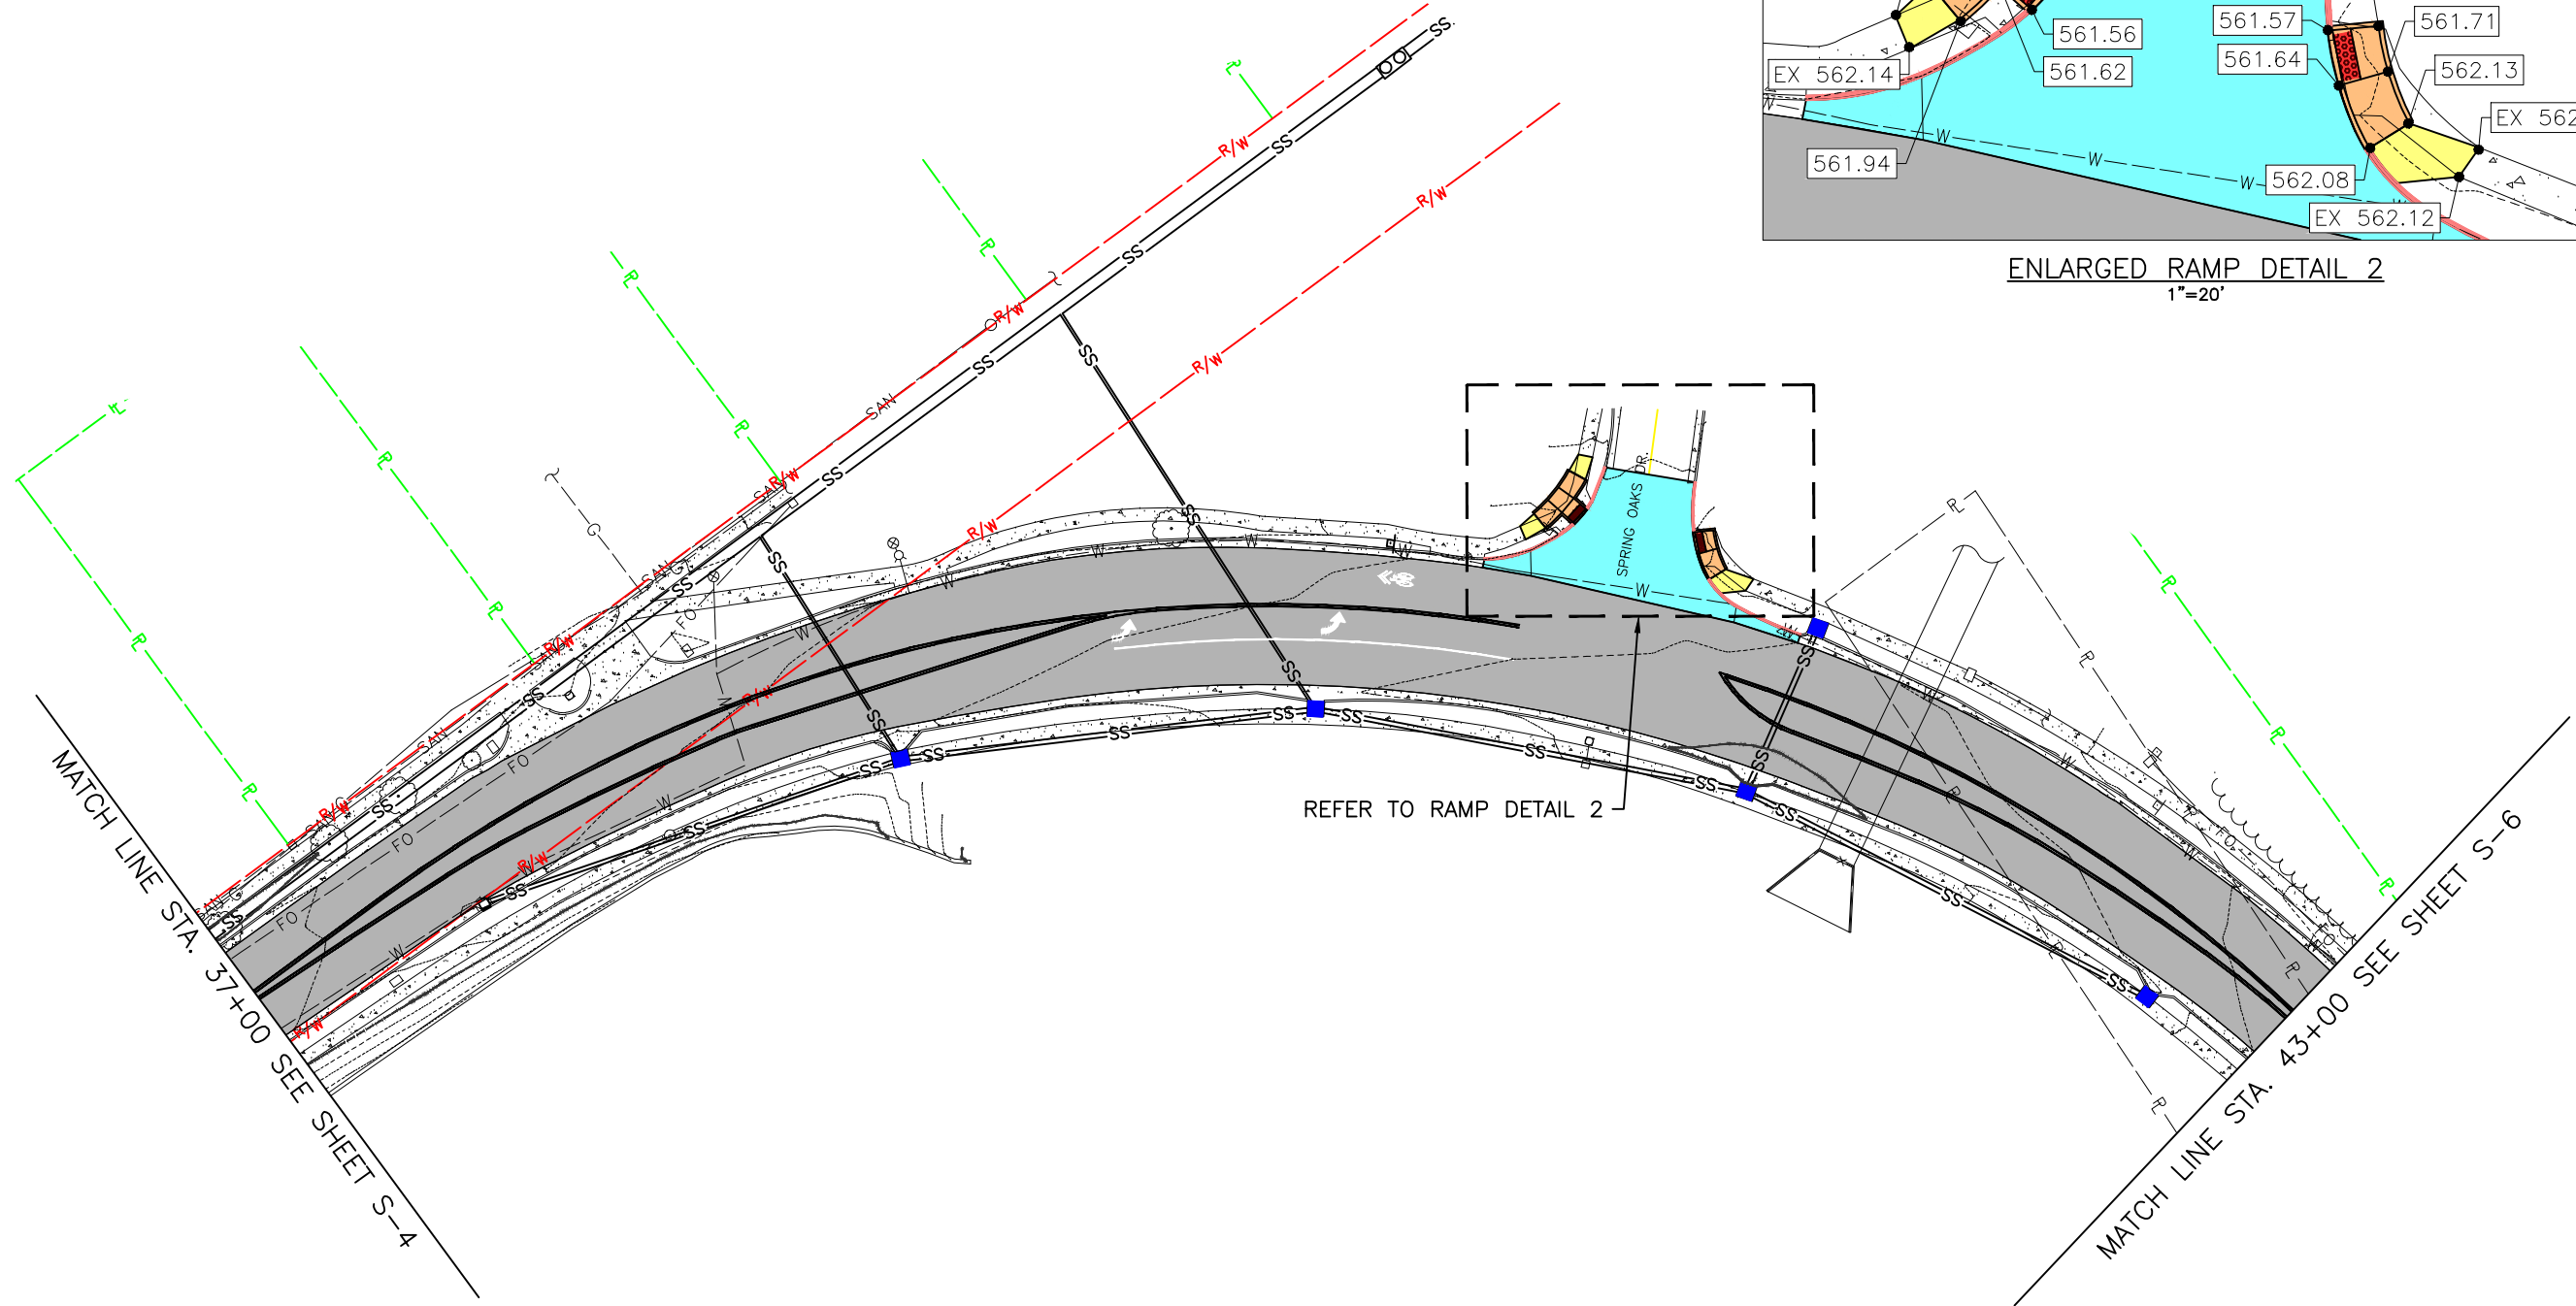
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FEDERAL PROJECT NO. STP-4939(608)
CITY OF BALLWIN, MISSOURI

DATE	REVISION

DWN. BY: K.J.W. APPD. BY: M.D.S.
DATE: JANUARY 2021
SCALE: 1" = 20'
PROJ. NO: SC19-981
DWG. NO: C-1

Drawing name: I:\SC19-981 Holloway Road, Ballwin, MO\AUTOCAD DRAWINGS\GRADING PLAN.dwg Tab: C-2 Plotted on: Feb 09, 2021 - 10:30am Plotted by: kwolff



ENLARGED RAMP DETAIL 2
1"=20'

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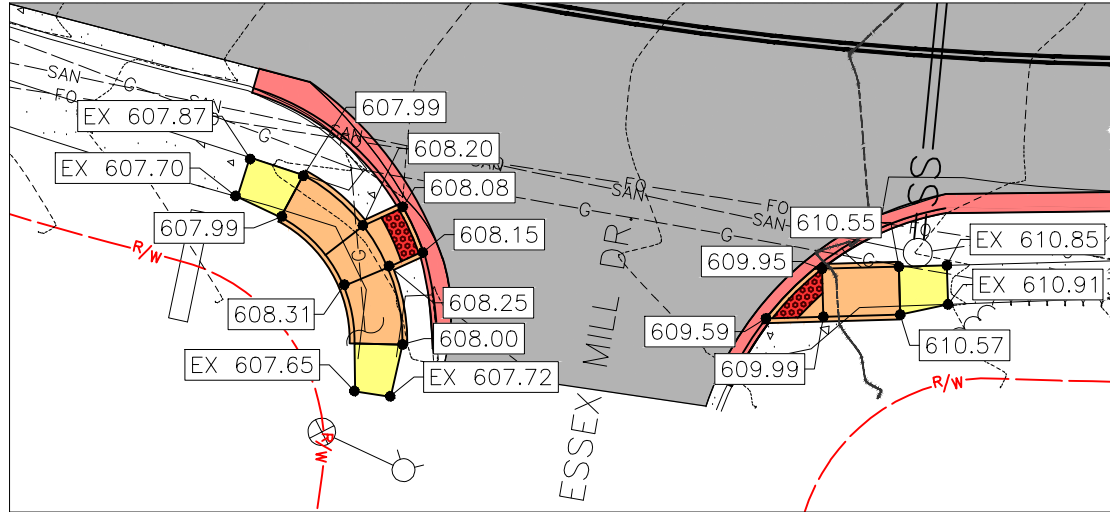
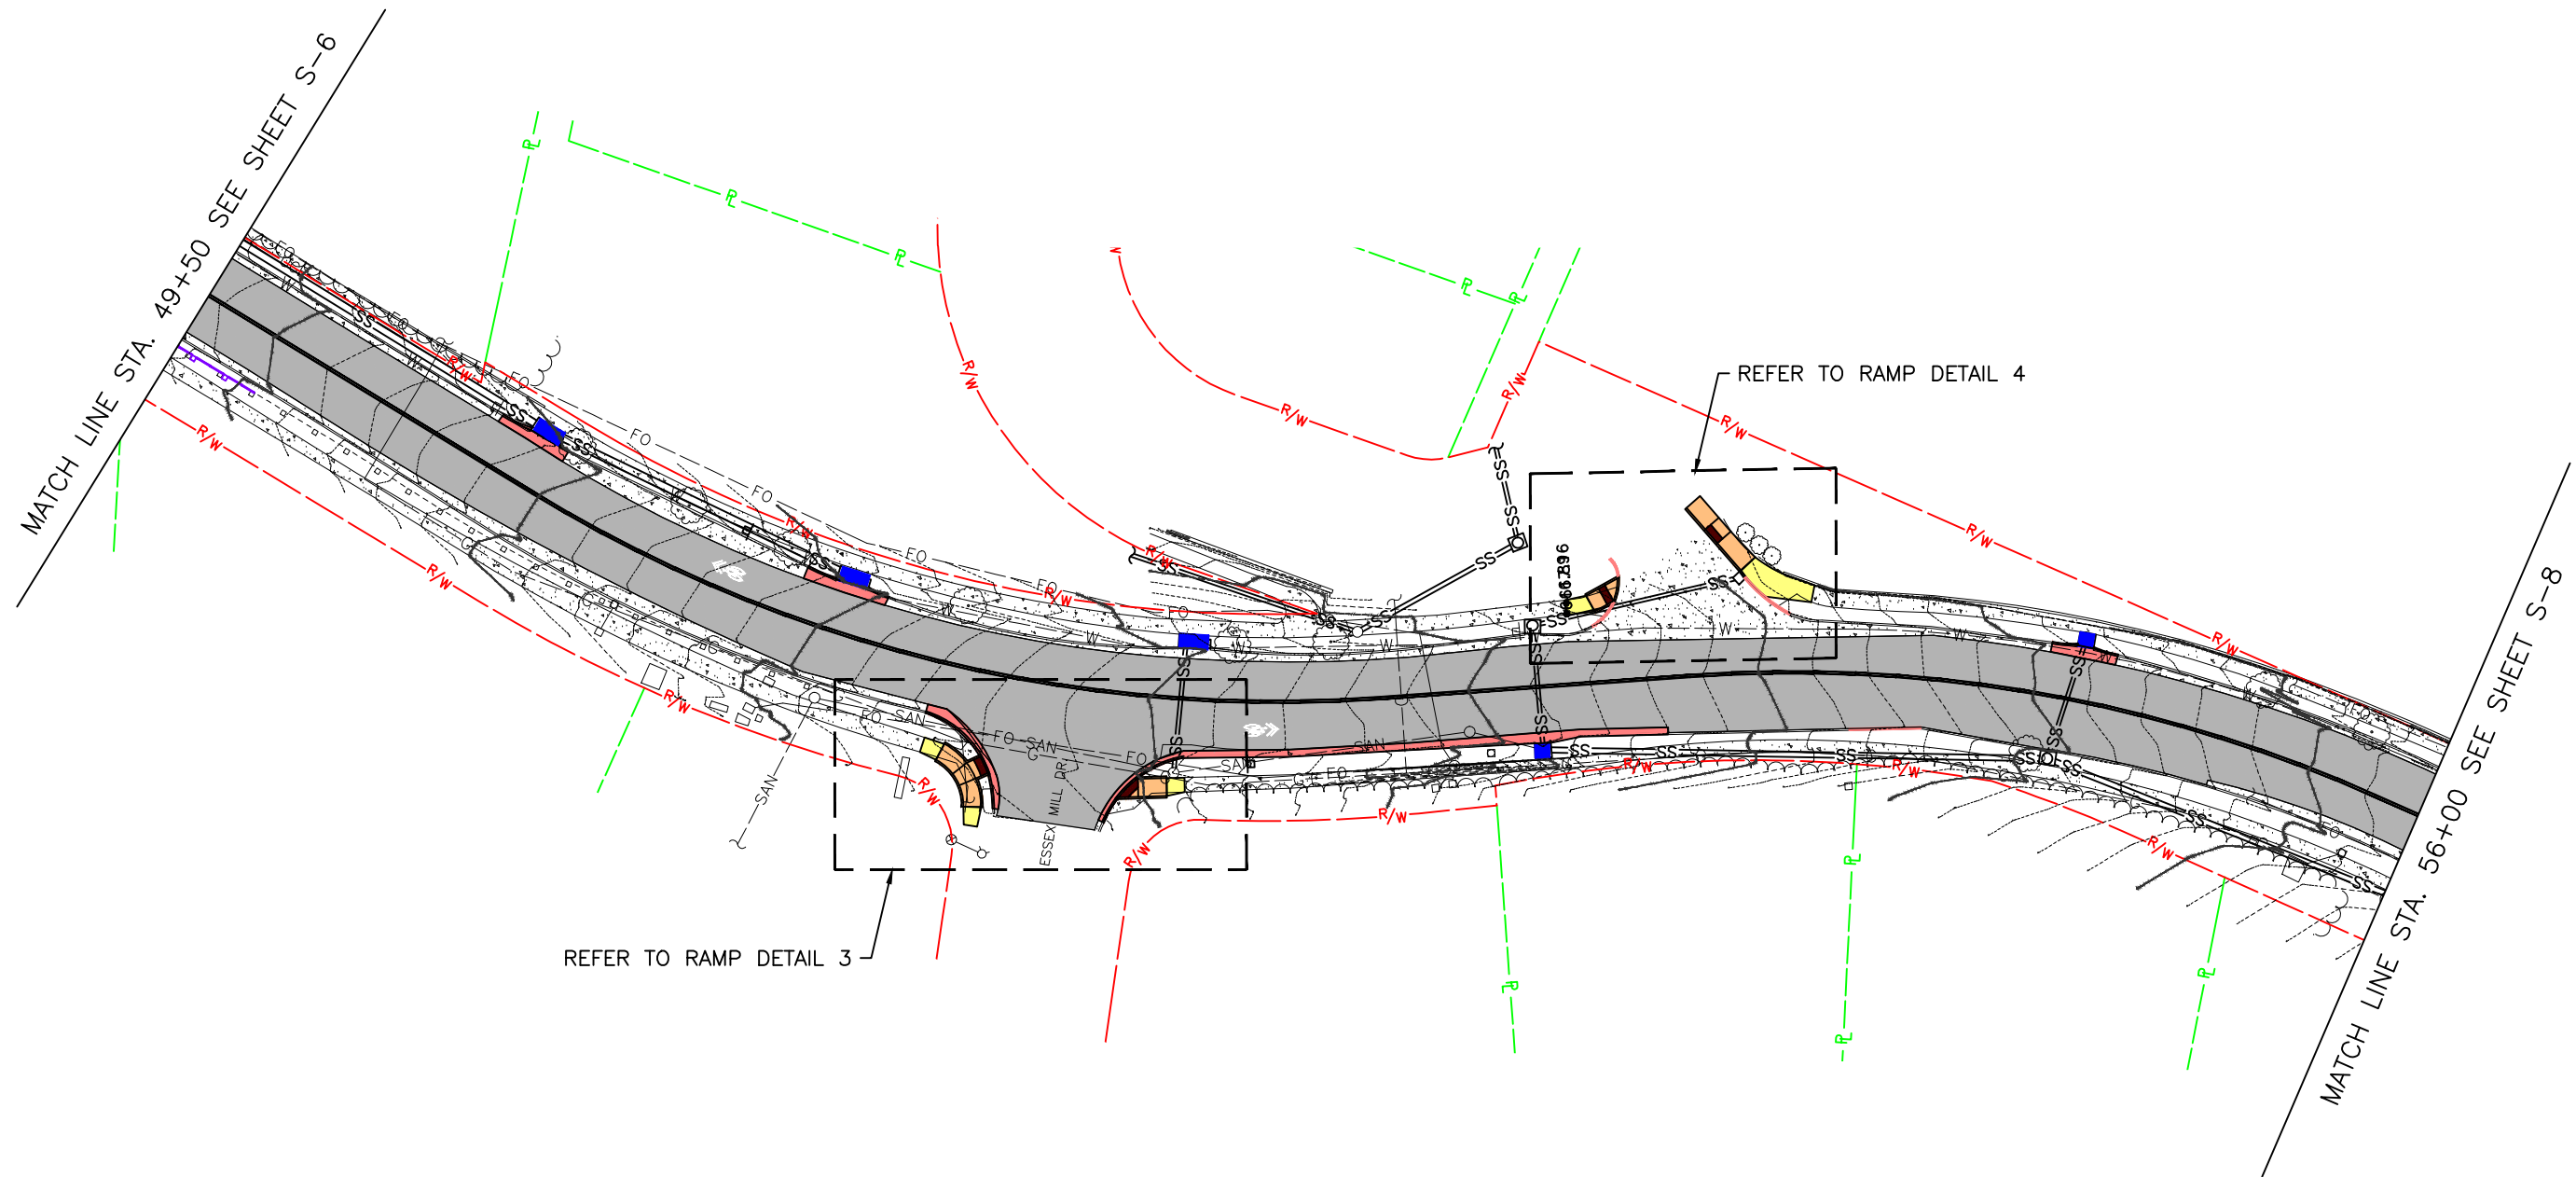
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FEDERAL PROJECT NO. STP-4939(608)
CITY OF BALLWIN, MISSOURI


DATE	REVISION

DWN. BY:	APPD. BY:
K.J.W.	M.D.S.
DATE:	DATE:
JANUARY 2021	
SCALE:	
1" = 50'	
PROJ. NO.:	
SC19-981	
DWG. NO.:	
C-2	

Drawing name: I:\SC19-981 Holloway Road, Ballwin, MO\AUTOCAD DRAWINGS\GRADING PLAN.dwg Tab: C-3 Plotted on: Feb 09, 2021 - 10:30am Plotted by: kwolff



ENLARGED RAMP DETAIL 3
1"=20'

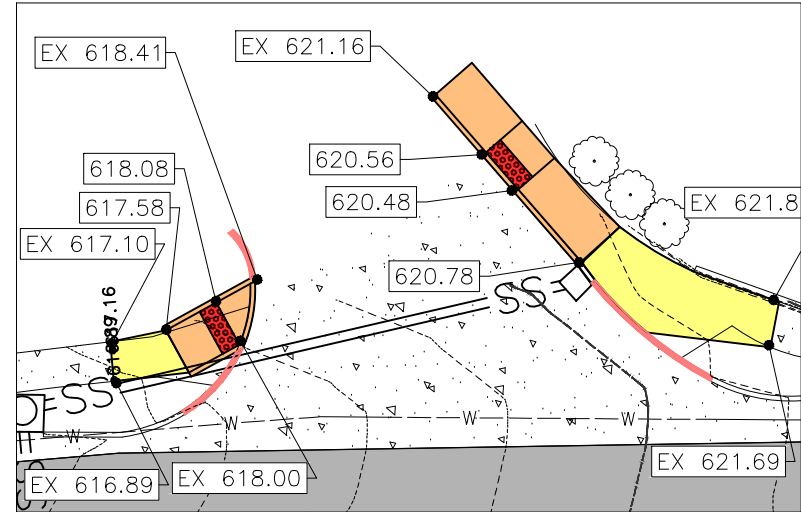

ENLARGED RAMP DETAIL 4
1"=20'

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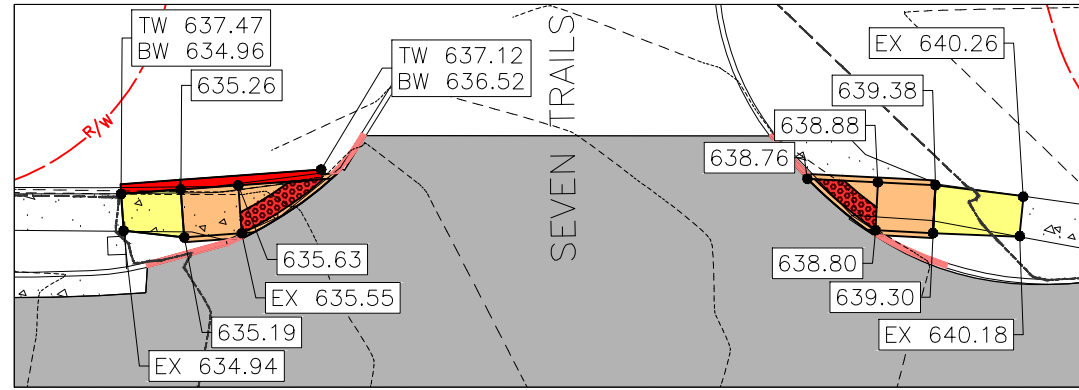
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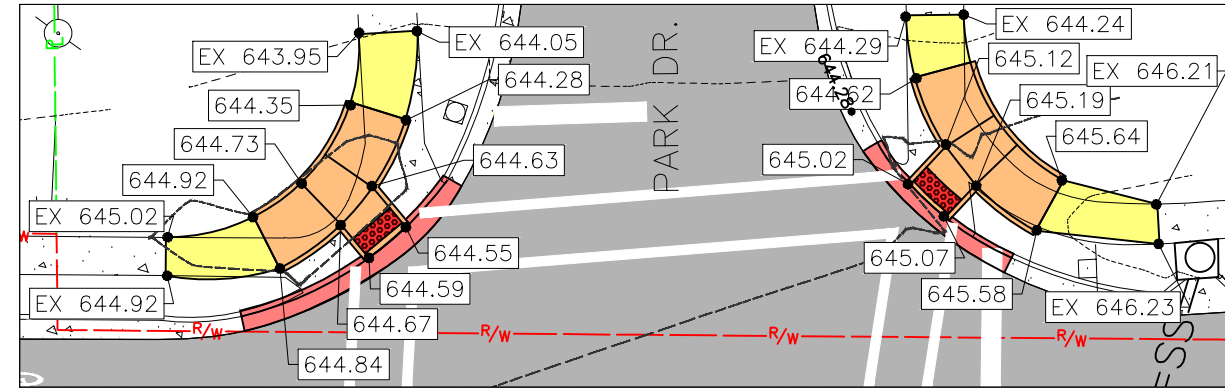
HOLLOWAY ROAD IMPROVEMENTS
FEDERAL PROJECT NO. STP-4939(608)
CITY OF BALLWIN, MISSOURI

DATE:	REVISION:
DWN. BY:	APPD. BY:
K.J.W.	M.D.S.
DATE:	JANUARY 2021
SCALE:	1" = 20'
PROJ. NO.:	SC19-981
DWG. NO.:	C-3


Drawing name: I:\SC19-981 Holloway Road, Ballwin, MD\AUTOCAD DRAWINGS\GRADING PLAN.dwg Tab: C-4 Plotted on: Feb 09, 2021 - 10:30am Plotted by: kweliff



ENLARGED RAMP DETAIL 5
1"=20'




ENLARGED RAMP DETAIL 6
1"=20'

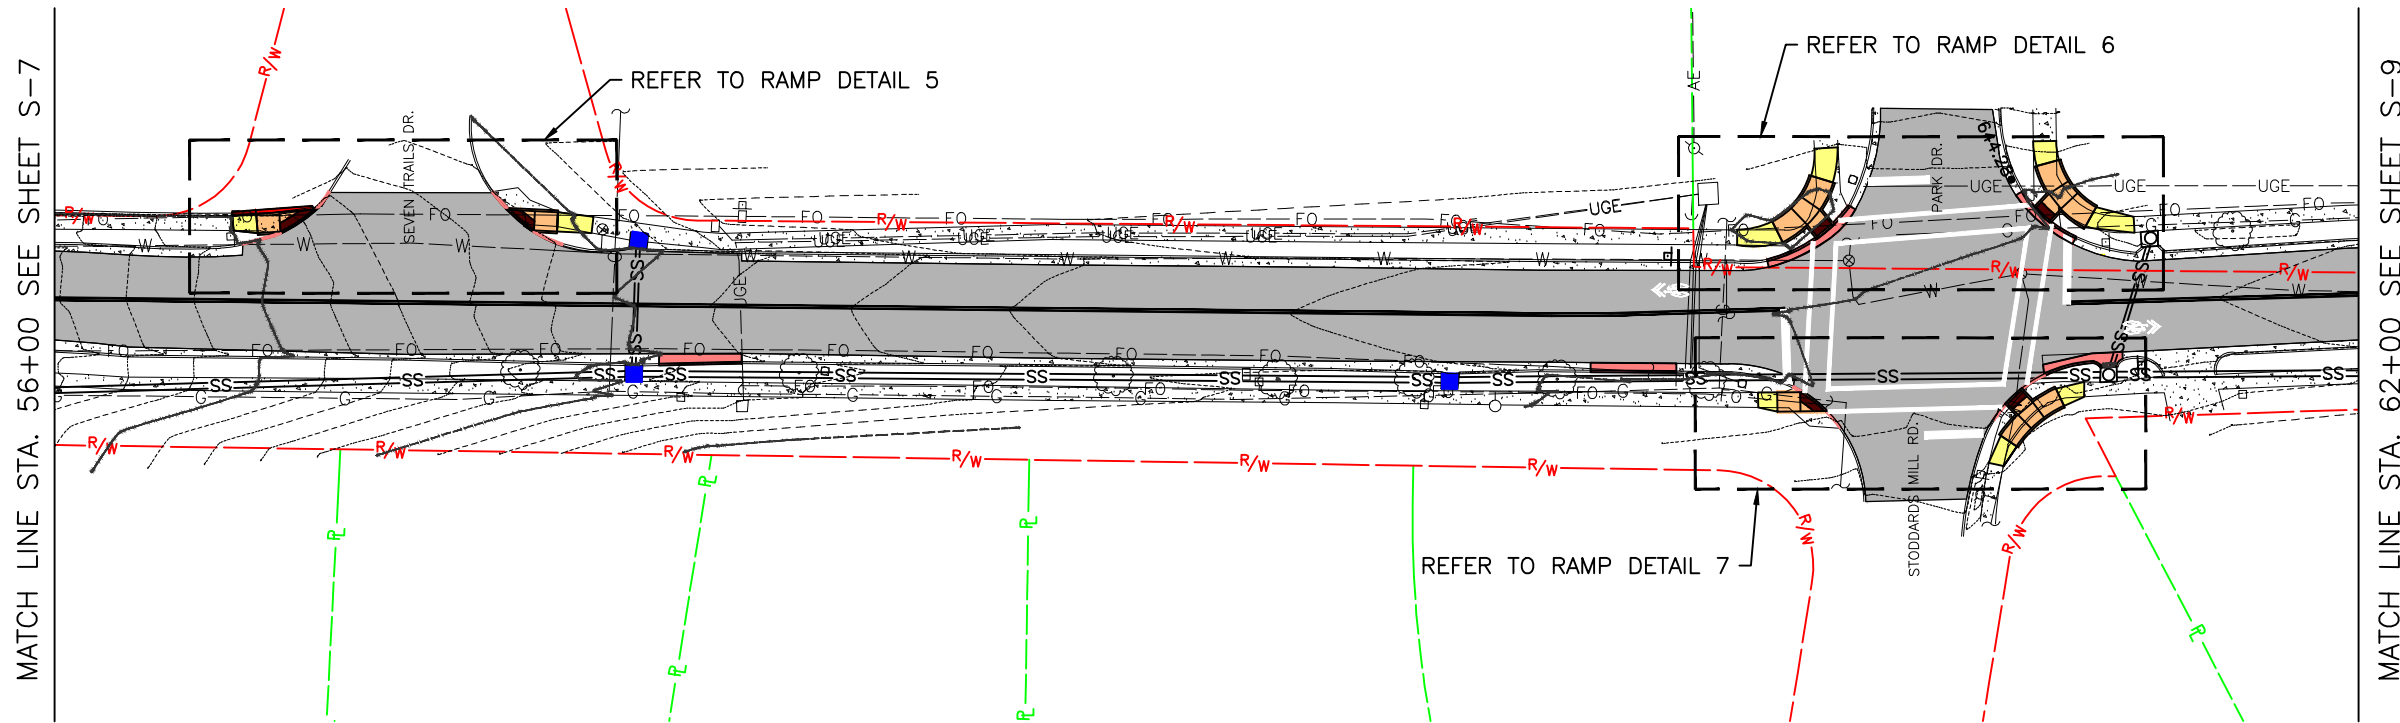

MATCH LINE STA. 56+00 SEE SHEET S-7

MATCH LINE STA. 62+00 SEE SHEET S-9

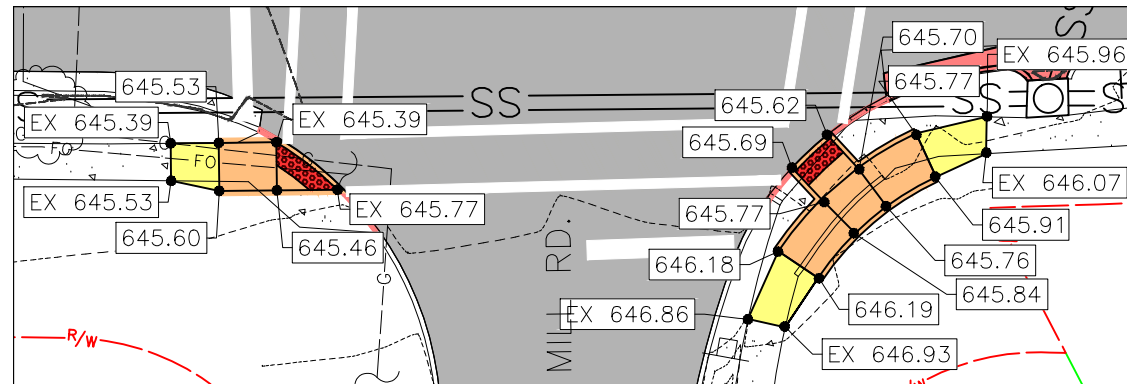

ENLARGED RAMP DETAIL 7
1"=20'

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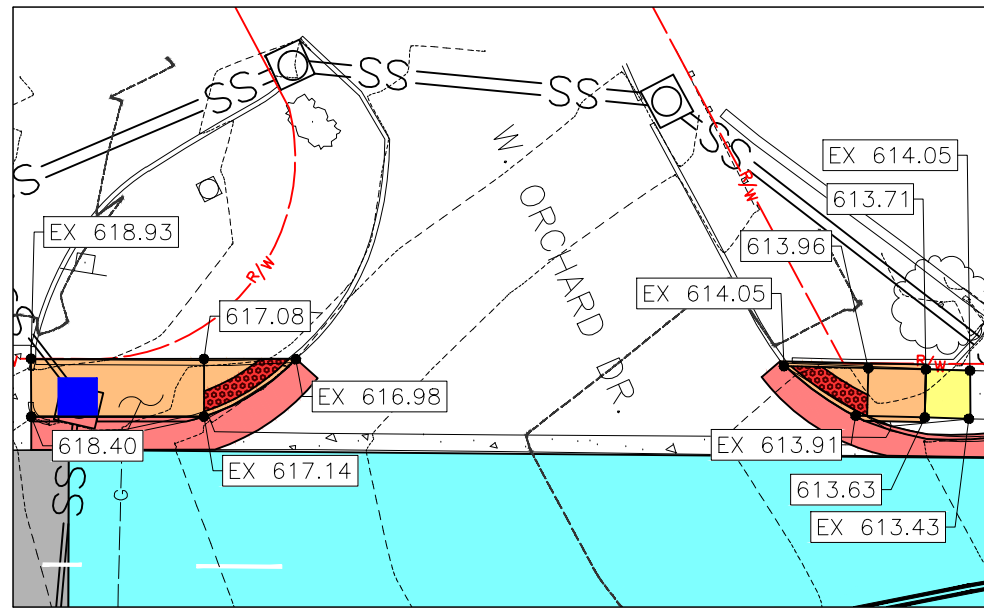
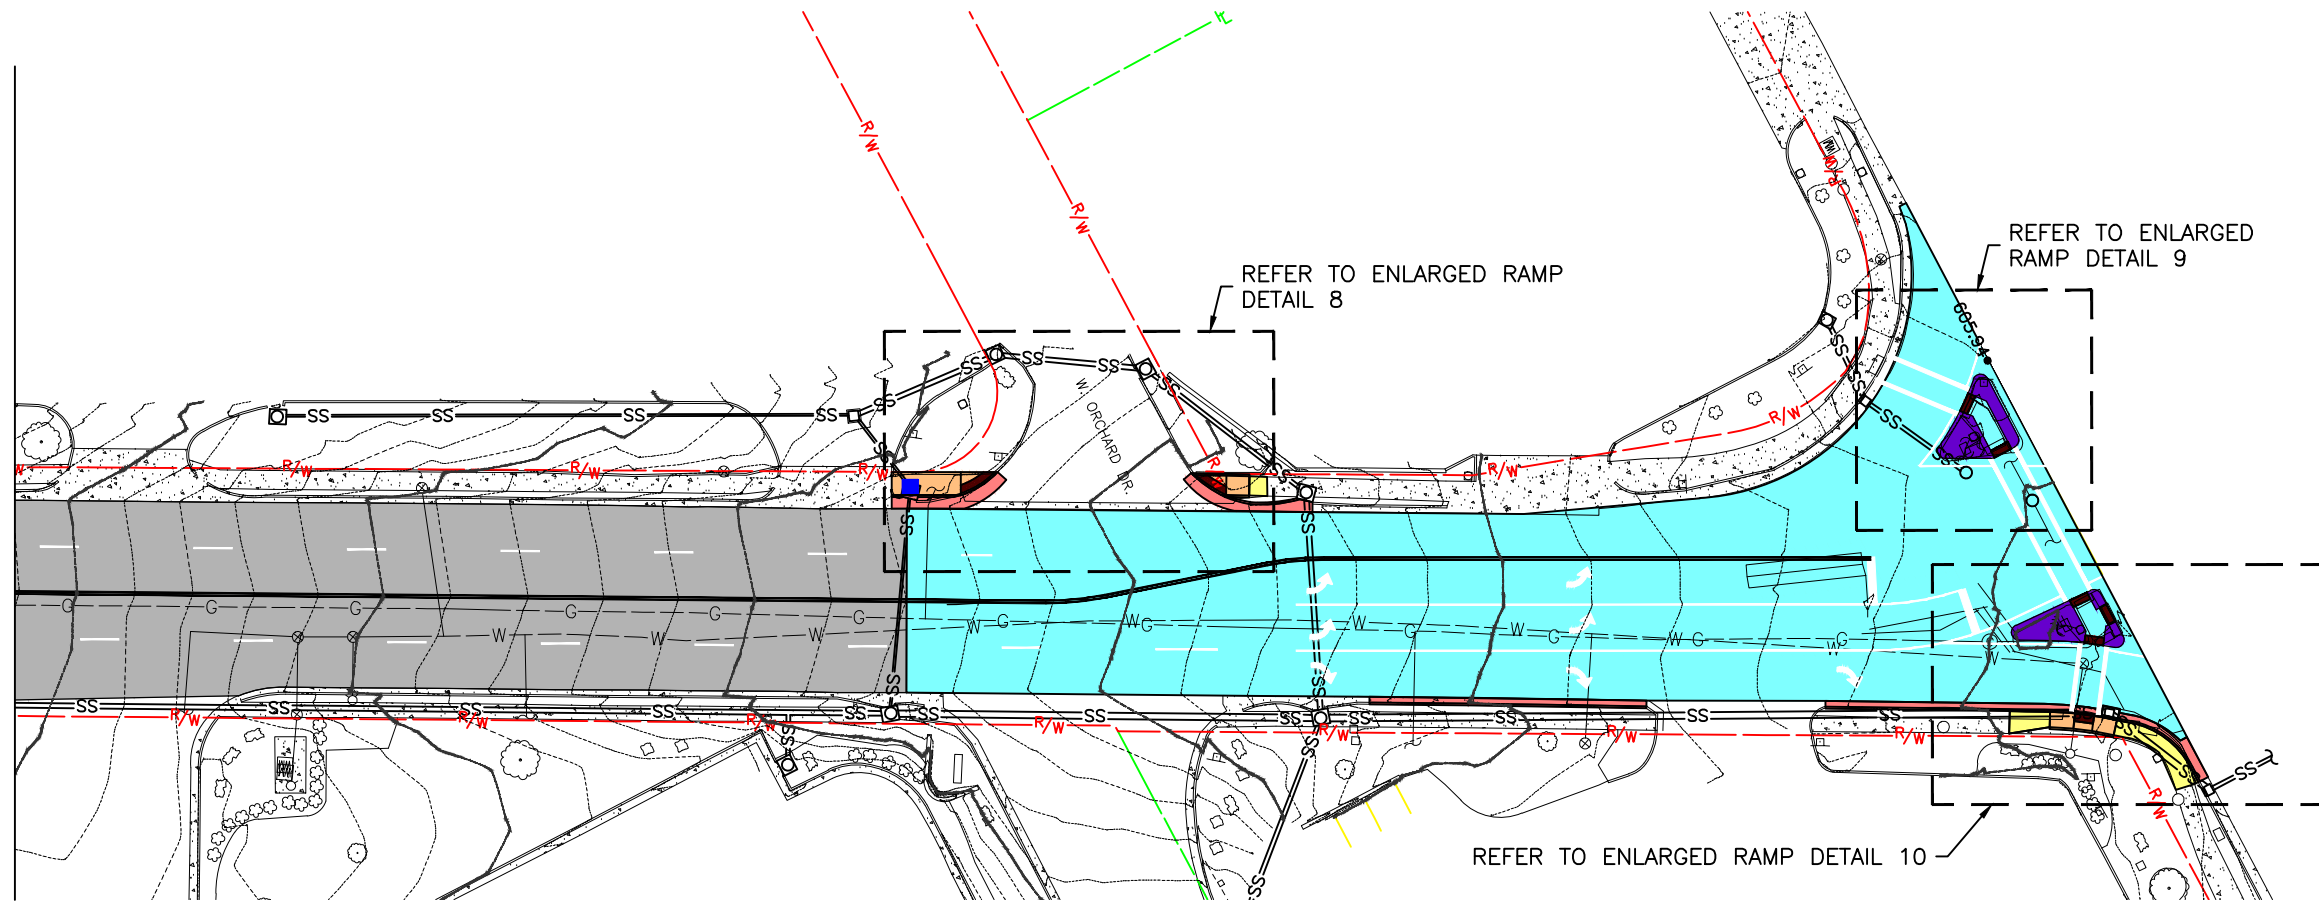
HOLLOWAY ROAD IMPROVEMENTS
FEDERAL PROJECT NO. STP-4939(608)
CITY OF BALLWIN, MISSOURI

DATE	REVISION


DWN. BY: K.J.W. APPD. BY: M.D.S.
DATE: JANUARY 2021
SCALE: 1" = 20'
PROJ. NO: SC19-981
DWG. NO: C-4

Drawing name: I:\SC19-981 Holloway Road, Ballwin, MO\AUTOCAD DRAWINGS\GRADING PLAN.dwg Tab: C-5 Plotted on: Feb 09, 2021 - 10:30am Plotted by: kwolff


MATCH LINE STA. 75+00 SEE SHEET S-10



ENLARGED RAMP DETAIL 8
1"=20'

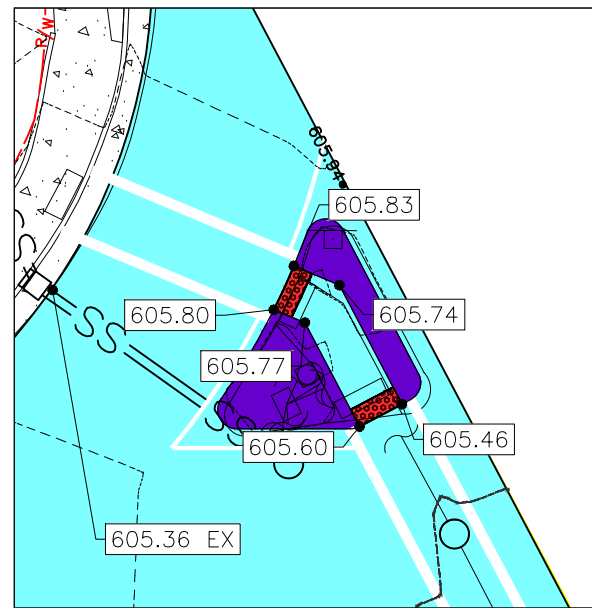

ENLARGED RAMP DETAIL 9
1"=20'

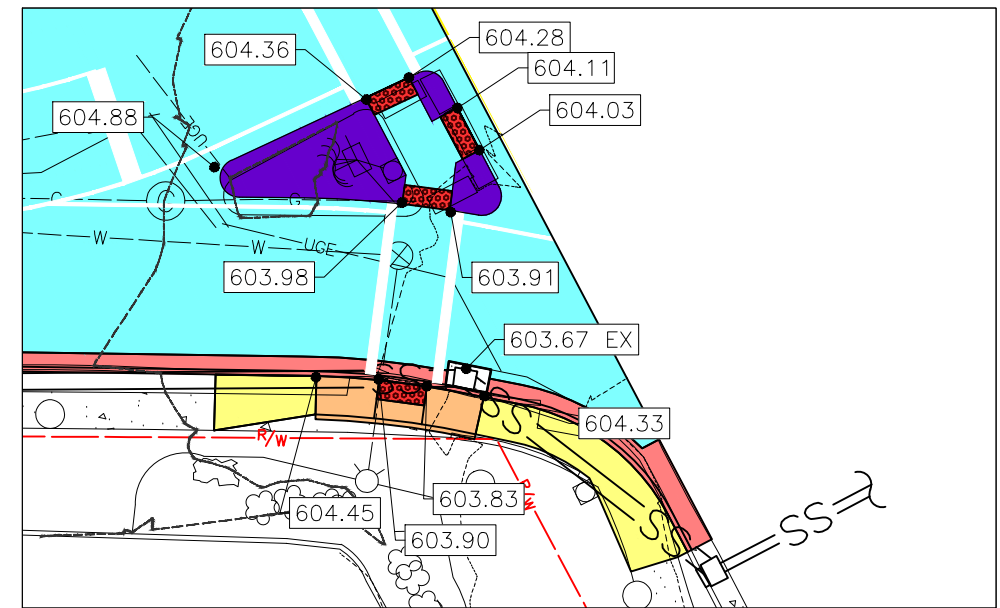

ENLARGED RAMP DETAIL 10
1"=20'

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FEDERAL PROJECT NO. STP-4939(608)
CITY OF BALLWIN, MISSOURI

DATE	REVISION

DWN BY: K.J.W. APPD BY: M.D.S.
DATE: JANUARY 2021
SCALE: 1" = 20'
PROJ. NO: SC19-981
DWG. NO: C-5

PAVEMENT MARKING AND SIGNAGE



TRACT NO. 1
246 CEDAR TRAIL DR.
SIMMONS, MARY L.
BK. 8488 PG. 1034

TRACT NO. 2
244 CEDAR TRAIL DR.
KATZ, JANET
BK. 18926 PG. 2788

TRACT NO. 3
242 CEDAR TRAIL DR.
KORVAS, ROBERT G.
& MARGARET K. H/W
BK. 17531 PG. 3400

TRACT NO. 4
6 PARKROSE CT.
THE DILLON FAMILY, TRUST
BK. 20660 PG. 1506


TRACT NO. 5
7 PARKROSE CT.
HAUN, DANIEL & LORI H/W
BK. 17760 PG. 3498

TRACT NO. 6
8 PARKROSE CT.
SCHNEIDER, JOAN
LIVING TRUST
BK. 21261 PG. 503

TRACT NO. 7
9 PARKROSE CT.
RITCHEY, CELIA A.
BK. 11899 PG. 350

TRACT NO. 8
300 CLAYMONT DR.
LECLAIRE, RACHEL &
KILLOREN, ROBERT T/E
BK. 23232 PG. 3307

TRACT NO. 9
333 HOLLOWAY RD.
CITY OF BALLWIN
BK. 6706 PG. 1598

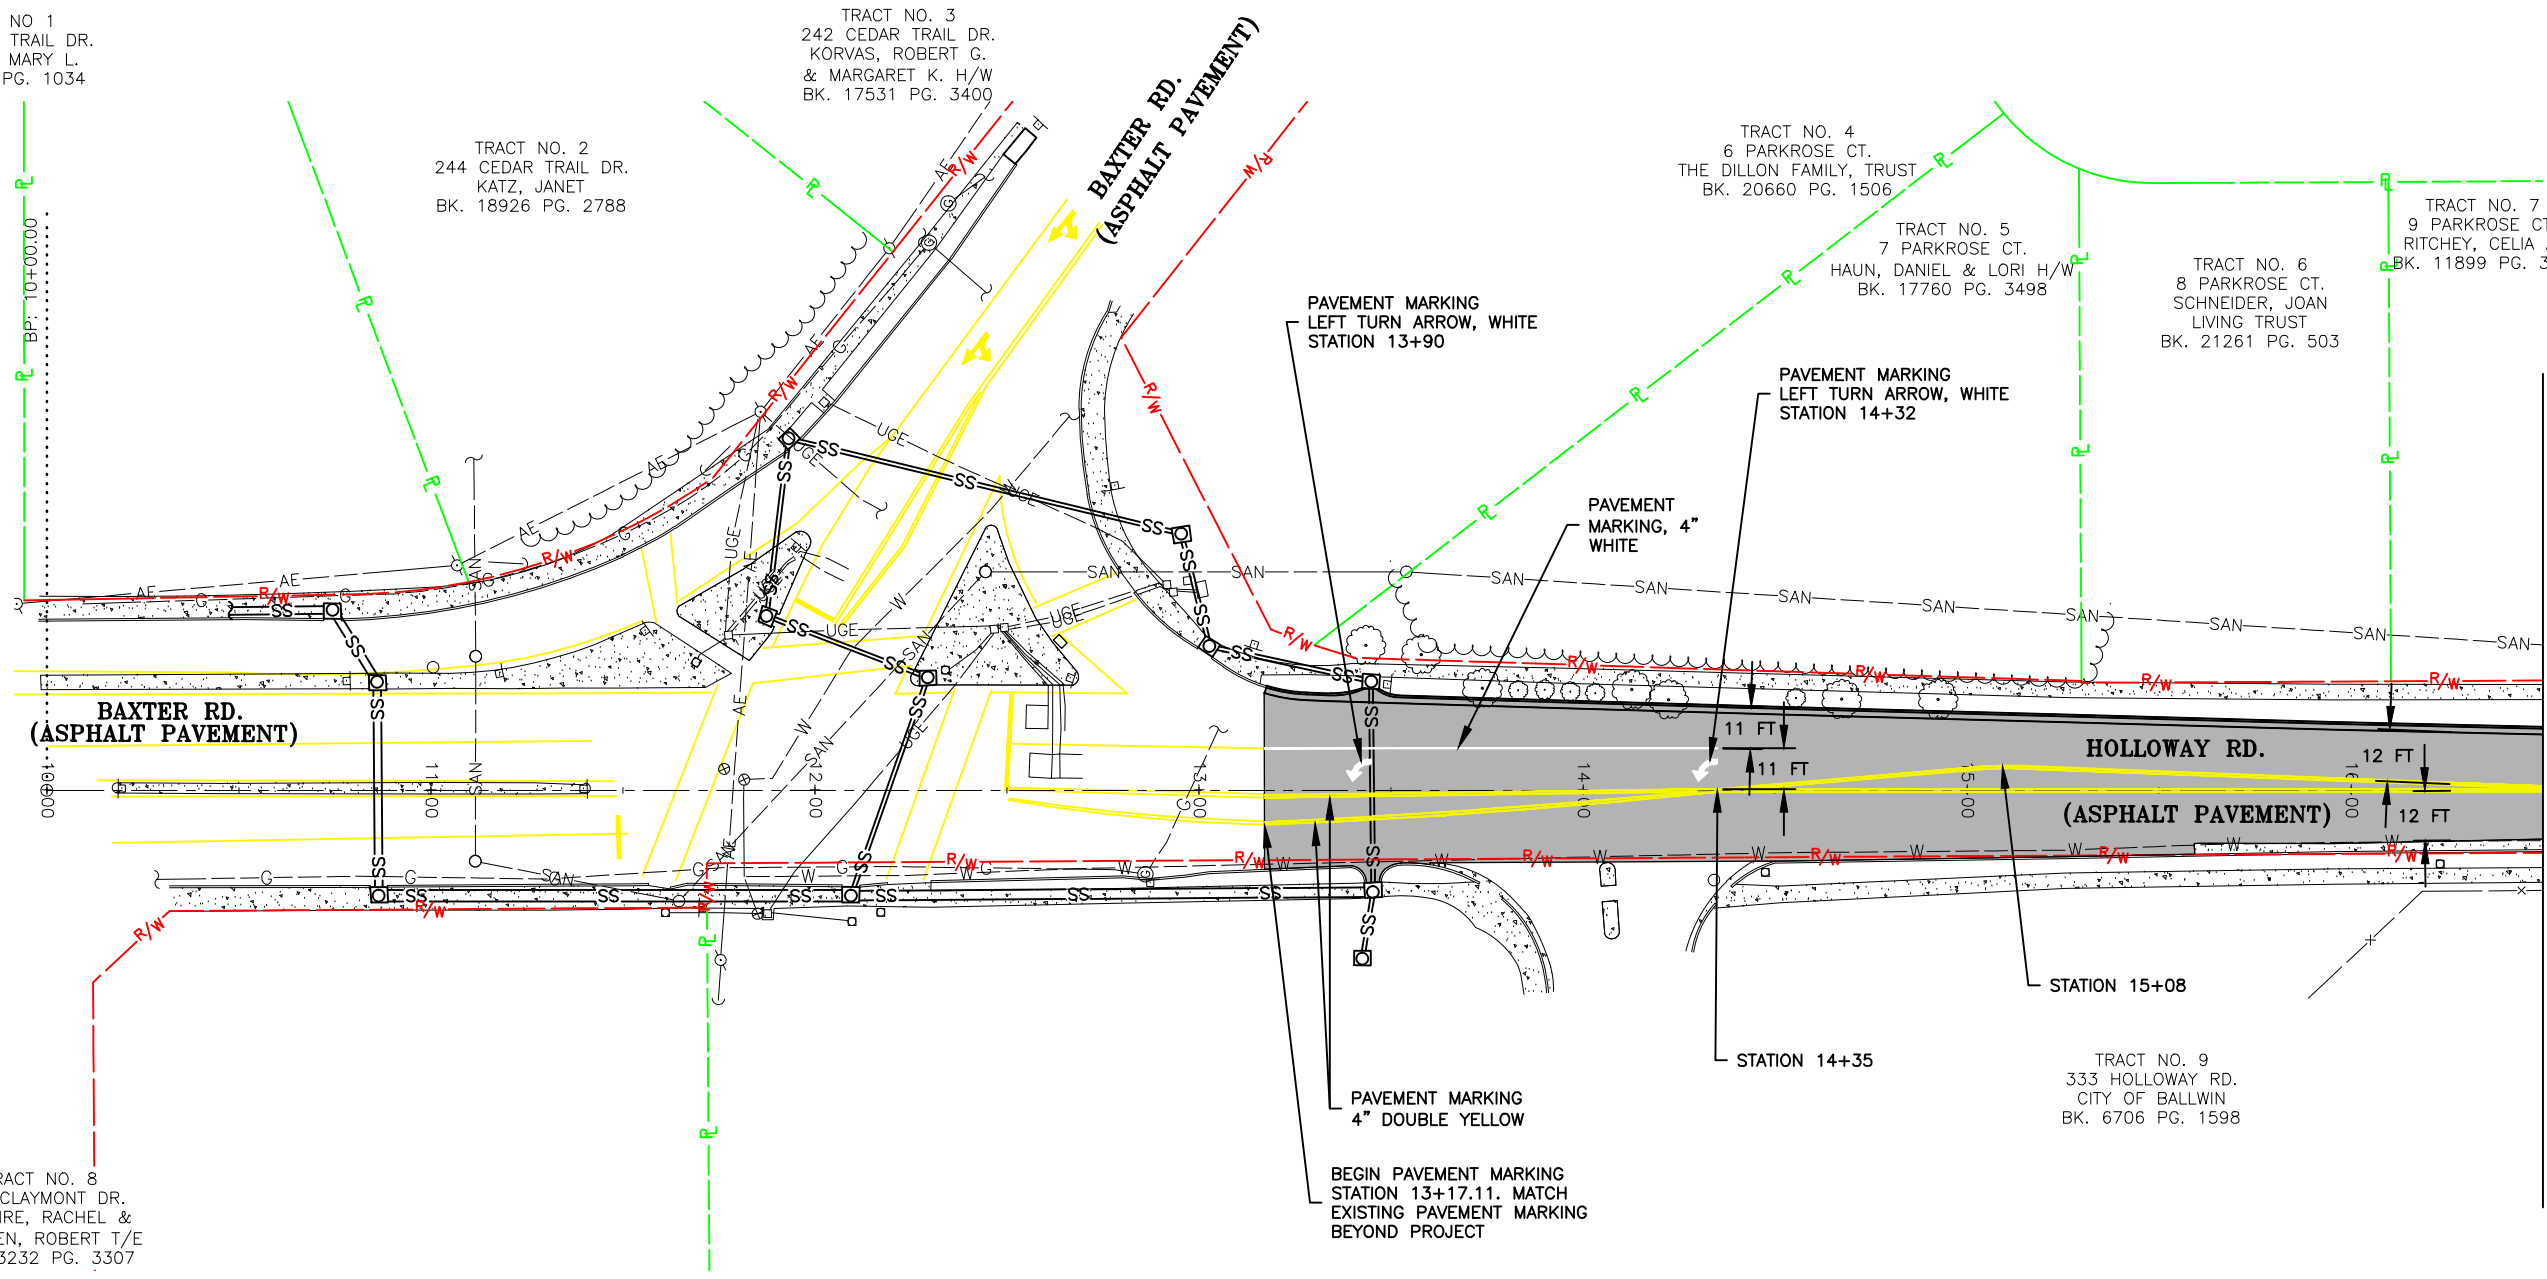

MATCH LINE STA. 16+50 SEE SHEET PM-2

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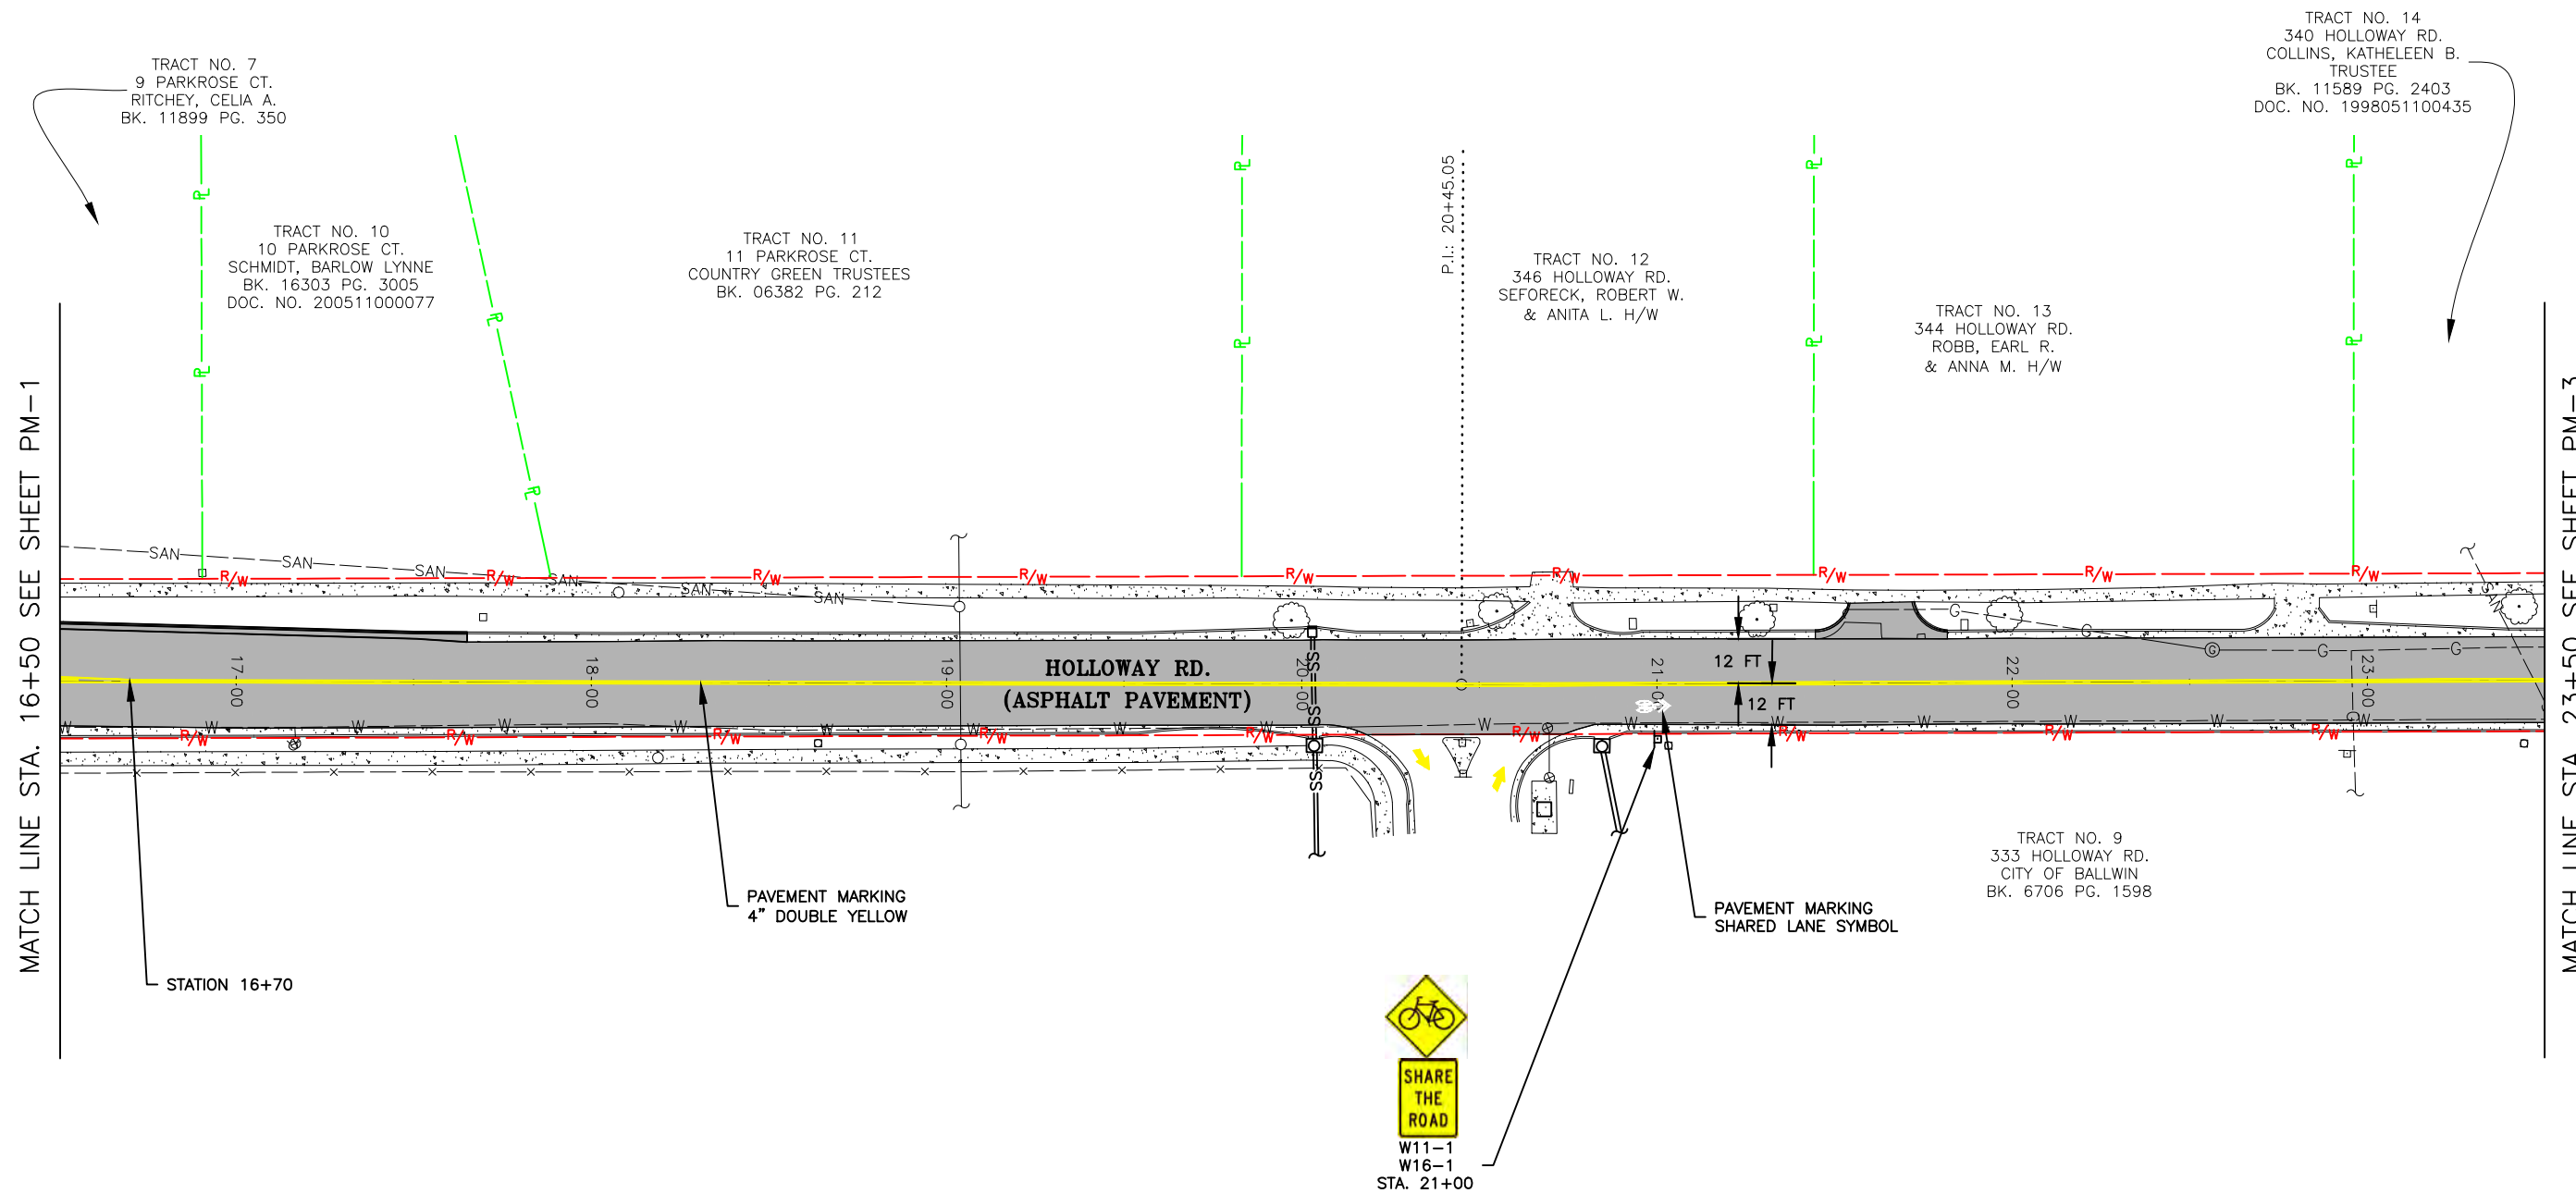
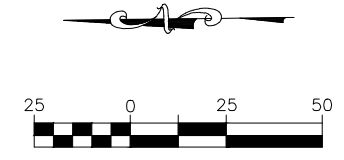
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FEDERAL PROJECT NO. STP-4939(608)
CITY OF BALLWIN, MISSOURI

DATE	REVISION

DWN BY: K.J.W. APPD BY: M.D.S.
DATE: JANUARY 2021
SCALE: 1" = 50'
PROJ. NO: SC19-981
DWG. NO: PM-1

Drawing name: I:\SC19-981 Holloway Road, Ballwin, MO\AUTOCAD DRAWINGS\PAVEMENT MARKING AND SIGNAGE PLAN.dwg Tab: PM-1 Plotted on: Feb 09, 2021 - 10:31am Plotted by: knellf

PAVEMENT MARKING AND SIGNAGE



Drawing name: U:\SC19-981 Holloway Road, Ballwin, MO\AUTOCAD DRAWINGS\PAVEMENT MARKING AND SIGNAGE PLAN.dwg Tab: PM-2 Plotted on: Feb 09, 2021 - 10:31am Plotted by: kwelff

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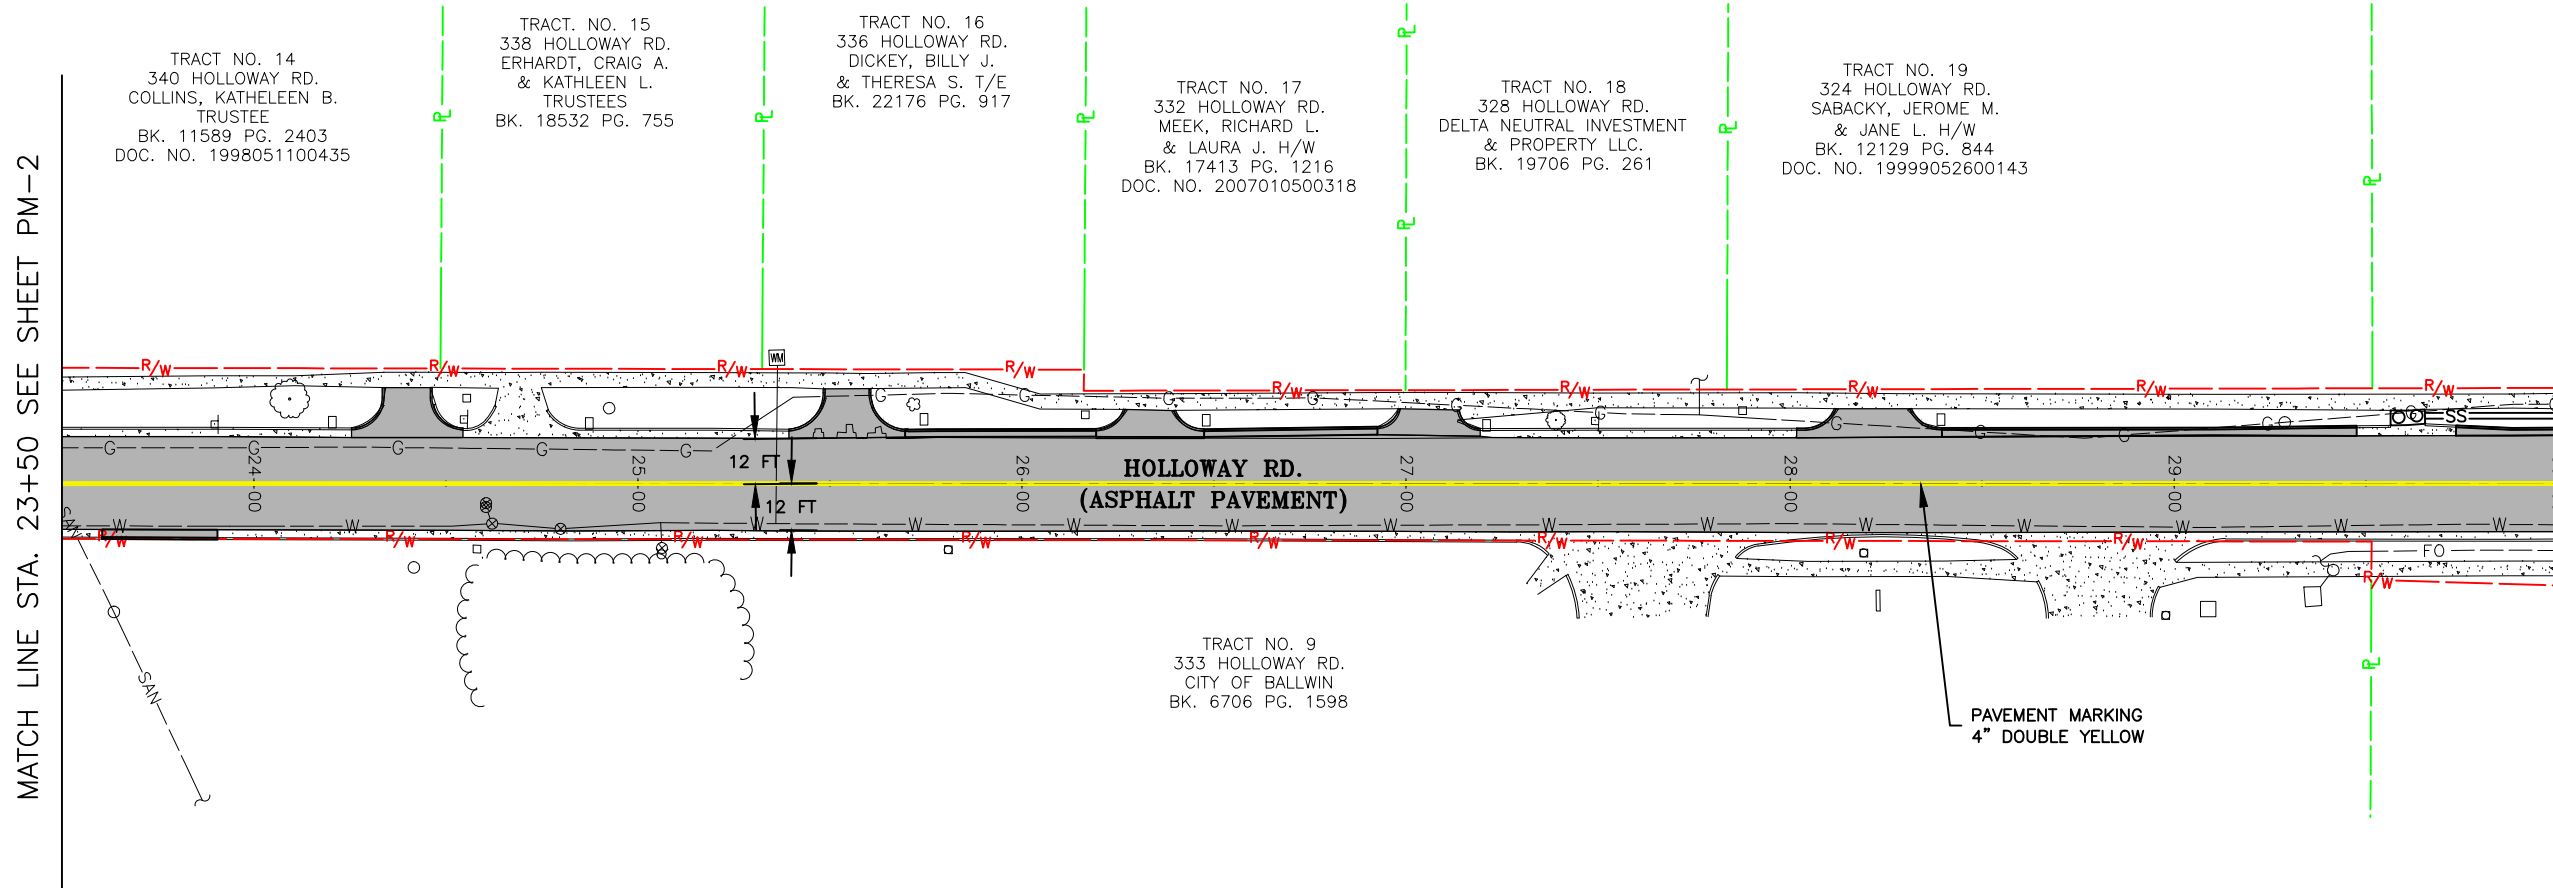
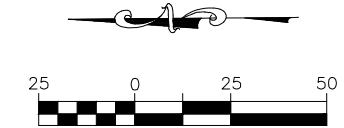
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DATE: JANUARY 2021
SCALE: 1" = 50'
PROJ. NO: SC19-981
DWG. NO: PM-2

PAVEMENT MARKING AND SIGNAGE



TRACT NO. 14
340 HOLLOWAY RD.
COLLINS, KATHELEEN B.
TRUSTEE
BK. 11589 PG. 2403
DOC. NO. 1998051100435

TRACT NO. 15
338 HOLLOWAY RD.
ERHARDT, CRAIG A.
& KATHLEEN L.
TRUSTEES
BK. 18532 PG. 755

TRACT NO. 16
336 HOLLOWAY RD.
DICKEY, BILLY J.
& THERESA S. T/E
BK. 22176 PG. 917

TRACT NO. 17
332 HOLLOWAY RD.
MEEK, RICHARD L.
& LAURA J. H/W
BK. 17413 PG. 1216
DOC. NO. 2007010500318

TRACT NO. 18
328 HOLLOWAY RD.
DELTA NEUTRAL INVESTMENT
& PROPERTY LLC.
BK. 19706 PG. 261

TRACT NO. 19
324 HOLLOWAY RD.
SABACKY, JEROME M.
& JANE L. H/W
BK. 12129 PG. 844
DOC. NO. 19999052600143

TRACT NO. 20
322 HOLLOWAY RD.
STRITZEL, HERBERT J.
& SANDRA L. H/W
BK. 10615 PG. 321

TRACT NO. 9
333 HOLLOWAY RD.
CITY OF BALLWIN
BK. 6706 PG. 1598

TRACT NO. 21
301 ST. ANDREWS CT.
PANDIAN, VEERA & POIGAI H/W
BK. 19509 PG. 2857

MATCH LINE STA. 23+50 SEE SHEET PM-2

MATCH LINE STA. 30+00 SEE SHEET PM-4

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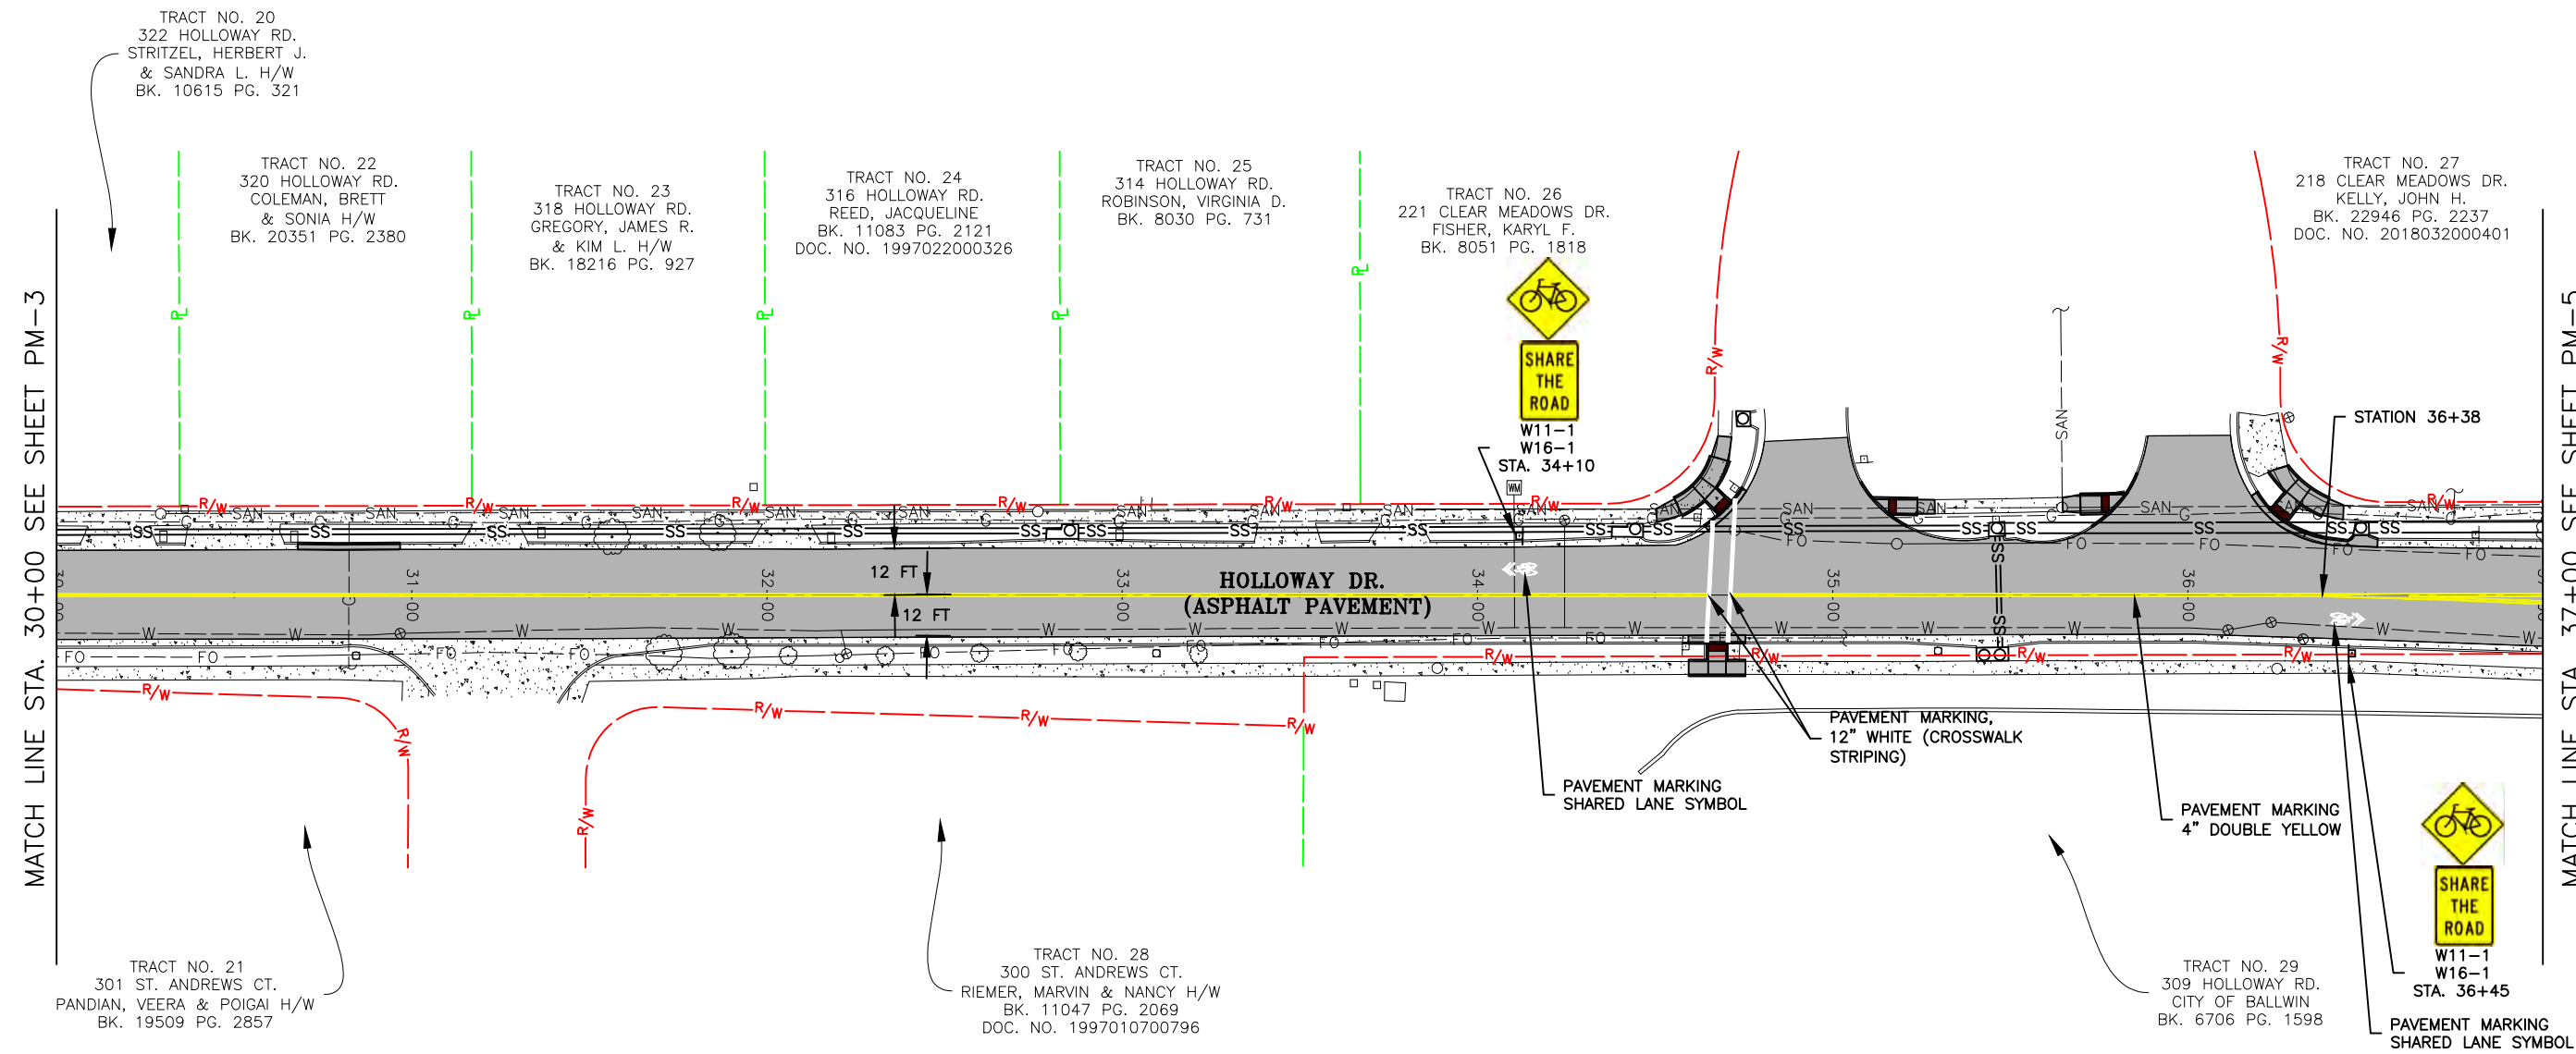
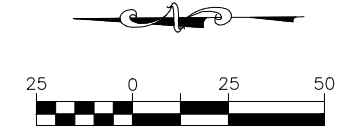
HOLLOWAY ROAD IMPROVEMENTS
FEDERAL PROJECT NO. STP-4939(608)
CITY OF BALLWIN, MISSOURI

DATE	REVISION

DWN. BY: K.J.W. APPD. BY: M.D.S.
DATE: JANUARY 2021
SCALE: 1" = 50'
PROJ. NO: SC19-981
DWG. NO: PM-3

Drawing name: U:\SC19-981 Holloway Road, Ballwin, MO\AUTOCAD DRAWINGS\PAVEMENT MARKING AND SIGNAGE PLAN.dwg Tab: PM-3 Plotted on: Feb 09, 2021 - 10:31am Plotted by: knellf

PAVEMENT MARKING AND SIGNAGE



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LAND SURVEYING CERTIFICATE OF AUTHORITY NUMBER - 2007004529

STATE OF MISSOURI

KEVIN J. WOLFF, P.E.
NO. PE-200400859
STATE OF MISSOURI
REGISTERED PROFESSIONAL ENGINEER
FOR SC ENGINEERING LLC
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FEDERAL PROJECT NO. STP-4939(608)
CITY OF BALLWIN, MISSOURI


PAVEMENT MARKING AND SIGNAGE

DATE	REVISION

DWN. BY: K.J.W. APPD. BY: M.D.S.
DATE: JANUARY 2021
SCALE: 1" = 50'
PROJ. NO: SC19-981
DWG. NO: PM-4

Drawing name: I:\SC19-981 Holloway Road, Ballwin, MO\AUTOCAD DRAWINGS\PAVEMENT MARKING AND SIGNAGE PLAN.dwg Tab: PM-4 Plotted on: Feb 09, 2021 - 10:31am Plotted by: kwolf

PAVEMENT MARKING AND SIGNAGE

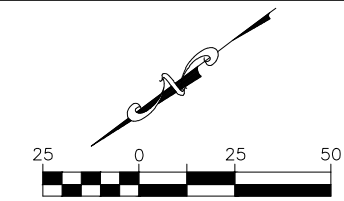

TRACT NO. 31
304 HOLLOWAY RD.
MURPHY, WILLIAM G. &
TURNER, HELEN H/W
BK. 14674 PG. 1852
DOC. NO. 2003031800355

TRACT NO. 32
302 HOLLOWAY RD.
SCHIECHTER, JAMES
& PATRICIA T/E
BK. 23144 PG. 2341
DOC. NO. 2018080800438


TRACT NO. 29
309 HOLLOWAY RD.
CITY OF BALLWIN
BK. 6706 PG. 1598

TRACT NO. 29
309 HOLLOWAY RD.
CITY OF BALLWIN
BK. 6706 PG. 1598

TRACT NO. 33
221 BLUE SAGE CT.
MIMG XCII SEVEN TRAILS LLC.
BK. 22652 PG.1507
DOC. NO. 2017081500432

TRACT NO. 27
218 CLEAR MEADOWS DR.
KELLY, JOHN H.
BK. 22946 PG. 2237
DOC. NO. 2018032000401

50' TRACT OF LAND
CONVEYED TO CITY
OF BALLWIN
BK. 6480, PG. 987

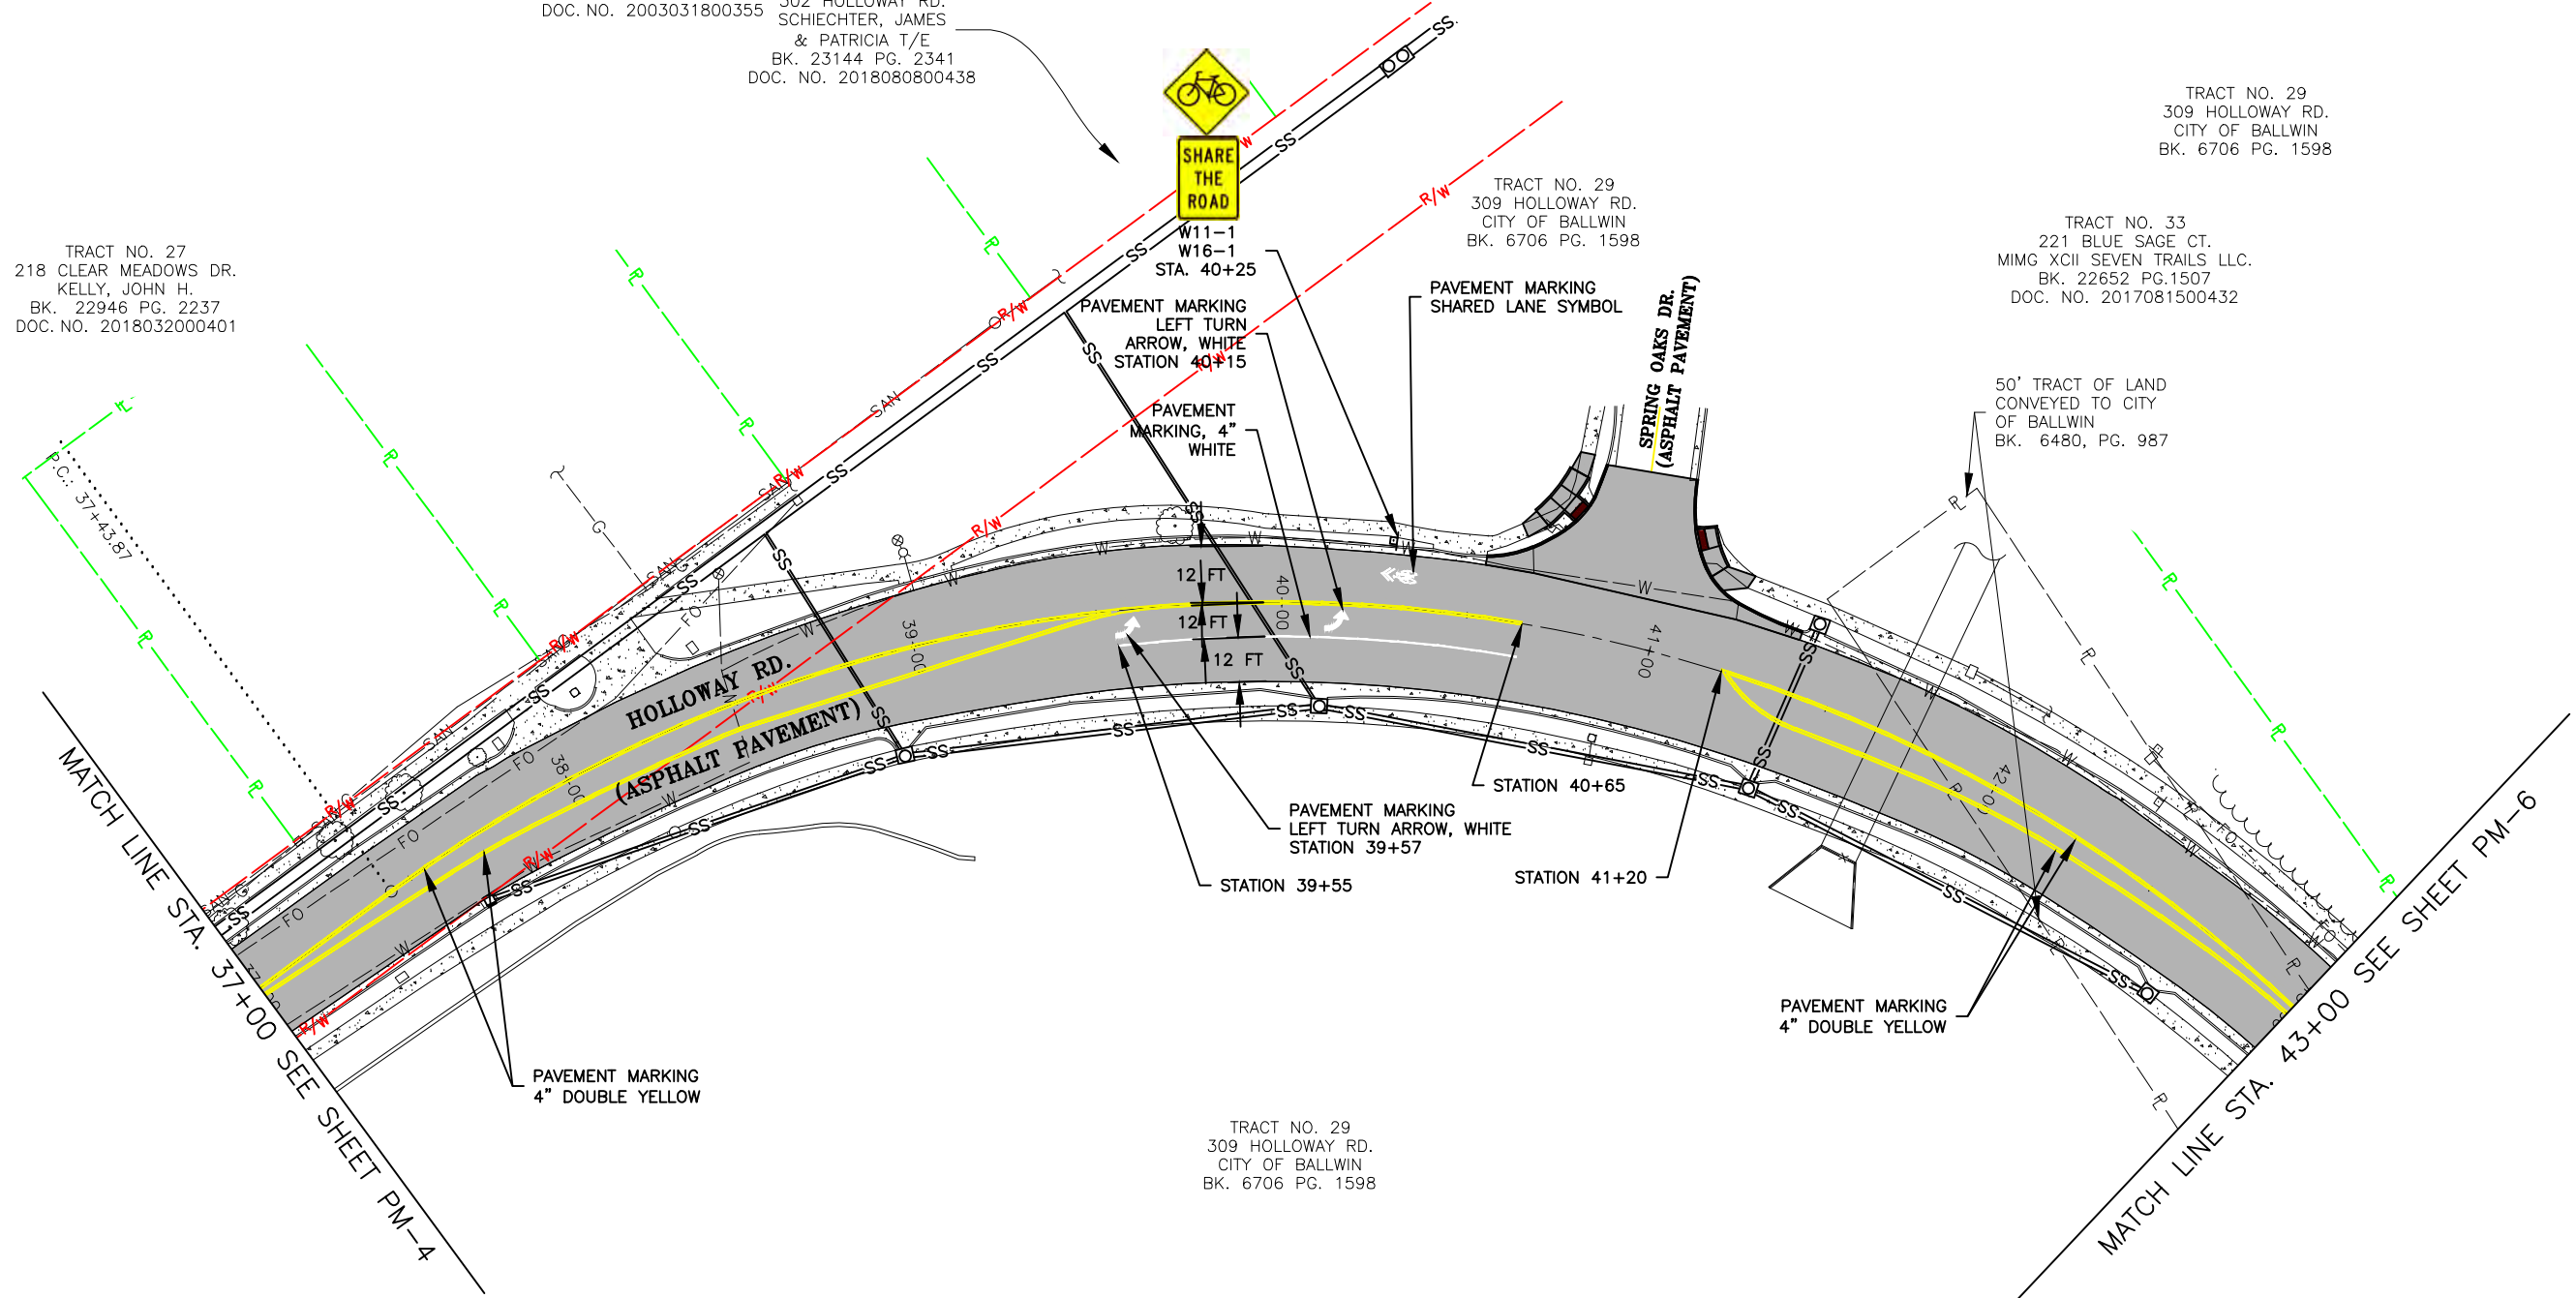

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STATE OF MISSOURI

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NO. PE-200400859
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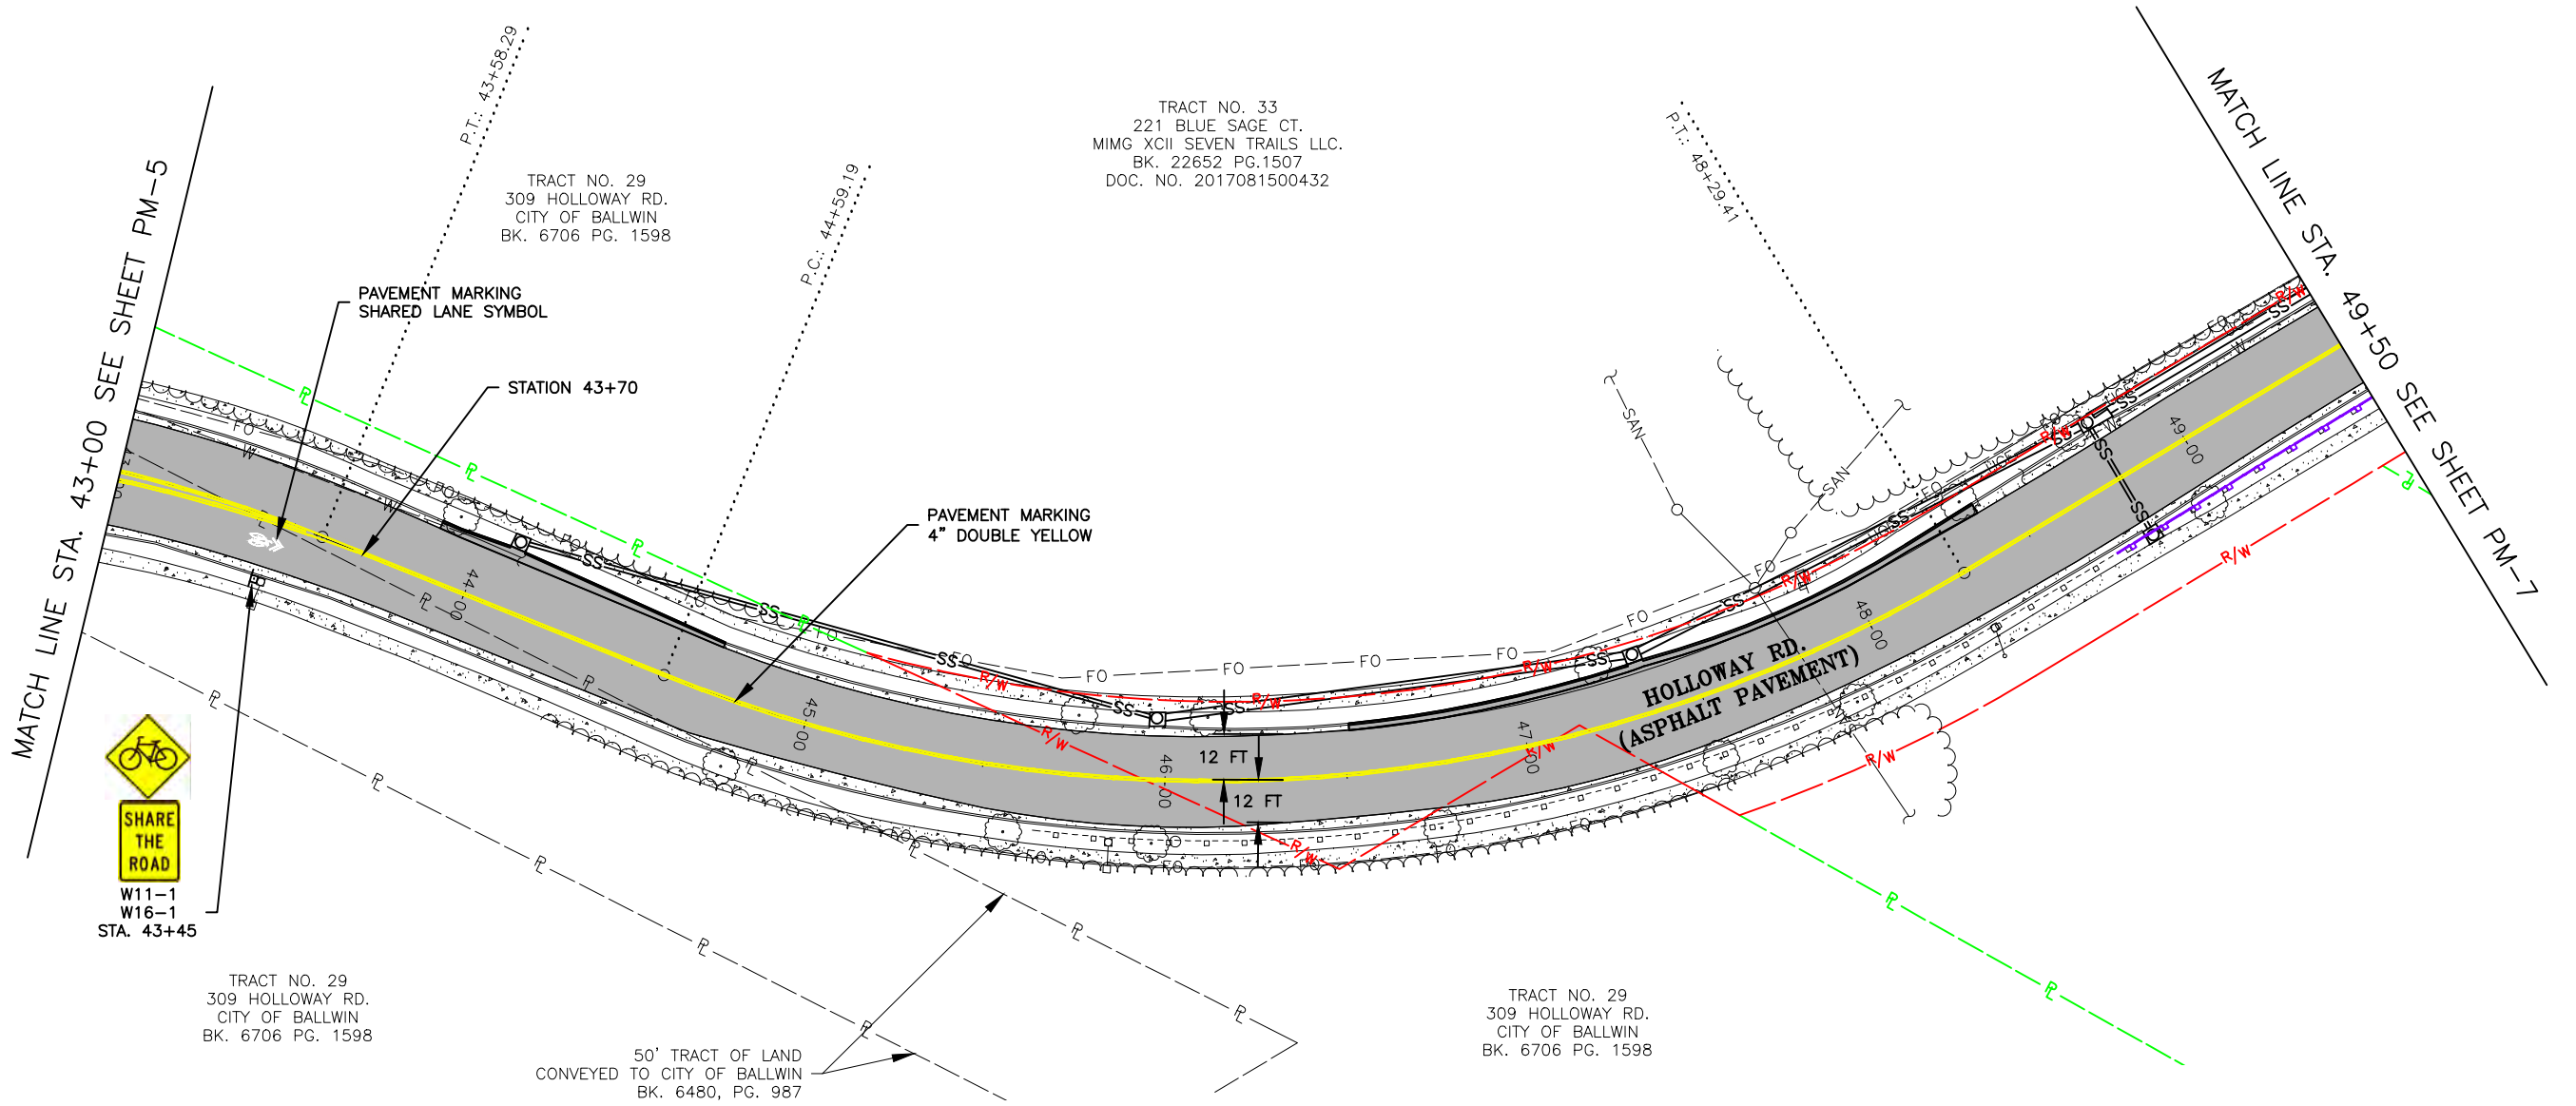
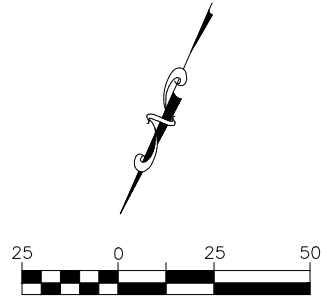
HOLLOWAY ROAD IMPROVEMENTS
FEDERAL PROJECT NO. STP-4939(608)
CITY OF BALLWIN, MISSOURI

DATE	REVISION

DWN. BY: K.J.W. APPD. BY: M.D.S.
DATE: JANUARY 2021
SCALE: 1" = 50'
PROJ. NO.: SC19-981
DWG. NO.: PM-5

Drawing name: U:\SC19-981 Holloway Road, Ballwin, MO\AUTOCAD DRAWINGS\PAVEMENT MARKING AND SIGNAGE PLAN.dwg Tab: PM-5 Plotted on: Feb 09, 2021 - 10:31am Plotted by: knellf

PAVEMENT MARKING AND SIGNAGE



Drawing name: J:\SC19-981 Holloway Road, Ballwin, MO\AUTOCAD DRAWINGS\PAVEMENT MARKING AND SIGNAGE PLAN.dwg Tab: PM-6 Plotted on: Feb 09, 2021 - 10:31am Plotted by: kwelf

TRACT NO. 33
221 BLUE SAGE CT.
MIMG XCII SEVEN TRAILS LLC.
BK. 22652 PG.1507
DOC. NO. 2017081500432

TRACT NO. 29
309 HOLLOWAY RD.
CITY OF BALLWIN
BK. 6706 PG. 1598

TRACT NO. 29
309 HOLLOWAY RD.
CITY OF BALLWIN
BK. 6706 PG. 1598

50' TRACT OF LAND
CONVEYED
TO CITY OF BALLWIN
BK. 6480, PG. 987

TRACT NO. 29
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CITY OF BALLWIN
BK. 6706 PG. 1598

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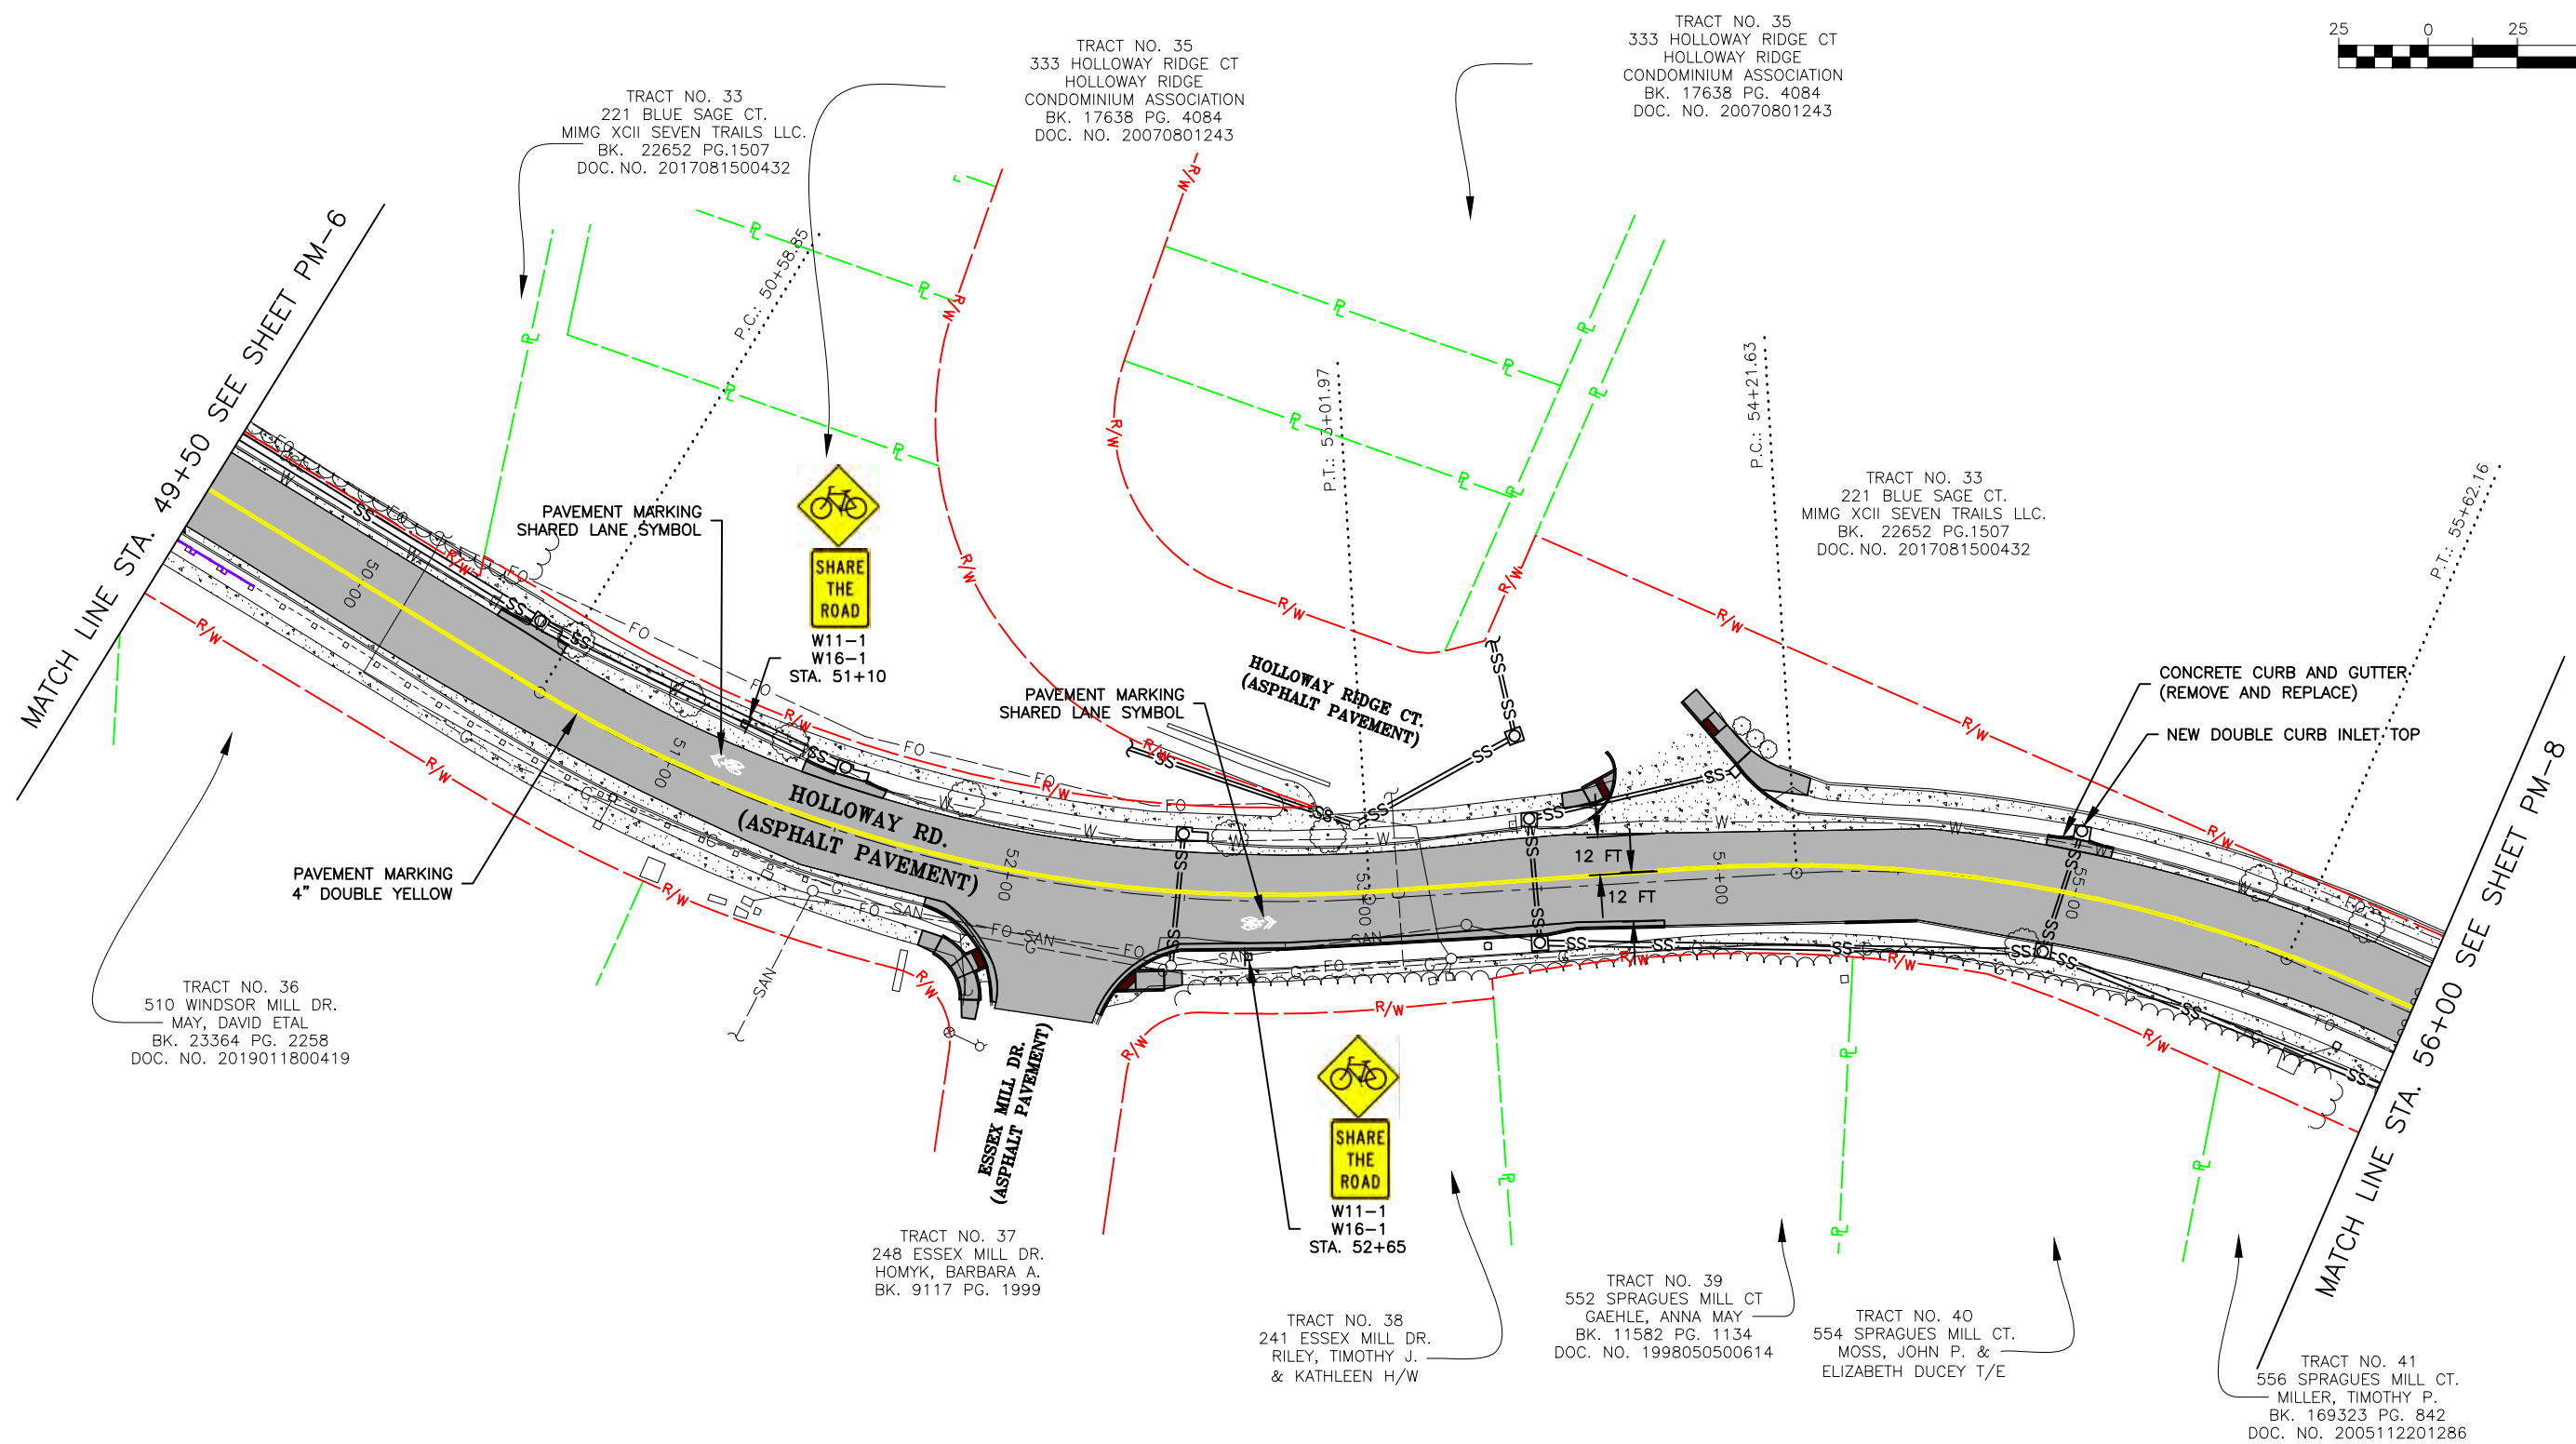
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FEDERAL PROJECT NO. STP-4939(608)
CITY OF BALLWIN, MISSOURI

PAVEMENT MARKING AND SIGNAGE	
DATE	REVISION
DWN. BY:	APPD. BY:
K.J.W.	M.D.S.
DATE:	JANUARY 2021
SCALE:	1" = 50'
PROJ. NO.:	SC19-981
DWG. NO.:	PM-6

PAVEMENT MARKING AND SIGNAGE



TRACT NO. 33
221 BLUE SAGE CT.
MIMG XCII SEVEN TRAILS LLC.
BK. 22652 PG.1507
DOC. NO. 2017081500432

TRACT NO. 35
333 HOLLOWAY RIDGE CT
HOLLOWAY RIDGE
CONDOMINIUM ASSOCIATION
BK. 17638 PG. 4084
DOC. NO. 20070801243

TRACT NO. 35
333 HOLLOWAY RIDGE CT
HOLLOWAY RIDGE
CONDOMINIUM ASSOCIATION
BK. 17638 PG. 4084
DOC. NO. 20070801243

TRACT NO. 33
221 BLUE SAGE CT.
MIMG XCII SEVEN TRAILS LLC.
BK. 22652 PG.1507
DOC. NO. 2017081500432

TRACT NO. 36
510 WINDSOR MILL DR.
MAY, DAVID ETAL
BK. 23364 PG. 2258
DOC. NO. 2019011800419

TRACT NO. 37
248 ESSEX MILL DR.
HOMYK, BARBARA A.
BK. 9117 PG. 1999

TRACT NO. 38
241 ESSEX MILL DR.
RILEY, TIMOTHY J.
& KATHLEEN H/W

TRACT NO. 39
552 SPRAGUES MILL CT
GAEHLE, ANNA MAY
BK. 11582 PG. 1134
DOC. NO. 1998050500614

TRACT NO. 40
554 SPRAGUES MILL CT.
MOSS, JOHN P. &
ELIZABETH DUCEY T/E

TRACT NO. 41
556 SPRAGUES MILL CT.
MILLER, TIMOTHY P.
BK. 169323 PG. 842
DOC. NO. 2005112201286

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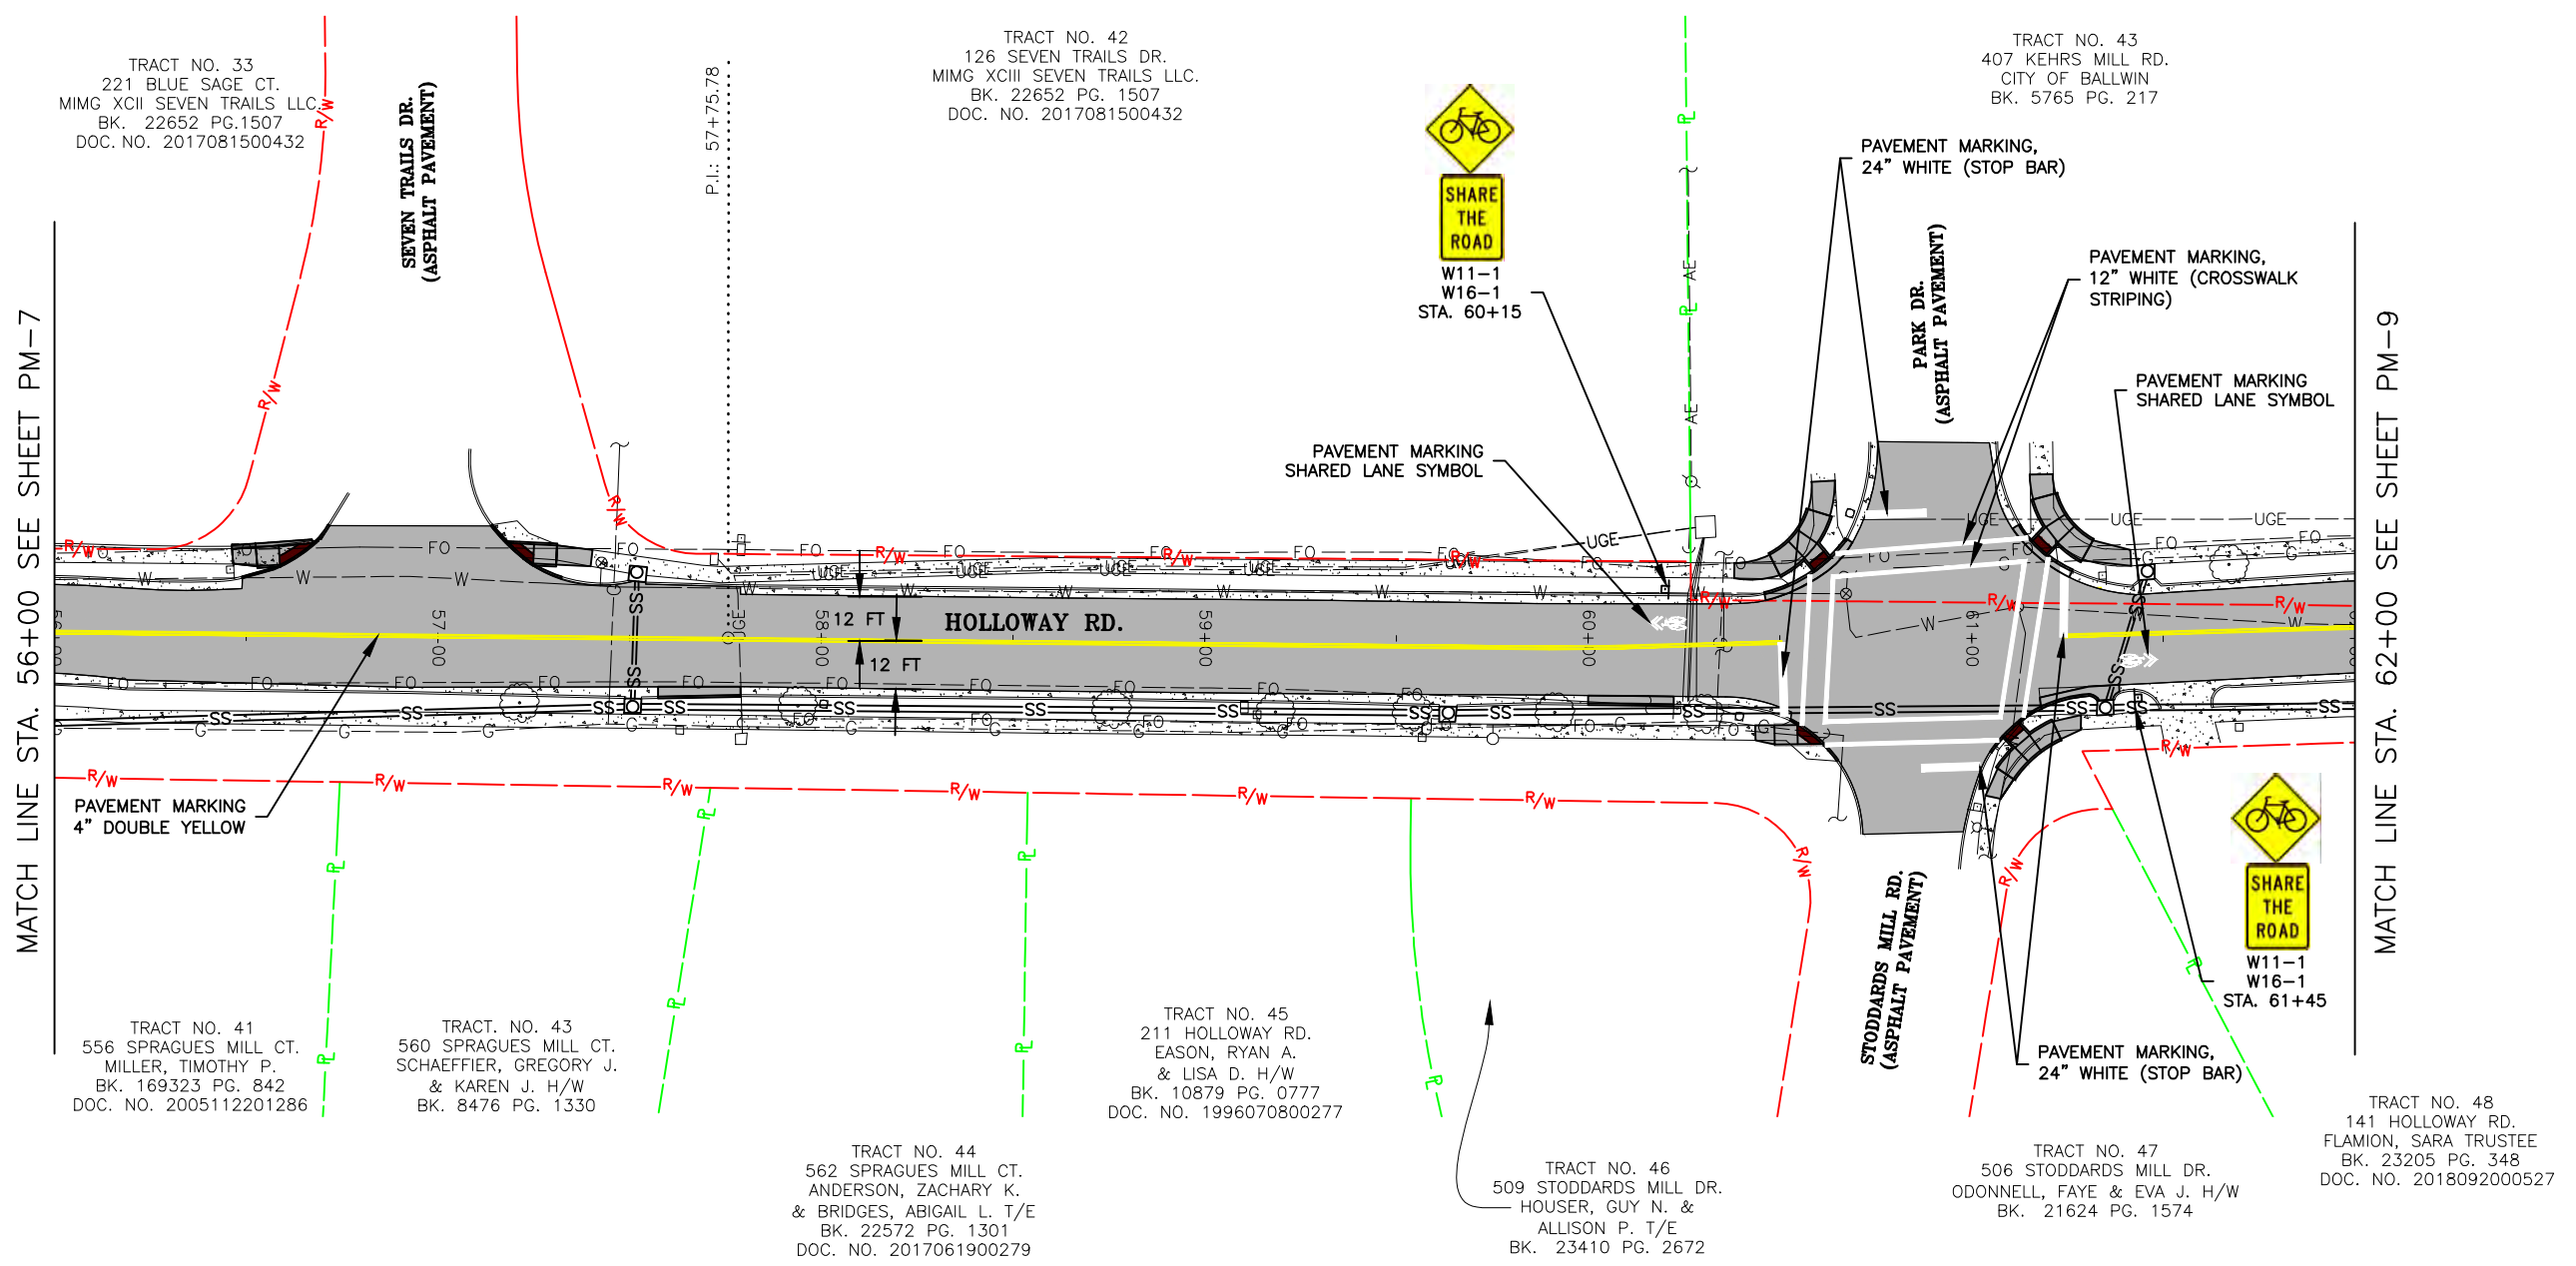
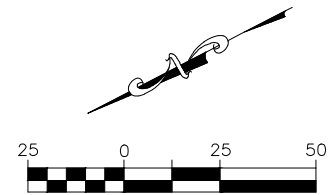
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FEDERAL PROJECT NO. STP-4939(608)
CITY OF BALLWIN, MISSOURI

PAVEMENT MARKING AND SIGNAGE	
DATE	REVISION
DWN BY: K.J.W.	APP'D BY: M.D.S.
DATE: JANUARY 2021	
SCALE: 1" = 50'	
PROJ. NO. SC19-981	
DWG. NO. PM-7	

Drawing name: U:\SC19-981 Holloway Road, Ballwin, MO\AUTOCAD DRAWINGS\PAVEMENT MARKING AND SIGNAGE PLAN.dwg Tab: PM-7 Plotted on: Feb 09, 2021 - 10:31am Plotted by: knellf

PAVEMENT MARKING AND SIGNAGE



TRACT NO. 33
221 BLUE SAGE CT.
MIMG XCII SEVEN TRAILS LLC
BK. 22652 PG.1507
DOC. NO. 2017081500432

SEVEN TRAILS DR.
(ASPHALT PAVEMENT)

TRACT NO. 42
126 SEVEN TRAILS DR.
MIMG XCIII SEVEN TRAILS LLC
BK. 22652 PG. 1507
DOC. NO. 2017081500432

TRACT NO. 43
407 KEHRS MILL RD.
CITY OF BALLWIN
BK. 5765 PG. 217

TRACT NO. 41
556 SPRAGUES MILL CT.
MILLER, TIMOTHY P.
BK. 169323 PG. 842
DOC. NO. 2005112201286

TRACT NO. 43
560 SPRAGUES MILL CT.
SCHAEFFIER, GREGORY J.
& KAREN J. H/W
BK. 8476 PG. 1330

TRACT NO. 44
562 SPRAGUES MILL CT.
ANDERSON, ZACHARY K.
& BRIDGES, ABIGAIL L. T/E
BK. 22572 PG. 1301
DOC. NO. 2017061900279

TRACT NO. 45
211 HOLLOWAY RD.
EASON, RYAN A.
& LISA D. H/W
BK. 10879 PG. 0777
DOC. NO. 1996070800277

TRACT NO. 46
509 STODDARDS MILL DR.
HOUSER, GUY N. &
ALLISON P. T/E
BK. 23410 PG. 2672

TRACT NO. 47
506 STODDARDS MILL DR.
ODONNELL, FAYE & EVA J. H/W
BK. 21624 PG. 1574

TRACT NO. 48
141 HOLLOWAY RD.
FLAMION, SARA TRUSTEE
BK. 23205 PG. 348
DOC. NO. 2018092000527

MATCH LINE STA. 56+00 SEE SHEET PM-7

MATCH LINE STA. 62+00 SEE SHEET PM-9

SHARE THE ROAD
W11-1
W16-1
STA. 60+15

SHARE THE ROAD
W11-1
W16-1
STA. 61+45

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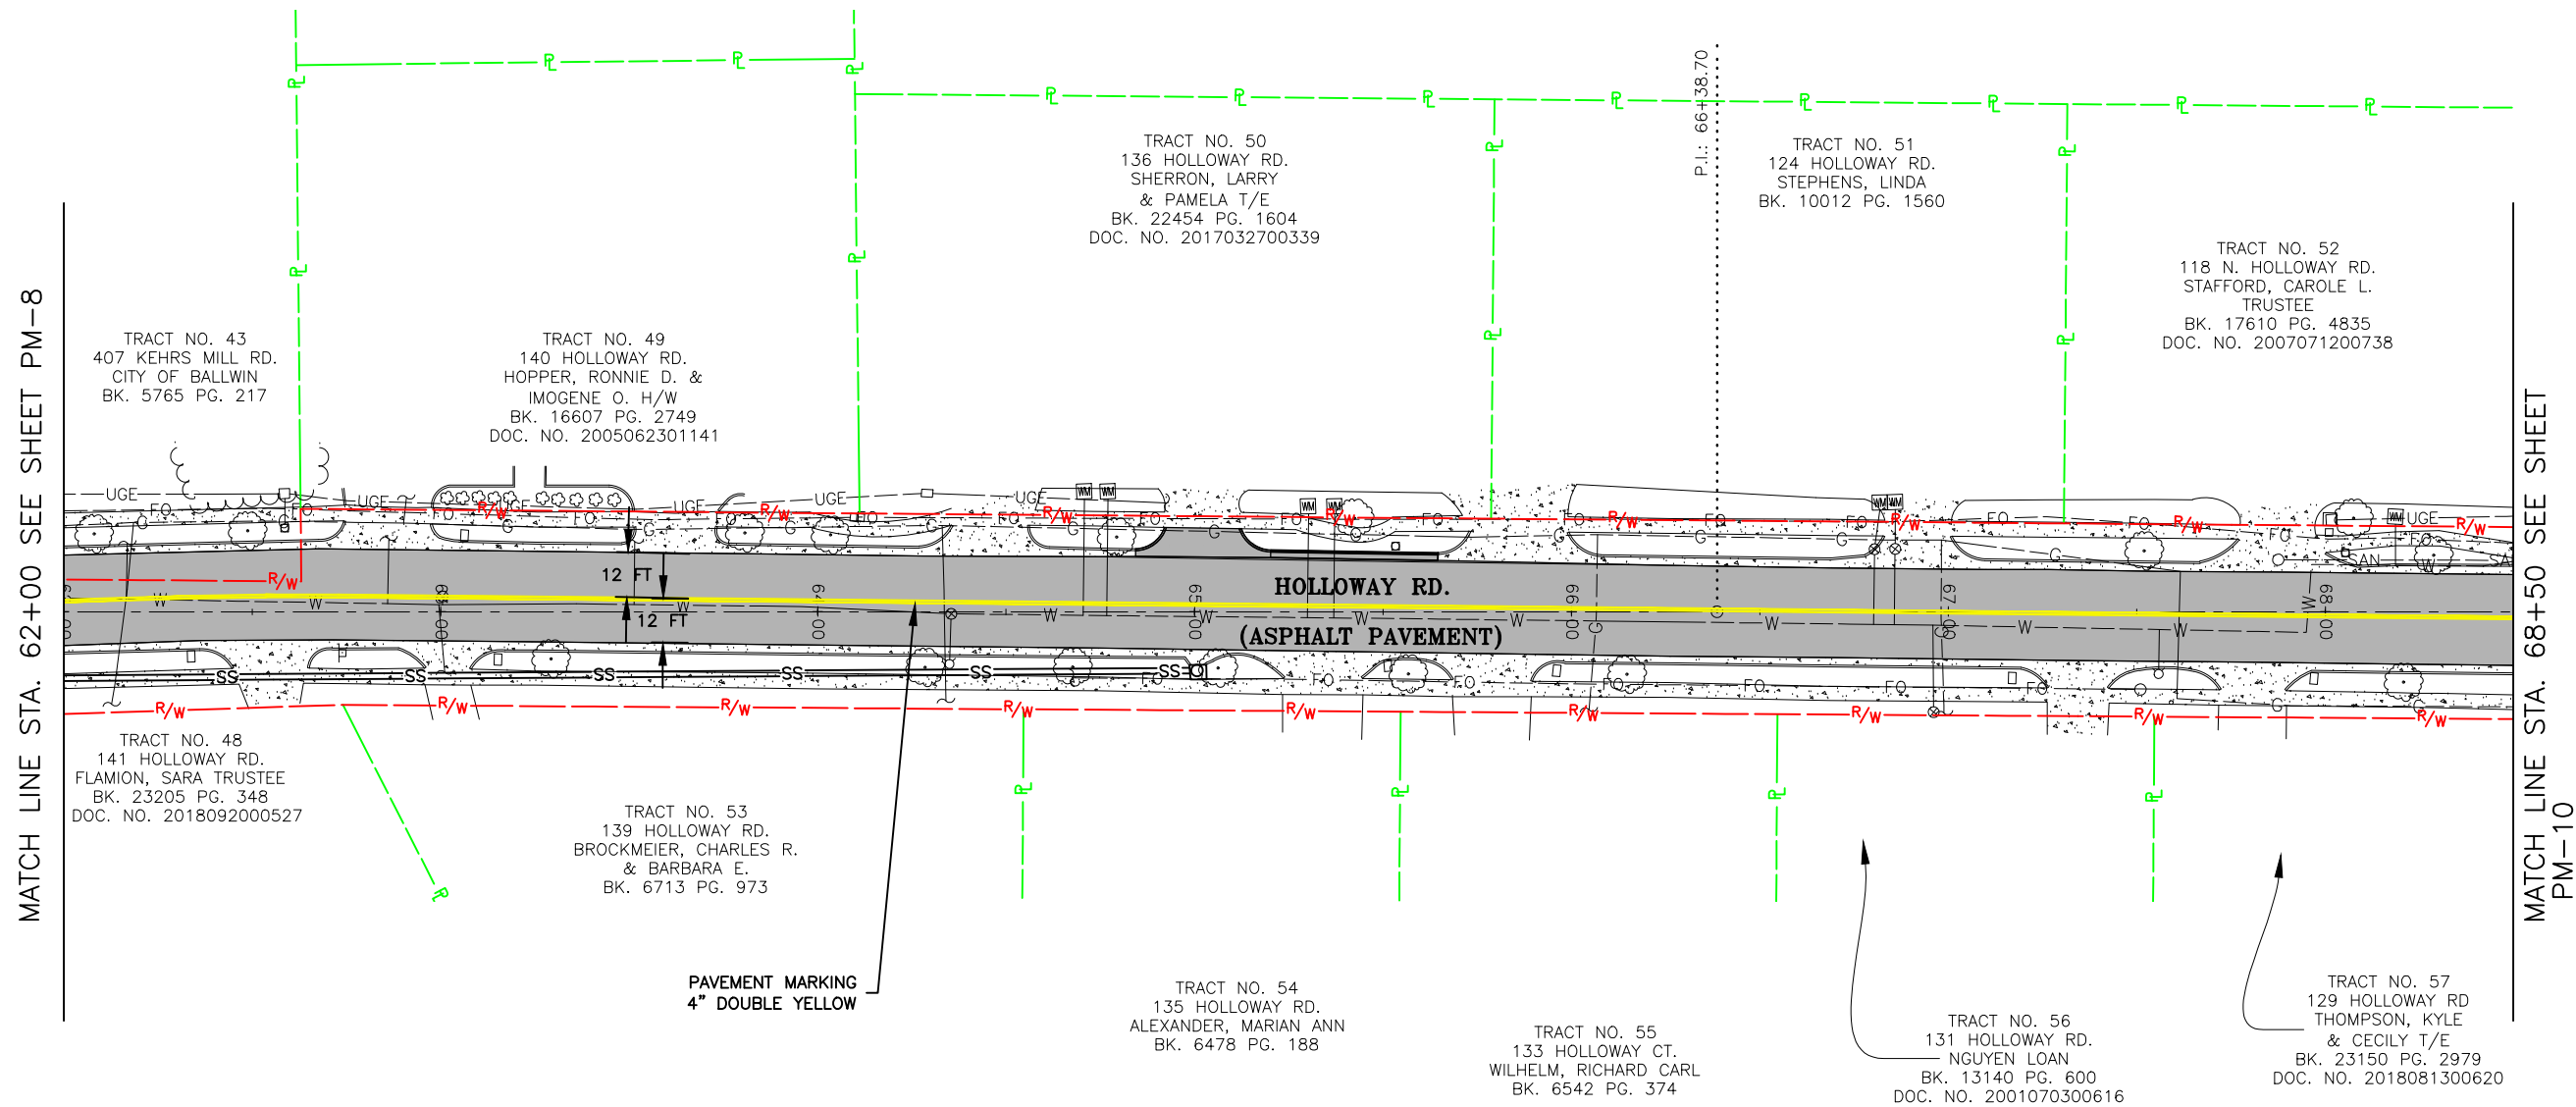
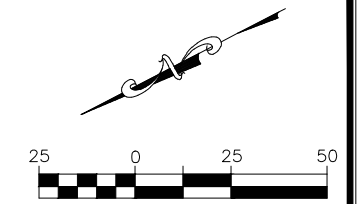
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FEDERAL PROJECT NO. STP-4939(608)
CITY OF BALLWIN, MISSOURI

PAVEMENT MARKING AND SIGNAGE

DATE	REVISION

DWN. BY:	APPD. BY:
K.J.W.	M.D.S.
DATE:	JANUARY 2021
SCALE:	1" = 50'
PROJ. NO.:	SC19-981
DWG. NO.:	PM-8

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PE-200430889

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REGISTERED PROFESSIONAL ENGINEER
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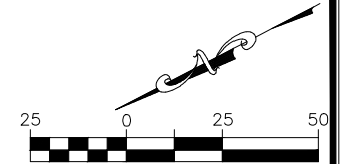
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FEDERAL PROJECT NO. STP-4939(608)
CITY OF BALLWIN, MISSOURI

PAVEMENT MARKING AND SIGNAGE	
DATE: _____	REVISION: _____
DWN BY: K.J.W.	APPD BY: M.D.S.
DATE: JANUARY 2021	
SCALE: 1" = 50'	
PROJ. NO: SC19-981	
DWG. NO: PM-9	

Drawing name: U:\SC19-981 Holloway Road, Ballwin, MO\AUTOCAD DRAWINGS\PAVEMENT MARKING AND SIGNAGE PLAN.dwg Tab: PM-9 Plotted on: Feb 09, 2021 - 10:31am Plotted by: kneliff

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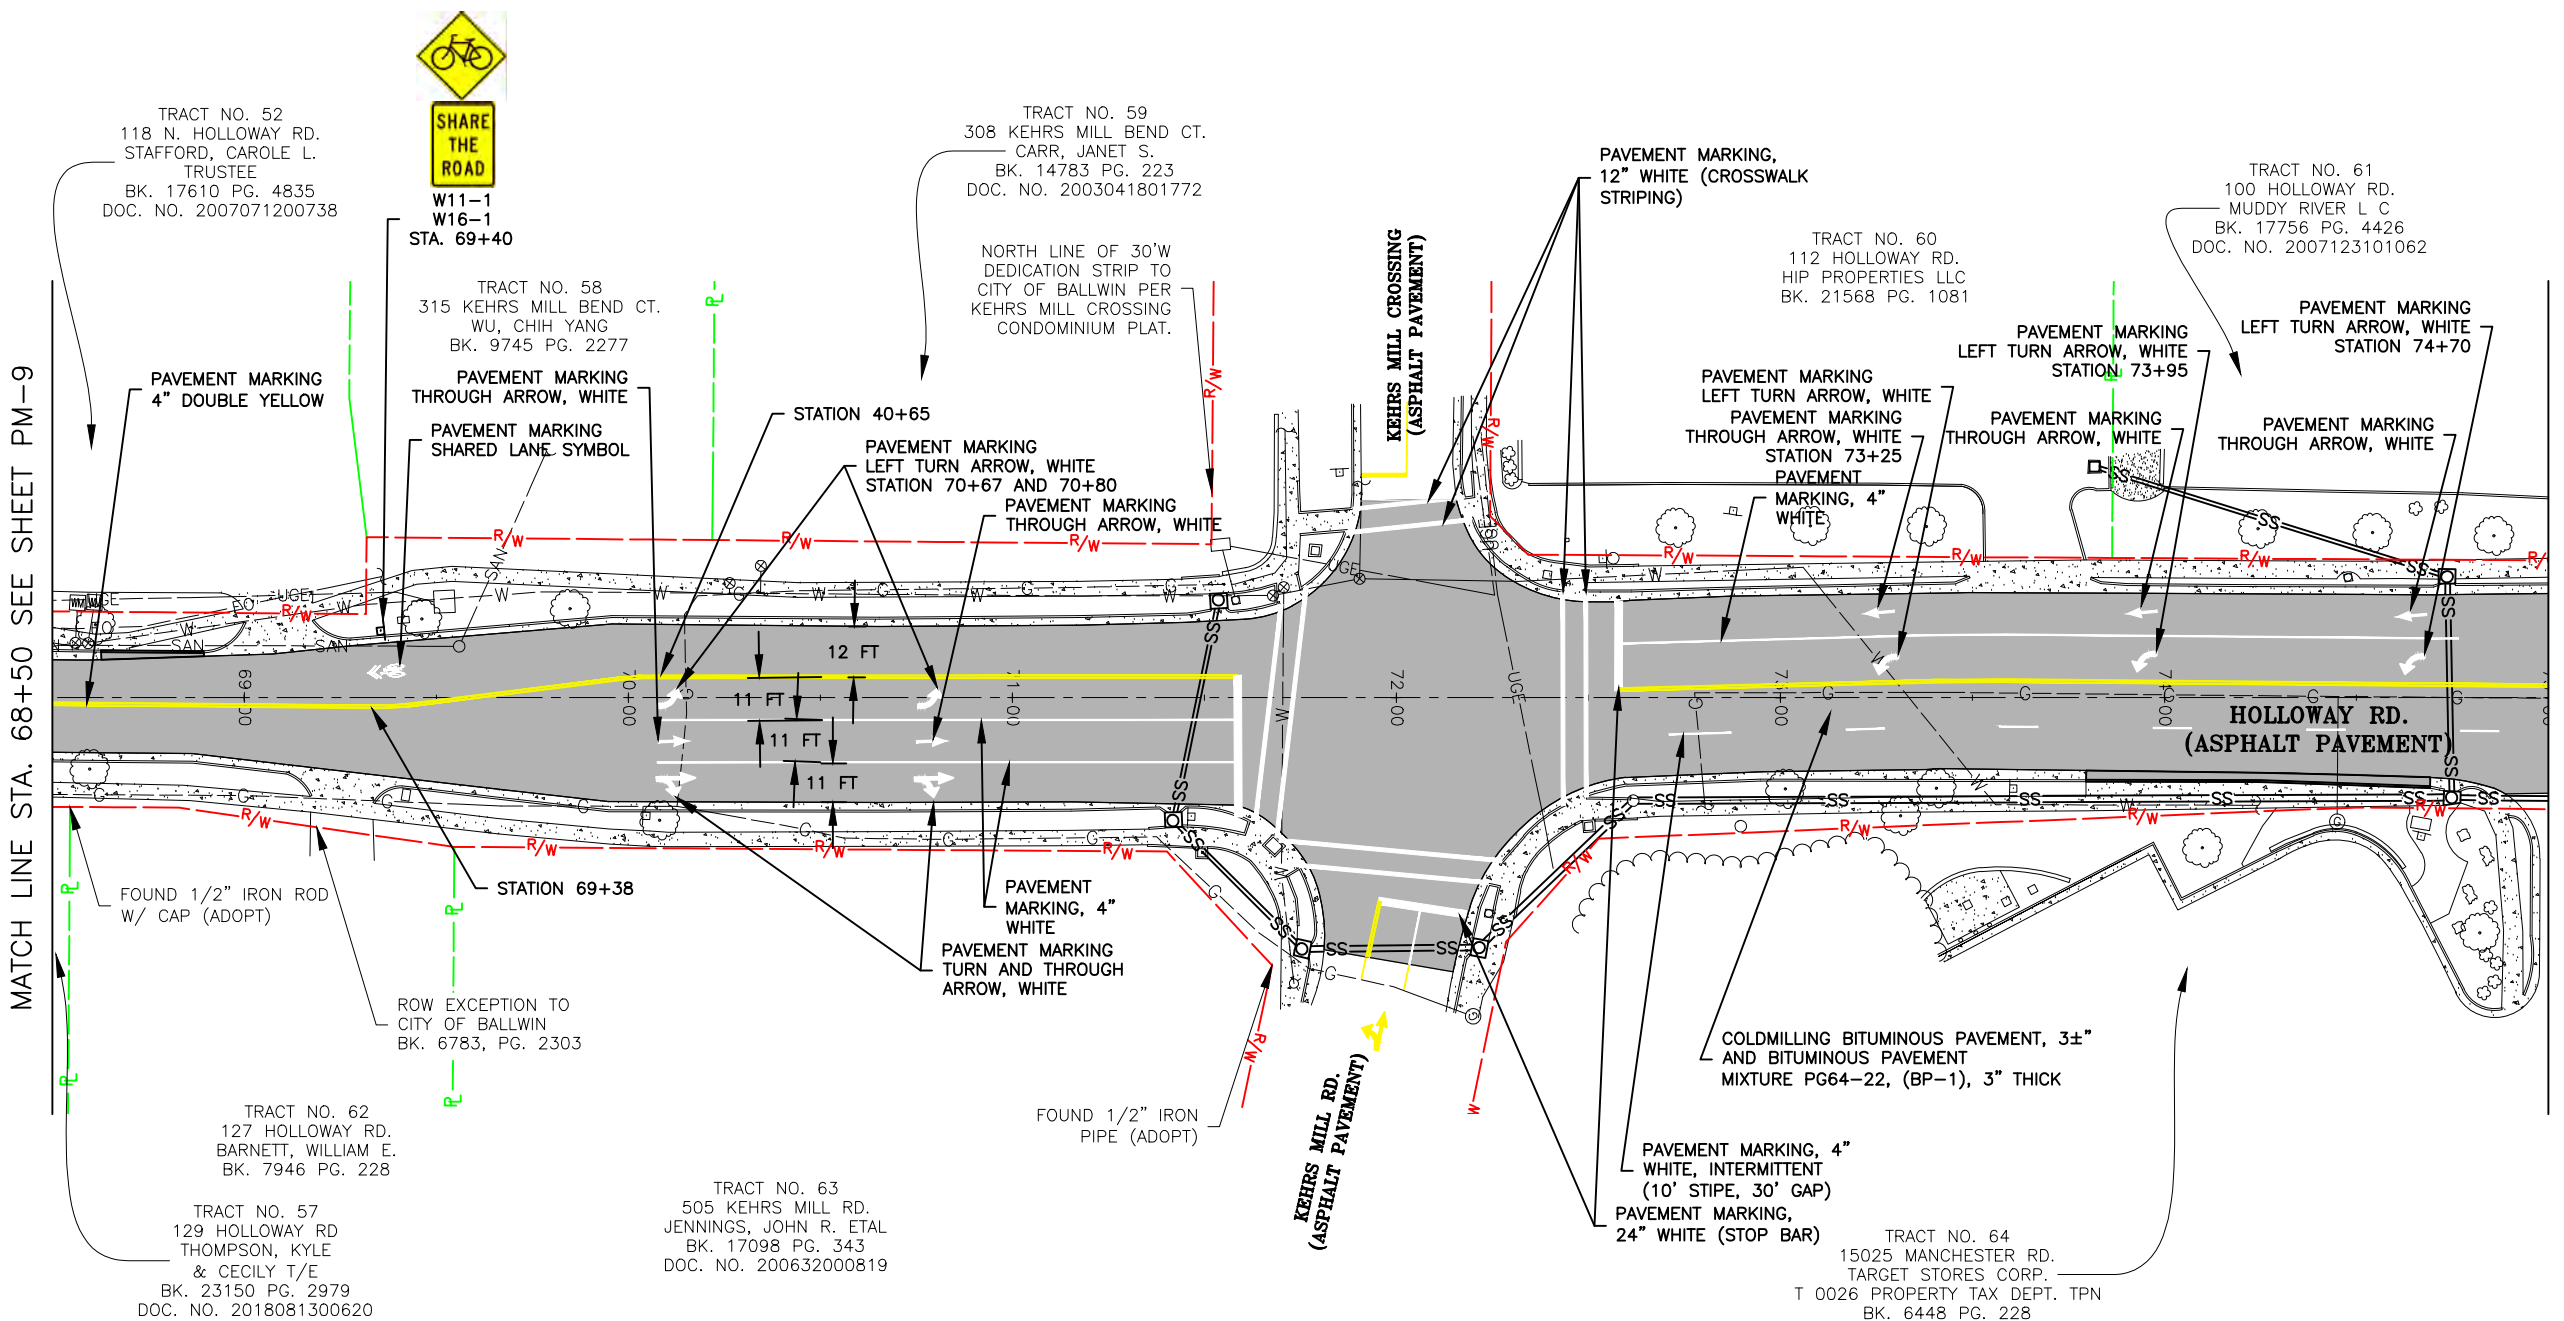
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FEDERAL PROJECT NO. STP-4939(608)
CITY OF BALLWIN, MISSOURI

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DWN. BY:	K.J.W.	APPD. BY:	M.D.S.
DATE:	JANUARY 2021	DATE:	
SCALE:	1" = 50'	SCALE:	
PROJ. NO.:	SC19-981	PROJ. NO.:	
DWG. NO.:	PM-10	DWG. NO.:	



MATCH LINE STA. 68+50 SEE SHEET PM-9

MATCH LINE STA. 75+00 SEE SHEET PM-11

TRACT NO. 52
118 N. HOLLOWAY RD.
STAFFORD, CAROLE L.
TRUSTEE
BK. 17610 PG. 4835
DOC. NO. 2007071200738

W11-1
W16-1
STA. 69+40

TRACT NO. 59
308 KEHRS MILL BEND CT.
CARR, JANET S.
BK. 14783 PG. 223
DOC. NO. 2003041801772

NORTH LINE OF 30'W
DEDICATION STRIP TO
CITY OF BALLWIN PER
KEHRS MILL CROSSING
CONDOMINIUM PLAT.

TRACT NO. 60
112 HOLLOWAY RD.
HIP PROPERTIES LLC
BK. 21568 PG. 1081

TRACT NO. 61
100 HOLLOWAY RD.
MUDDY RIVER L C
BK. 17756 PG. 4426
DOC. NO. 2007123101062

TRACT NO. 58
315 KEHRS MILL BEND CT.
WU, CHIH YANG
BK. 9745 PG. 2277

STATION 40+65
PAVEMENT MARKING
LEFT TURN ARROW, WHITE
STATION 70+67 AND 70+80
PAVEMENT MARKING
THROUGH ARROW, WHITE

PAVEMENT MARKING
LEFT TURN ARROW, WHITE
STATION 73+25
PAVEMENT
MARKING, 4"
WHITE

PAVEMENT MARKING
LEFT TURN ARROW, WHITE
STATION 73+95

PAVEMENT MARKING
LEFT TURN ARROW, WHITE
STATION 74+70

FOUND 1/2" IRON ROD
W/ CAP (ADOPT)

ROW EXCEPTION TO
CITY OF BALLWIN
BK. 6783, PG. 2303

TRACT NO. 62
127 HOLLOWAY RD.
BARNETT, WILLIAM E.
BK. 7946 PG. 228

TRACT NO. 57
129 HOLLOWAY RD
THOMPSON, KYLE
& CECILY T/E
BK. 23150 PG. 2979
DOC. NO. 2018081300620

TRACT NO. 63
505 KEHRS MILL RD.
JENNINGS, JOHN R. ETAL
BK. 17098 PG. 343
DOC. NO. 200632000819

FOUND 1/2" IRON
PIPE (ADOPT)

COLDMILLING BITUMINOUS PAVEMENT, 3±"
AND BITUMINOUS PAVEMENT
MIXTURE PG64-22, (BP-1), 3" THICK


PAVEMENT MARKING, 4"
WHITE, INTERMITTENT
(10' STIPE, 30' GAP)
PAVEMENT MARKING,
24" WHITE (STOP BAR)

TRACT NO. 64
15025 MANCHESTER RD.
TARGET STORES CORP.
T 0026 PROPERTY TAX DEPT. TPN
BK. 6448 PG. 228

Drawing name: U:\SC19-981 Holloway Road, Ballwin, MO\AUTOCAD DRAWINGS\PAVEMENT MARKING AND SIGNAGE PLAN.dwg Tab: PM-10 Plotted on: Feb 09, 2021 - 10:31am Plotted by: kwolff

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PAVEMENT MARKING AND SIGNAGE

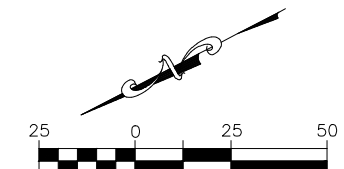

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STATE OF MISSOURI

KEVIN J. WOLFF, P.E.
NO. PE-200400889
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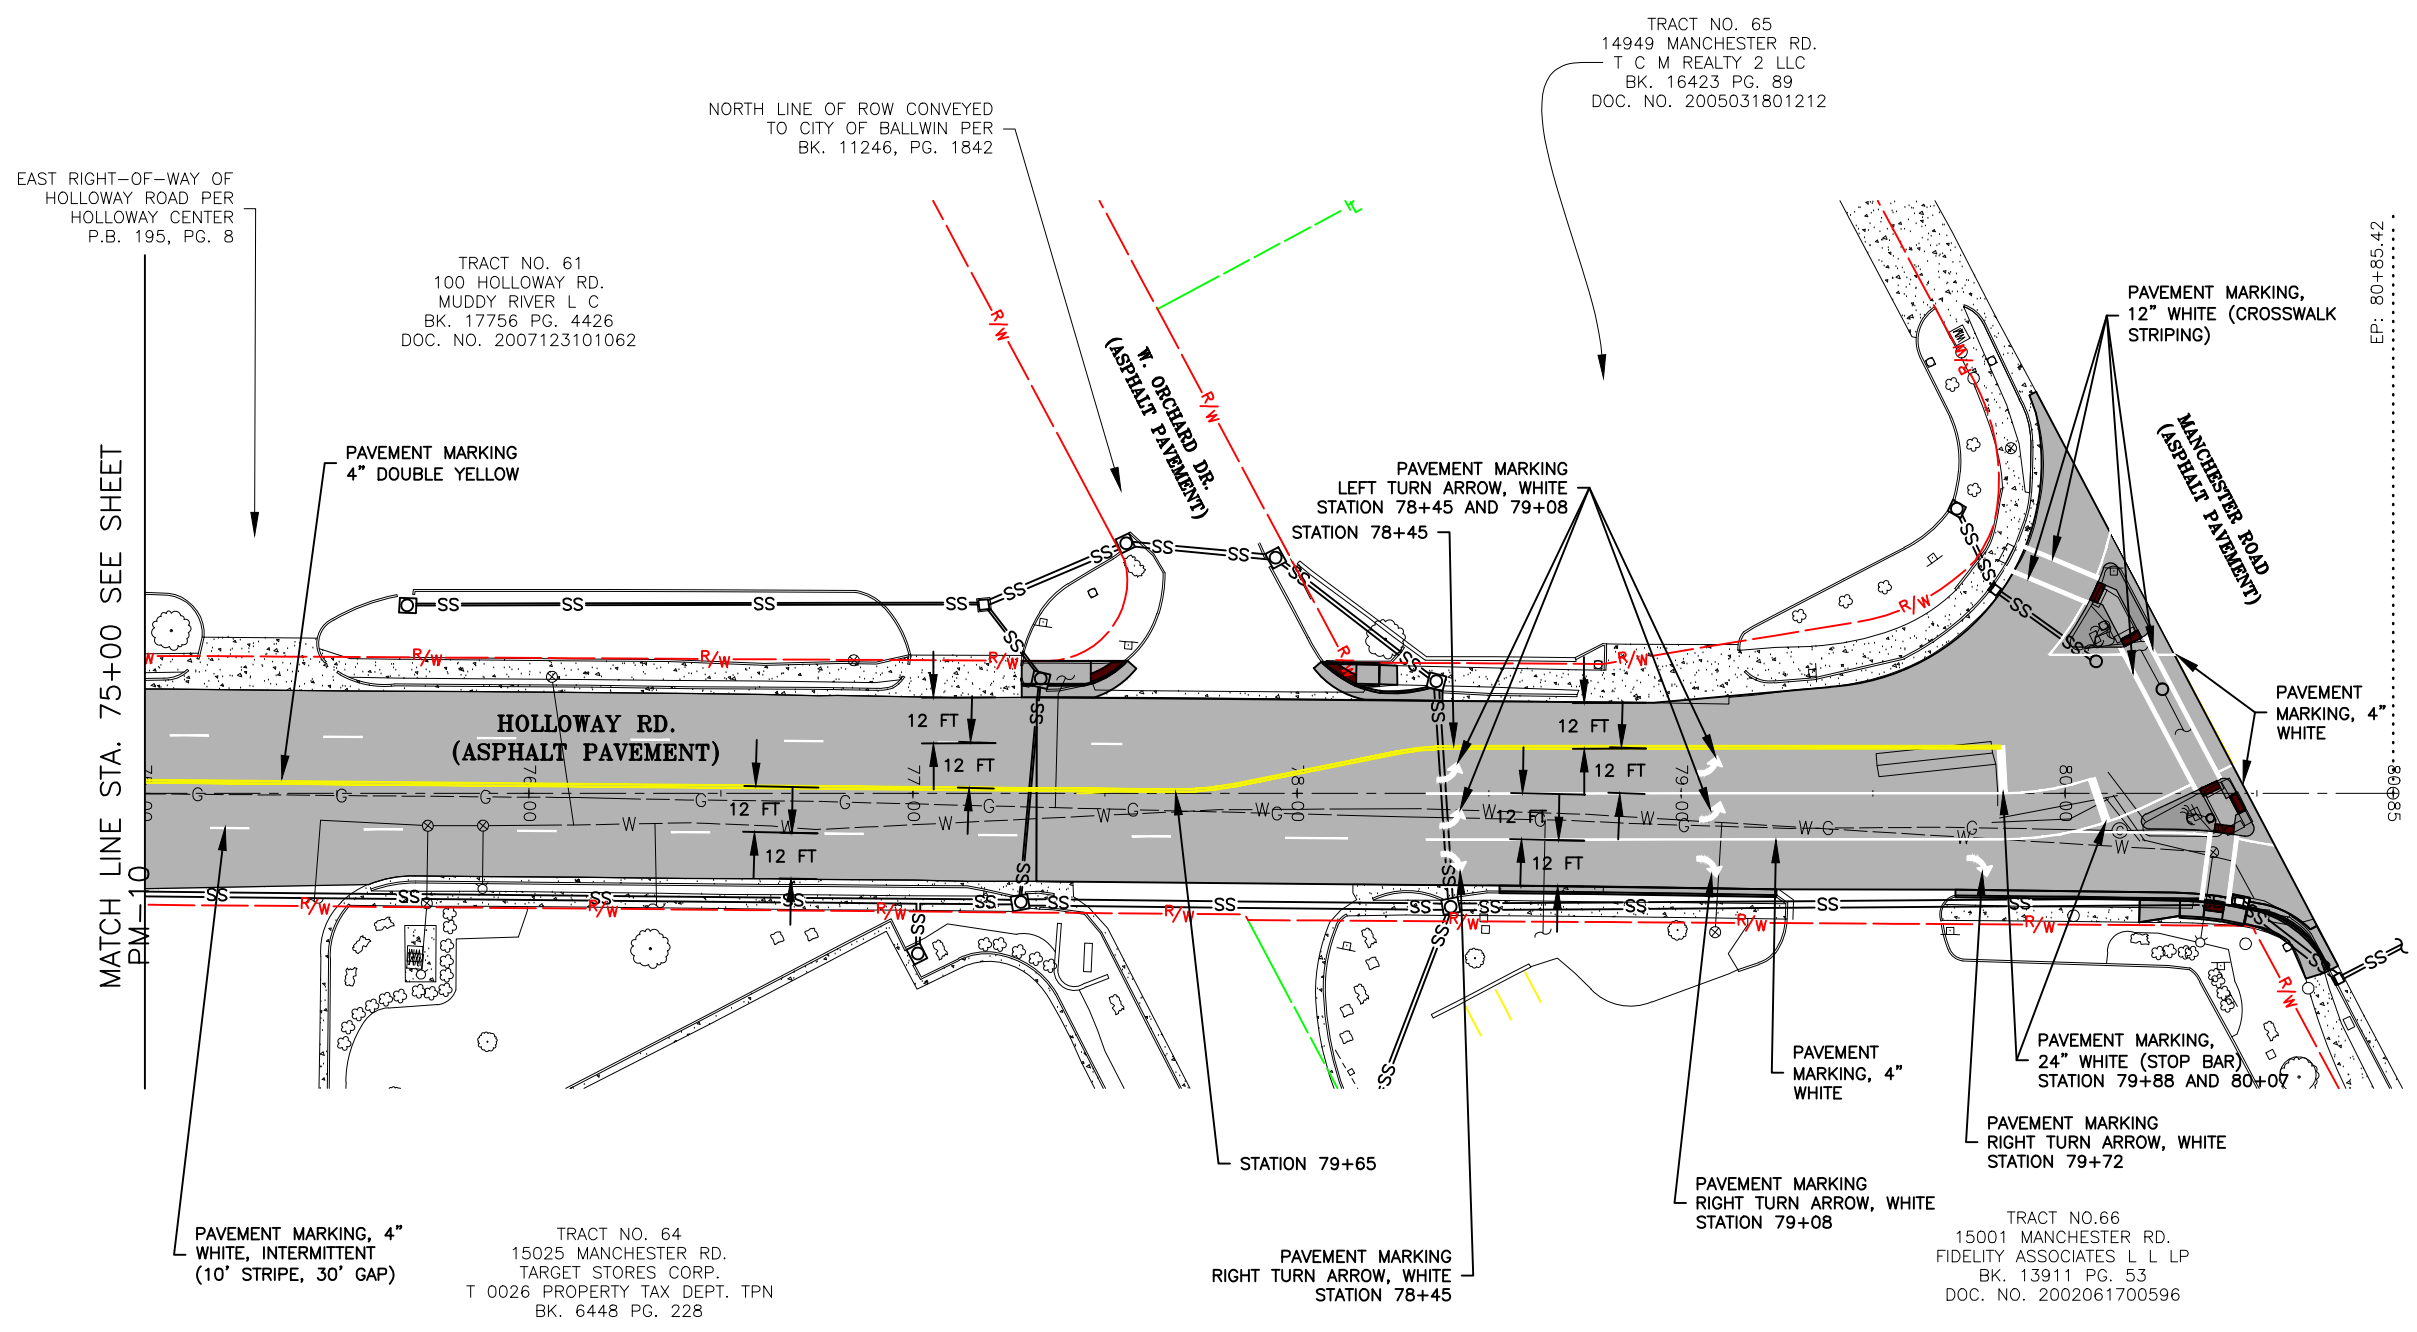
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CITY OF BALLWIN, MISSOURI

PAVEMENT MARKING AND SIGNAGE



DATE	REVISION

DWN BY: K.J.W. APPD BY: M.D.S.
DATE: JANUARY 2021
SCALE: 1" = 50'
PROJ. NO.: SC19-981
DWG. NO.: PM-11



Drawing name: U:\SC19-981 Holloway Road, Ballwin, MO\AUTOCAD DRAWINGS\PAVEMENT MARKING AND SIGNAGE PLAN.dwg Tab: PM-11 Plotted on: Feb 09, 2021 - 10:31am Plotted by: kwolf

PAVEMENT PHASING PLAN

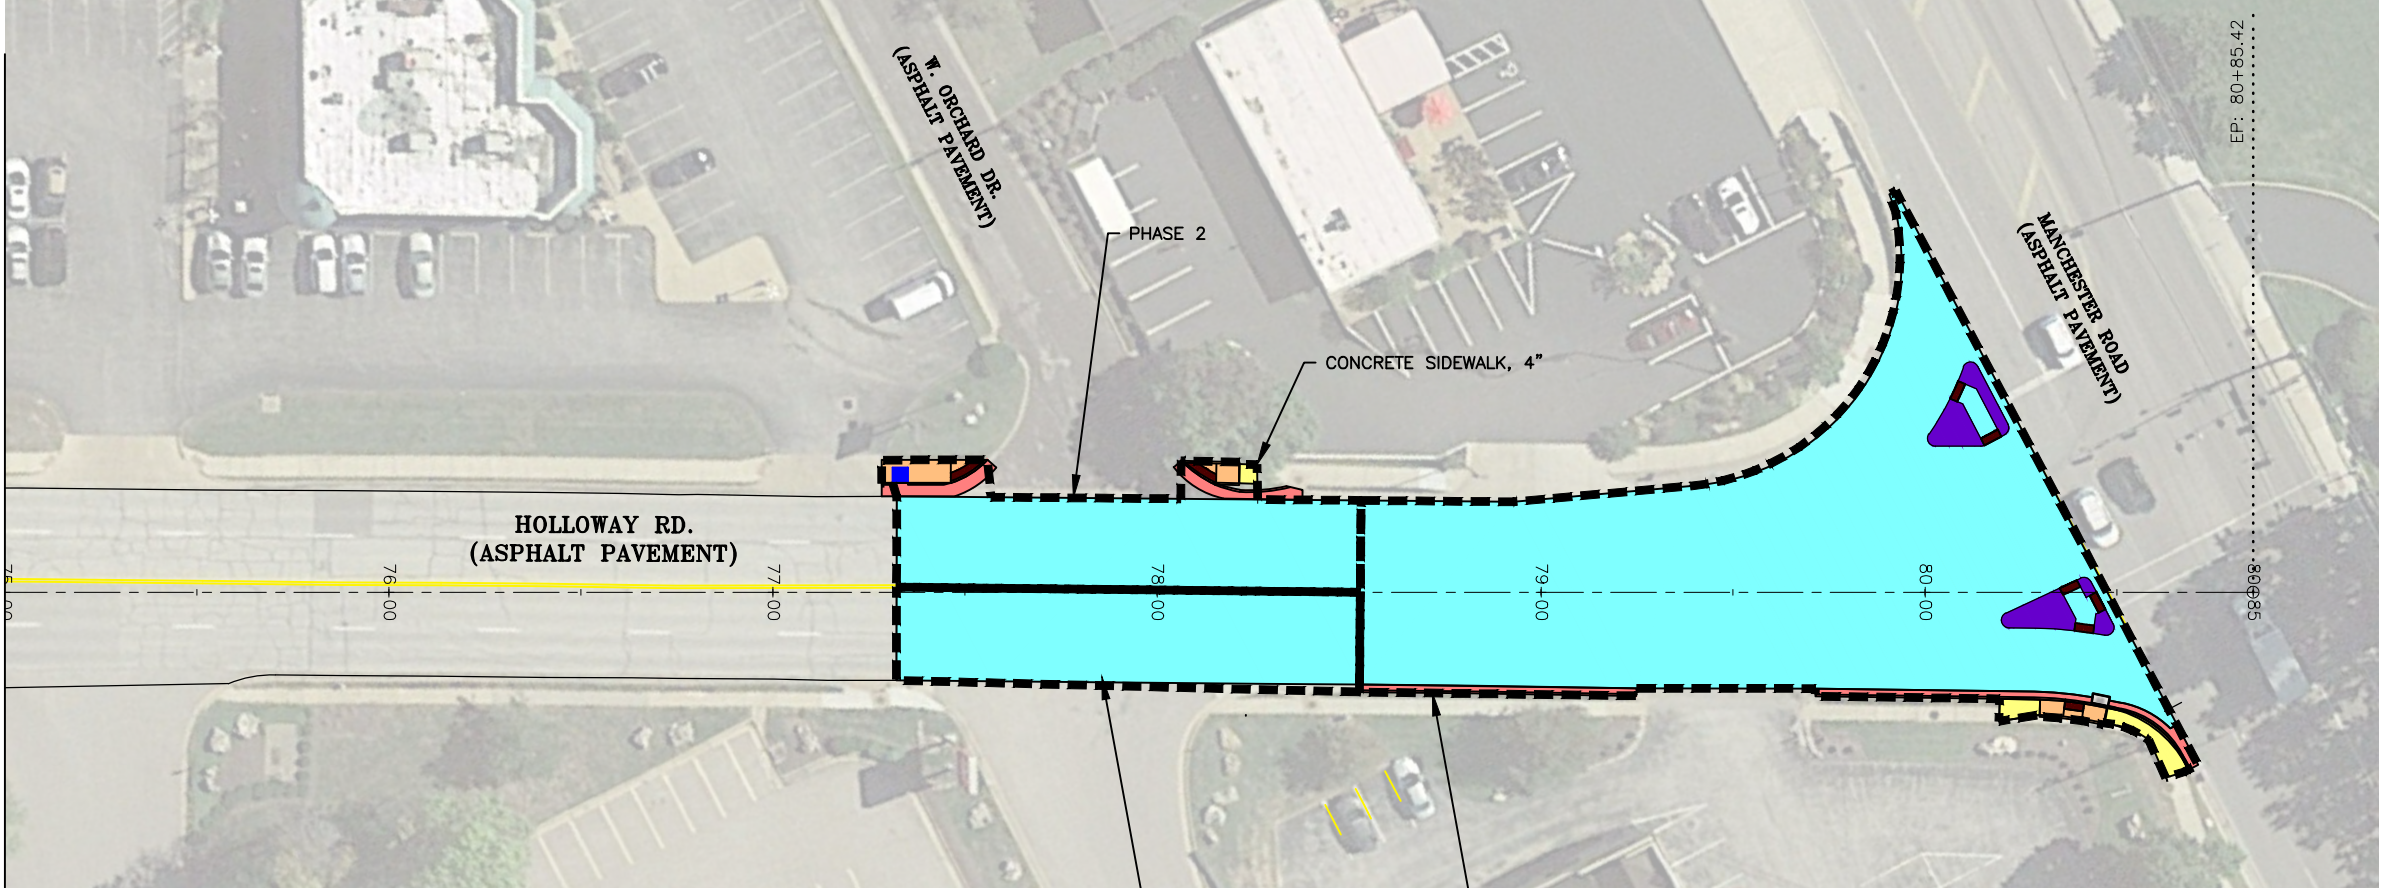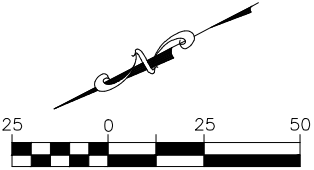

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





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HOLLOWAY ROAD IMPROVEMENTS
FEDERAL PROJECT NO. STP-4939(608)
CITY OF BALLWIN, MISSOURI

PAVEMENT PHASING PLAN	
DATE:	REVISION:
DWN. BY: K.J.W.	APPD. BY: M.D.S.
DATE: JANUARY 2021	
SCALE: 1" = 50'	
PROJ. NO: SC19-981	
DWG. NO: PH-1	

Drawing name: U:\SC19-981 Holloway Road, Ballwin, MO\AUTOCAD DRAWINGS\PHASING PLAN.dwg Tab: PH-1 Plotted on: Feb 09, 2021 - 10:31am Plotted by: kwloff

TRAFFIC CONTROL - PHASE 1

 ROAD WORK AHEAD (W20-1) ①	 ROAD CLOSED (R11-2) ②	 DETOUR HOLLOWAY ROAD ③
 DETOUR HOLLOWAY ROAD ④	 DETOUR HOLLOWAY ROAD ⑤	 END DETOUR HOLLOWAY ROAD ⑥

PHASE 1 NOTES:

1. CONTRACTOR WILL BE PERMITTED TO CLOSE HOLLOWAY ENTIRELY WITHIN THE PHASE 1 LIMITS FOR A MAXIMUM OF 10 DAYS.
2. CONTRACTOR WILL COORDINATE CLOSURE WITH MODOT AND THE CITY OF BALLWIN.
3. CONTRACTOR WILL COVER ANY TURN ARROWS AND PEDESTRIAN SIGNALS DURING CLOSURE.
4. SIGNAGE WILL BE AS SHOWN UNLESS PERMITTED OTHERWISE BY MODOT.
5. CONTRACTOR WILL BE PERMITTED TO CONSTRUCT PHASE 2 AND PHASE 3 AS PART OF PHASE 1 PROVIDED THERE IS NO INCREASE TO THE MAXIMUM NUMBER OF DAYS THE INTERSECTION IS CLOSED (10 DAYS) AND ADDITIONAL TYPE III BARRICADES ARE PLACED TO CLOSE W. ORCHARD AND THE SOUTHERN TARGET ENTRANCE.



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 FENTON, MISSOURI 63026

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 LAND SURVEYING CERTIFICATE OF AUTHORITY NUMBER - 2007004529

STATE OF MISSOURI
 KEVIN J. WOLFF, P.E.
 1/28/21
 NO. PE-200400859
 STATE OF MISSOURI
 REGISTERED PROFESSIONAL ENGINEER
 FOR SC ENGINEERING LLC,
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

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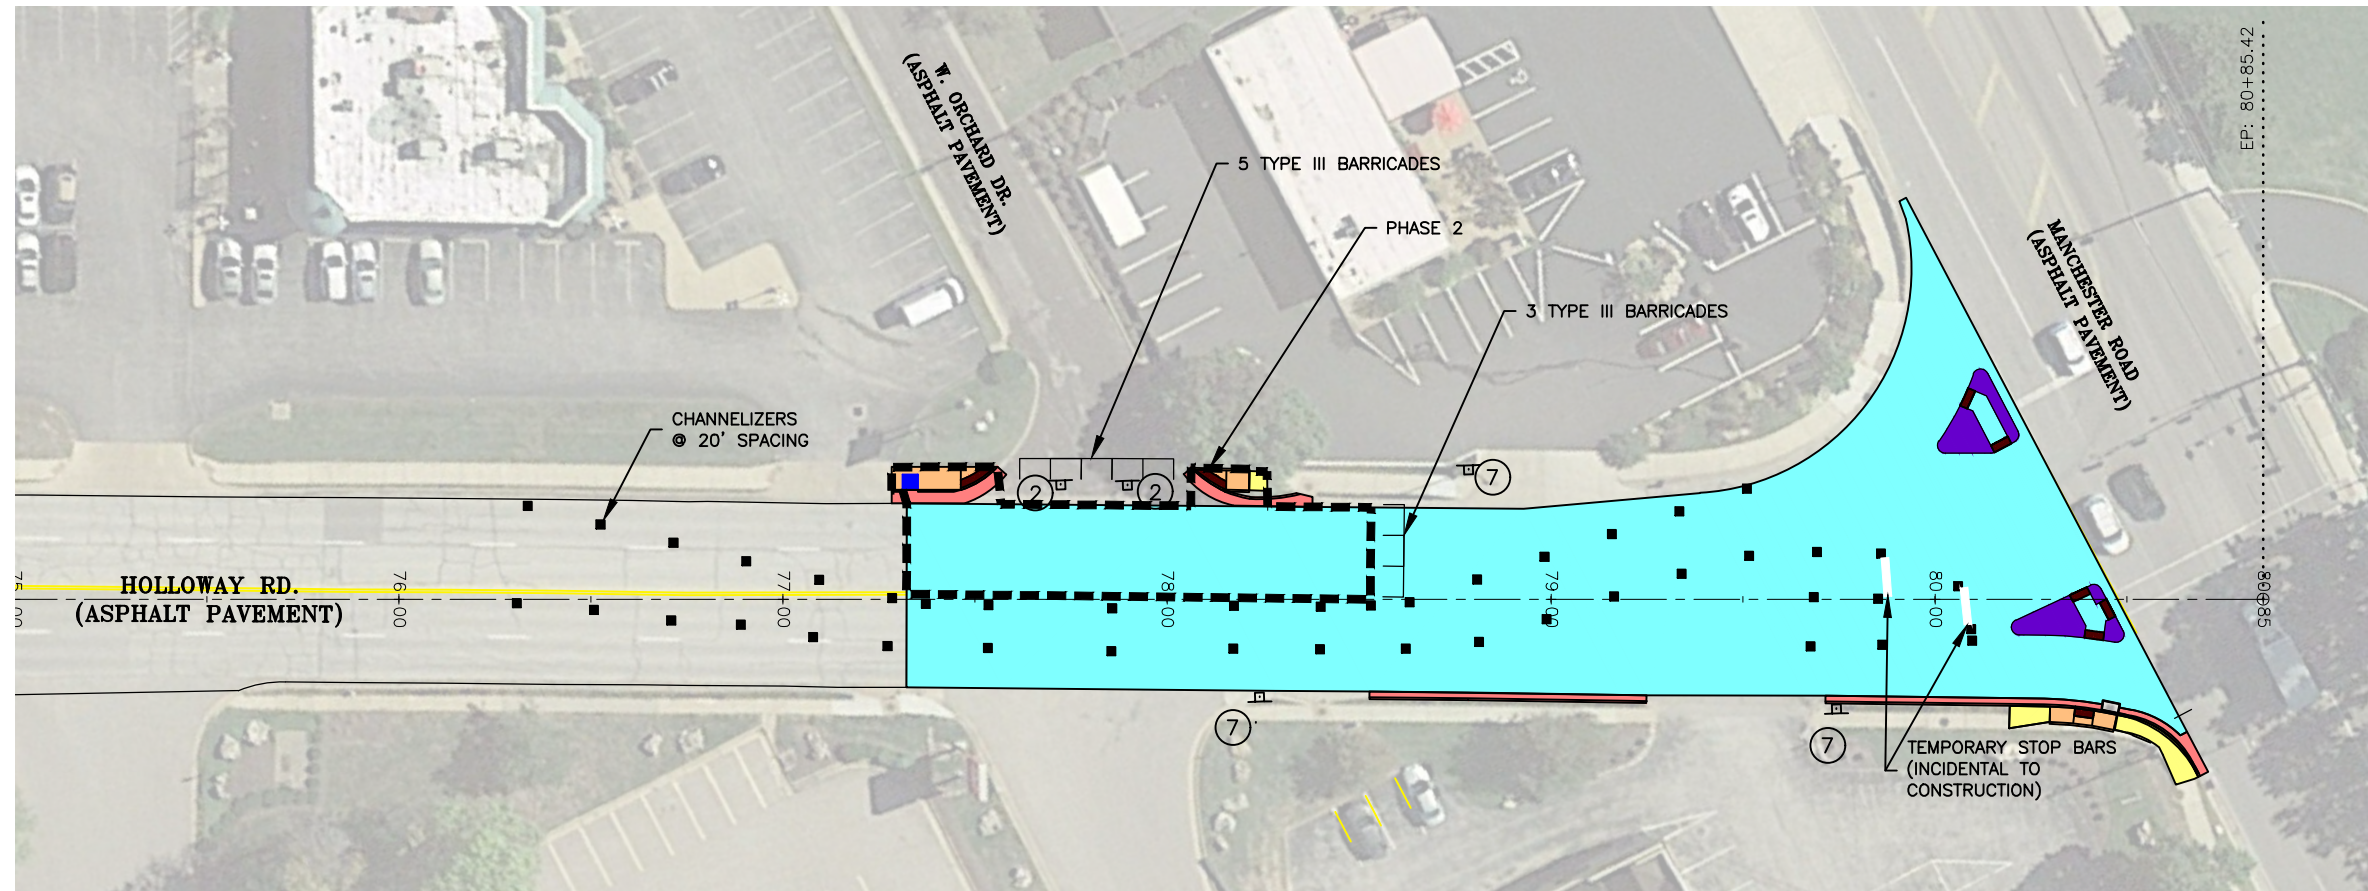
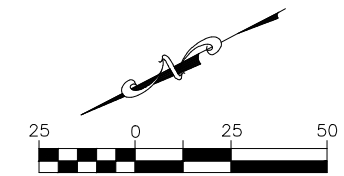
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 FEDERAL PROJECT NO. STP-4939(608)
 CITY OF BALLWIN, MISSOURI

TRAFFIC CONTROL - PHASE 1	
DATE:	REVISION:
DWN. BY:	APPD. BY:
K.J.W.	M.D.S.
DATE:	JANUARY 2021
SCALE:	1" = 100'
PROJ. NO.:	SC19-981
DWG. NO.:	TC-1

Drawing name: U:\SC19-981 Holloway Road, Ballwin, MO\AUTOCAD DRAWINGS\PHASING PLAN.dwg Tab: TC-1 Plotted on: Feb 09, 2021 - 10:31am Plotted by: kwolff

TRAFFIC CONTROL - PHASE 2

 ROAD CLOSED (R11-2) ②	 NO LEFT TURN (R3-2) ⑦
---	---



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STATE OF MISSOURI

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N. J. WOLFF
PE 2011

1/28/21
KEVIN J. WOLFF
NO. PE 200400859
STATE OF MISSOURI
REGISTERED PROFESSIONAL ENGINEER
FOR SC ENGINEERING LLC,
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

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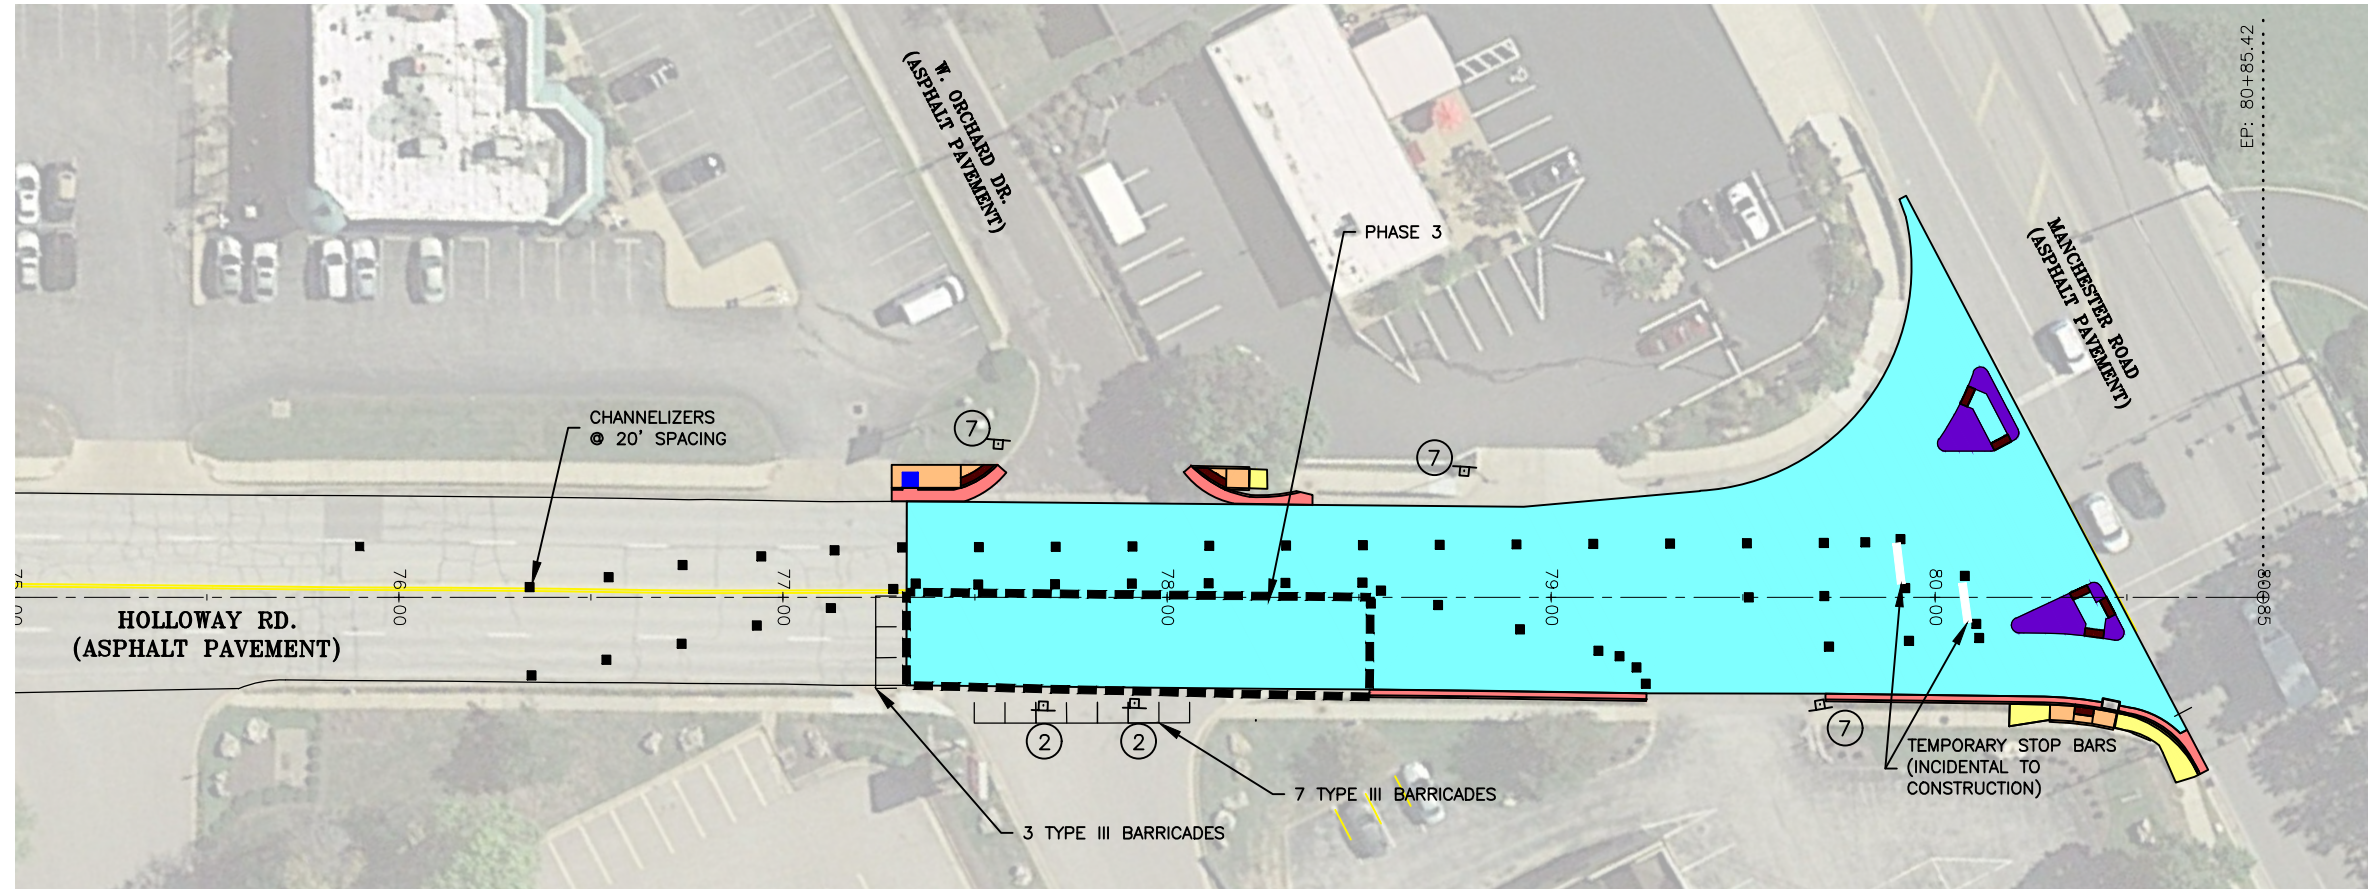
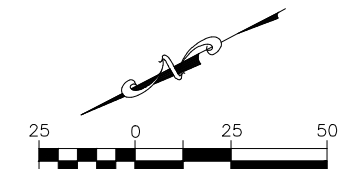
HOLLOWAY ROAD IMPROVEMENTS
FEDERAL PROJECT NO. STP-4939(608)
CITY OF BALLWIN, MISSOURI

TRAFFIC CONTROL - PHASE 2	
DATE:	REVISION:
DWN. BY:	APPD. BY:
K.J.W.	M.D.S.
DATE:	JANUARY 2021
SCALE:	1" = 50'
PROJ. NO.:	SC19-981
DWG. NO.:	TC-2

Drawing name: U:\SC19-981 Holloway Road, Ballwin, MO\AUTOCAD DRAWINGS\PHASING PLAN.dwg Tab: TC-2 Plotted on: Feb 09, 2021 - 10:31am Plotted by: kwolff

TRAFFIC CONTROL - PHASE 3

 ROAD CLOSED (R11-2) ②	 NO LEFT TURN (R3-2) ⑦
---	---



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STATE OF MISSOURI

KEVIN J. WOLFF, P.E.
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HOLLOWAY ROAD IMPROVEMENTS
 FEDERAL PROJECT NO. STP-4939(608)
 CITY OF BALLWIN, MISSOURI

TRAFFIC CONTROL - PHASE 3	
DATE:	REVISION:
DWN. BY: K.J.W.	APPD. BY: M.D.S.
DATE: JANUARY 2021	
SCALE: 1" = 50'	
PROJ. NO: SC19-981	
DWG. NO: TC-3	

Drawing name: U:\SC19-981 Holloway Road, Ballwin, MO\AUTOCAD DRAWINGS\PHASING PLAN.dwg Tab: TC-3 Plotted on: Feb 09, 2021 - 10:31am Plotted by: kwolff

TRAFFIC CONTROL DETAILS

616.8.6 (TA-6) SHOULDER WORK WITH MINOR ENCROACHMENT ON DIVIDED AND UNDIVIDED HIGHWAYS - DE/CM

www.invarion.com

SPEED Normal Posted (mph)	SIGN SPACING (ft.)		TAPER LENGTH (ft.)		OPTIONAL BUFFER LENGTH (ft.) (B)	CHANNELIZER SPACING (ft.)	
	Undivided (S)	Divided (S)	Shoulder (1) (T1)	Lane (2) (T2)		Tapers	Buffer/ Work Areas
0-35	200	200	70	245	280	35	40
40-45	350	500	150	540	400	40	80
50-55	500	1000	185	660	560	50	80
60-70	1000	SA - 1000 SB - 1500 SC - 2640	235	840	840	60	120

1 Shoulder taper length based on 10 ft. (standard shoulder width) offset. 2. Lane taper length based on 12 ft. (standard lane width) offset.

NOTES:

PROVIDE SIGNS ON LEFT AND RIGHT SIDES OF DIVIDED HIGHWAYS

ROAD WORK AHEAD SIGN NOT NEEDED IF SHOULDER WORK IS LOCATED WITHIN THE LIMITS OF AN ACTIVITY AREA WHERE ANOTHER ROAD WORK AHEAD SIGN IS ALREADY USED.

SEE EPG 616.12 WORK ZONE SPEED LIMITS FOR SPEED LIMIT GUIDELINES.


(3) NEXT XX MILES SIGN NOT REQUIRED FOR NARROW LANE SECTIONS LESS THAN ONE MILE.

THE PROTECTIVE VEHICLE MAY BE OMITTED IF A TAPER AND CHANNELIZING DEVICES ARE USED.

VEHICLE - MOUNTED SIGNS SHALL BE MOUNTED IN A MANNER SUCH THAT THEY ARE NOT OBSCURED BY EQUIPMENT OR SUPPLIES. SIGN LEGENDS ON VEHICLE - MOUNTED SIGNS SHALL BE COVERED OR TURNED FROM VIEW WHEN WORK IS NOT IN PROGRESS.

VEHICLE HAZARD WARNING SIGNALS SHALL NOT BE USED INSTEAD OF VEHICLE'S ROTATING LIGHTS OR STROBE LIGHTS

SHADOW AND WORK VEHICLES SHALL DISPLAY HIGH-DENSITY ROTATING, FLASHING, OSCILLATING, OR STROBE LIGHTS.

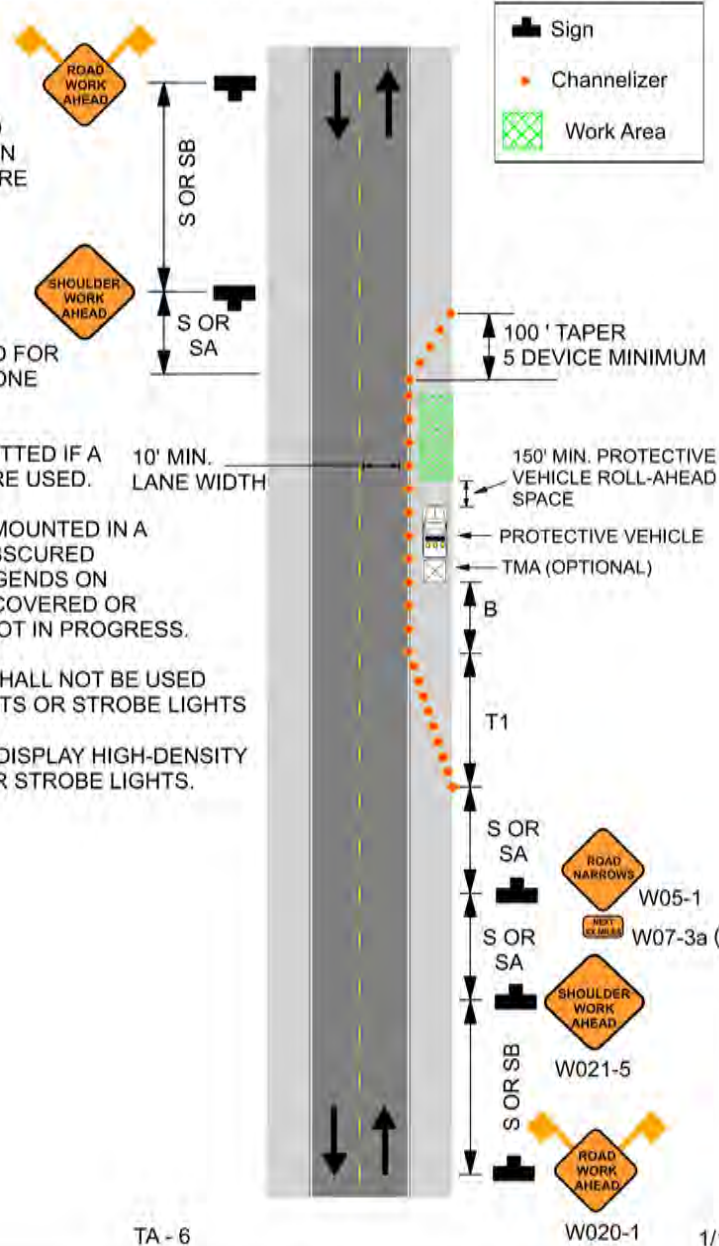

TA - 6 1/16

616.8.10 (TA-10) LANE CLOSURE ON TWO-LANE ROAD USING FLAGGERS - DE/CM

www.invarion.com

SPEED Permanent Posted (mph)	SIGN SPACING (ft.)		TAPER LENGTH (ft.)		OPTIONAL BUFFER LENGTH (ft.) (B)	CHANNELIZER SPACING (ft.)	
	Undivided (S)	Divided (S)	Shoulder (1) (T1)	Lane (2) (T2)		Tapers	Buffer/ Work Areas
0-35	200	-	-	-	280	-	40
40-45	350	-	-	-	400	-	80
50-55	500	-	-	-	560	-	80
60-70	1000	-	-	-	840	-	120

1 Shoulder taper length based on 10 ft. (standard shoulder width) offset. 2. Lane taper length based on 12 ft. (standard lane width) offset.

NOTES:


AUTOMATED FLAGGER ASSISTANCE DEVICES (AFAD) AND PORTABLE SIGNAL FLAGGING DEVICES (PSFD) MAY BE USED AS AN ALTERNATIVE FLAGGING OPERATION.

AFAD AND PSFD TYPICAL APPLICATIONS AND CRITERIA ARE LOCATED AT THE FOLLOWING:
EPG 616.8.10A (TA-10A) LANE CLOSURE ON TWO-LANE HIGHWAYS USING AUTOMATED FLAGGER ASSISTANCE DEVICE WITH RED AND AMBER SIGNAL SYSTEM & EPG 616.8.10C (TA-10C) LANE CLOSURE ON TWO-LANE HIGHWAYS USING PORTABLE SIGNAL FLAGGING DEVICE.

SEE EPG 616.12 WORK ZONE SPEED LIMITS FOR SPEED LIMIT GUIDELINES.

IF RUMBLE STRIPS ARE USED, REVIEW 616.6.87 RUMBLE STRIPS.

IF USED AT NIGHT, THE FLAGGER STATIONS SHALL BE ILLUMINATED WITH AN AVERAGE MAINTAINED INTENSITY OF 0.6 FOOTCANDLES (6.5 LUX).

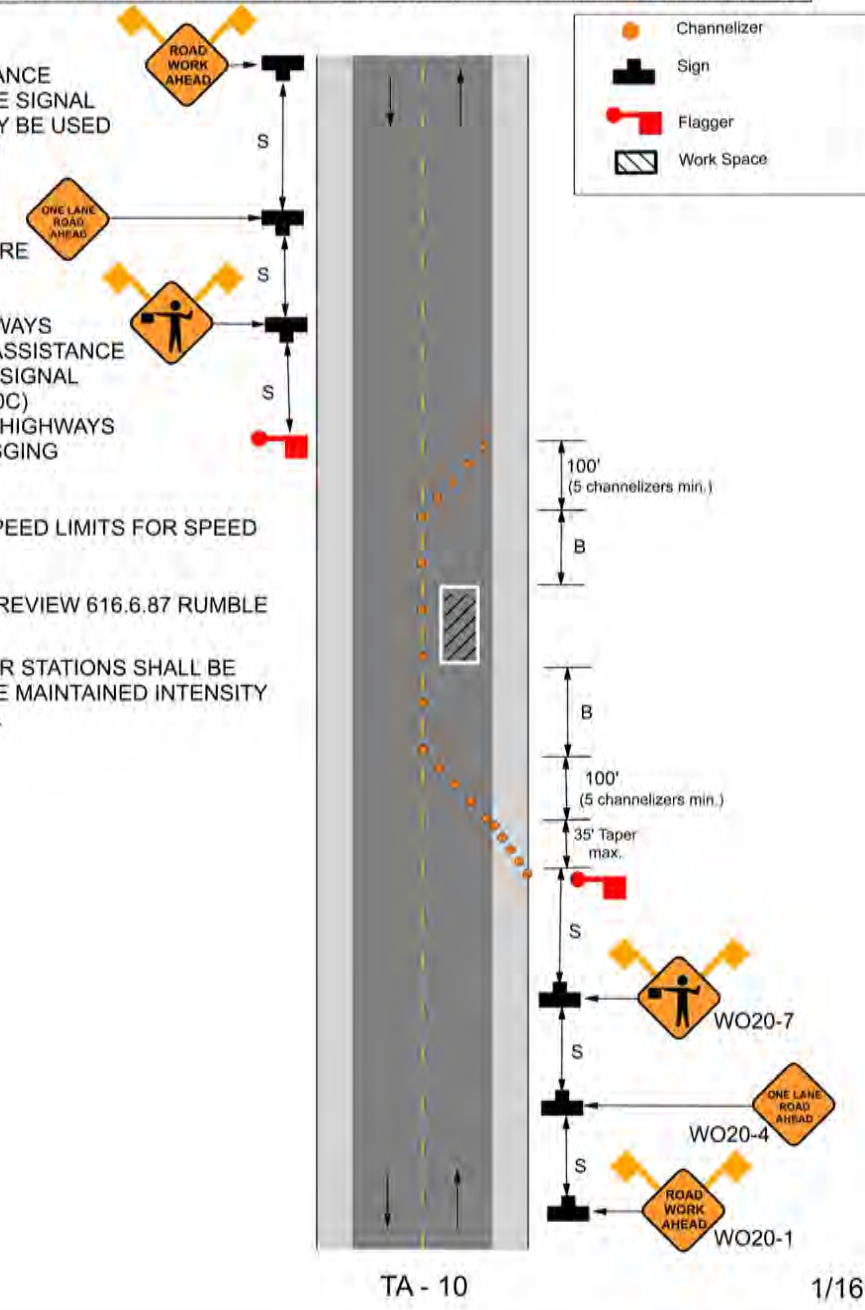

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STATE OF MISSOURI
KEVIN J. WOLFF, P.E.
Professional Engineer
1/28/21
NO. PE-200400859
STATE OF MISSOURI
REGISTERED PROFESSIONAL ENGINEER
FOR SC ENGINEERING LLC,
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FEDERAL PROJECT NO. STP-4939(608)
CITY OF BALLWIN, MISSOURI

TRAFFIC CONTROL DETAILS

DATE:	REVISION:

DWN. BY: K.J.W. APPD. BY: M.D.S.
DATE: JANUARY 2021
SCALE: NO SCALE
PROJ. NO: SC19-981
DWG. NO: TC-4

Drawing name: U:\SC19-981 Holloway Road, Ballwin, MO\AUTOCAD DRAWINGS\PHASING PLAN.dwg Tab: TC-4 Plotted on: Feb 09, 2021 - 10:31am Plotted by: kwolff

EROSION CONTROL PLAN



TRACT NO. 1
246 CEDAR TRAIL DR.
SIMMONS, MARY L.
BK. 8488 PG. 1034

TRACT NO. 2
244 CEDAR TRAIL DR.
KATZ, JANET
BK. 18926 PG. 2788

TRACT NO. 3
242 CEDAR TRAIL DR.
KORVAS, ROBERT G.
& MARGARET K. H/W
BK. 17531 PG. 3400


TRACT NO. 4
6 PARKROSE CT.
THE DILLON FAMILY, TRUST
BK. 20660 PG. 1506

TRACT NO. 5
7 PARKROSE CT.
HAUN, DANIEL & LORI H/W
BK. 17760 PG. 3498

TRACT NO. 6
8 PARKROSE CT.
SCHNEIDER, JOAN
LIVING TRUST
BK. 21261 PG. 503

TRACT NO. 7
9 PARKROSE CT.
RITCHIEY, CELIA A.
BK. 11899 PG. 350

TRACT NO. 9
333 HOLLOWAY RD.
CITY OF BALLWIN
BK. 6706 PG. 1598

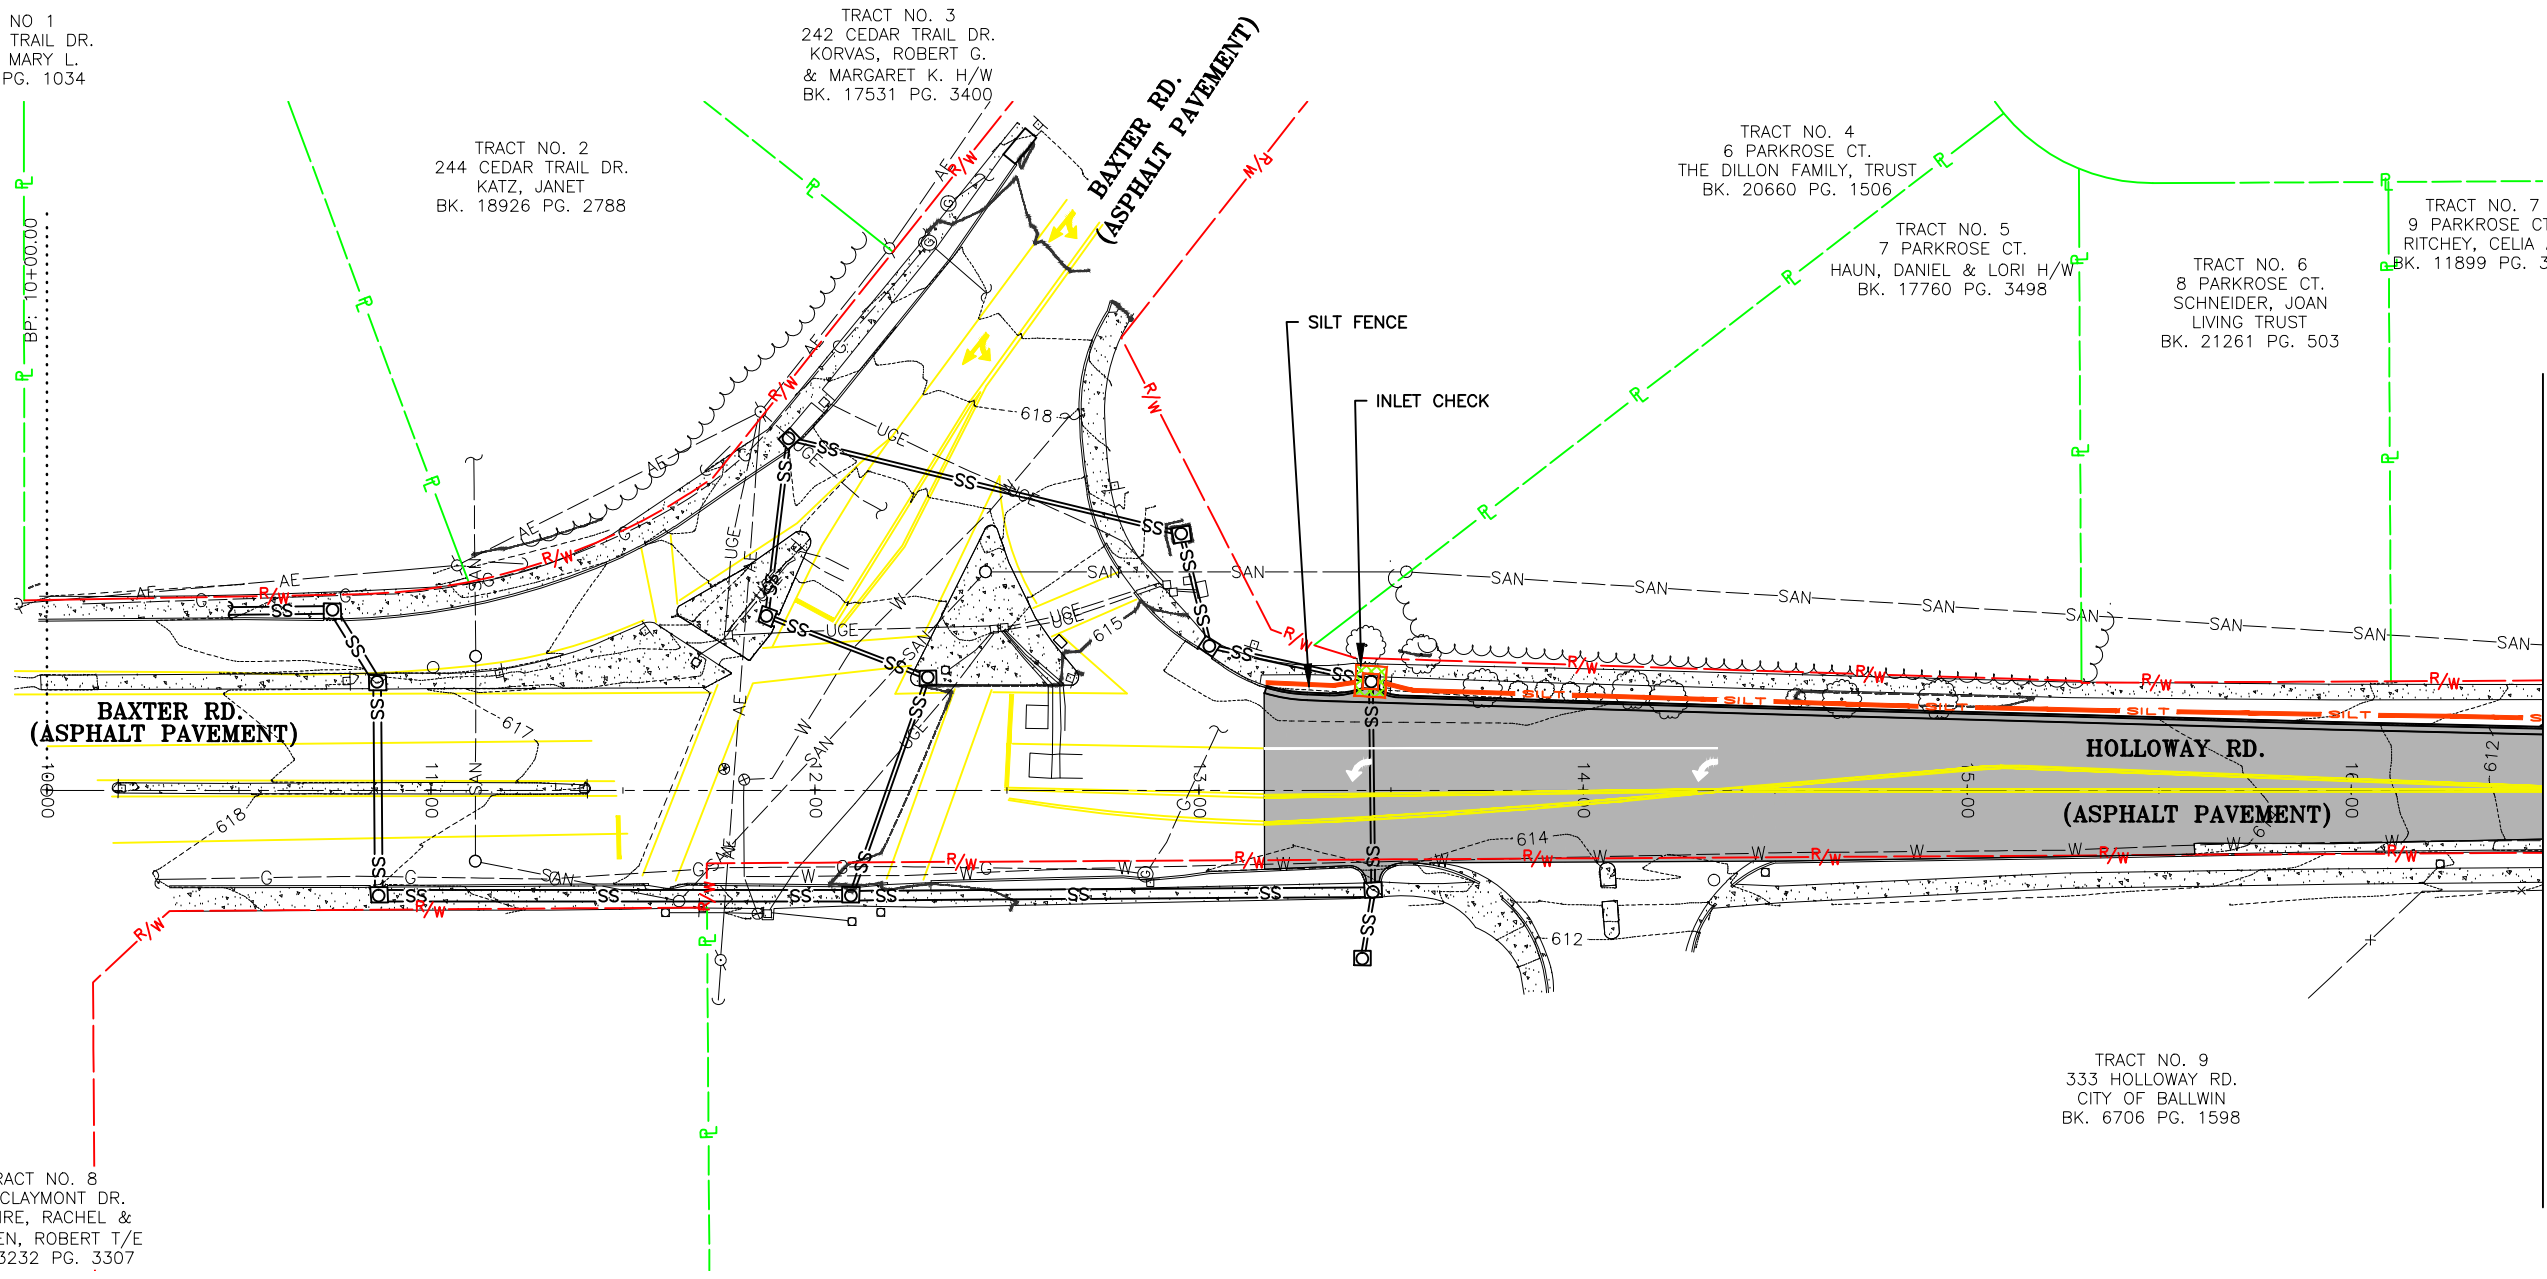

MATCH LINE STA. 16+50 SEE SHEET EC-2

Drawing name: I:\SC19-981 Holloway Road, Ballwin, MO\AUTOCAD DRAWINGS\EROSION CONTROL PLAN.dwg Tab: EC-1 Plotted on: Feb 09, 2021 - 10:32am Plotted by: kweliff

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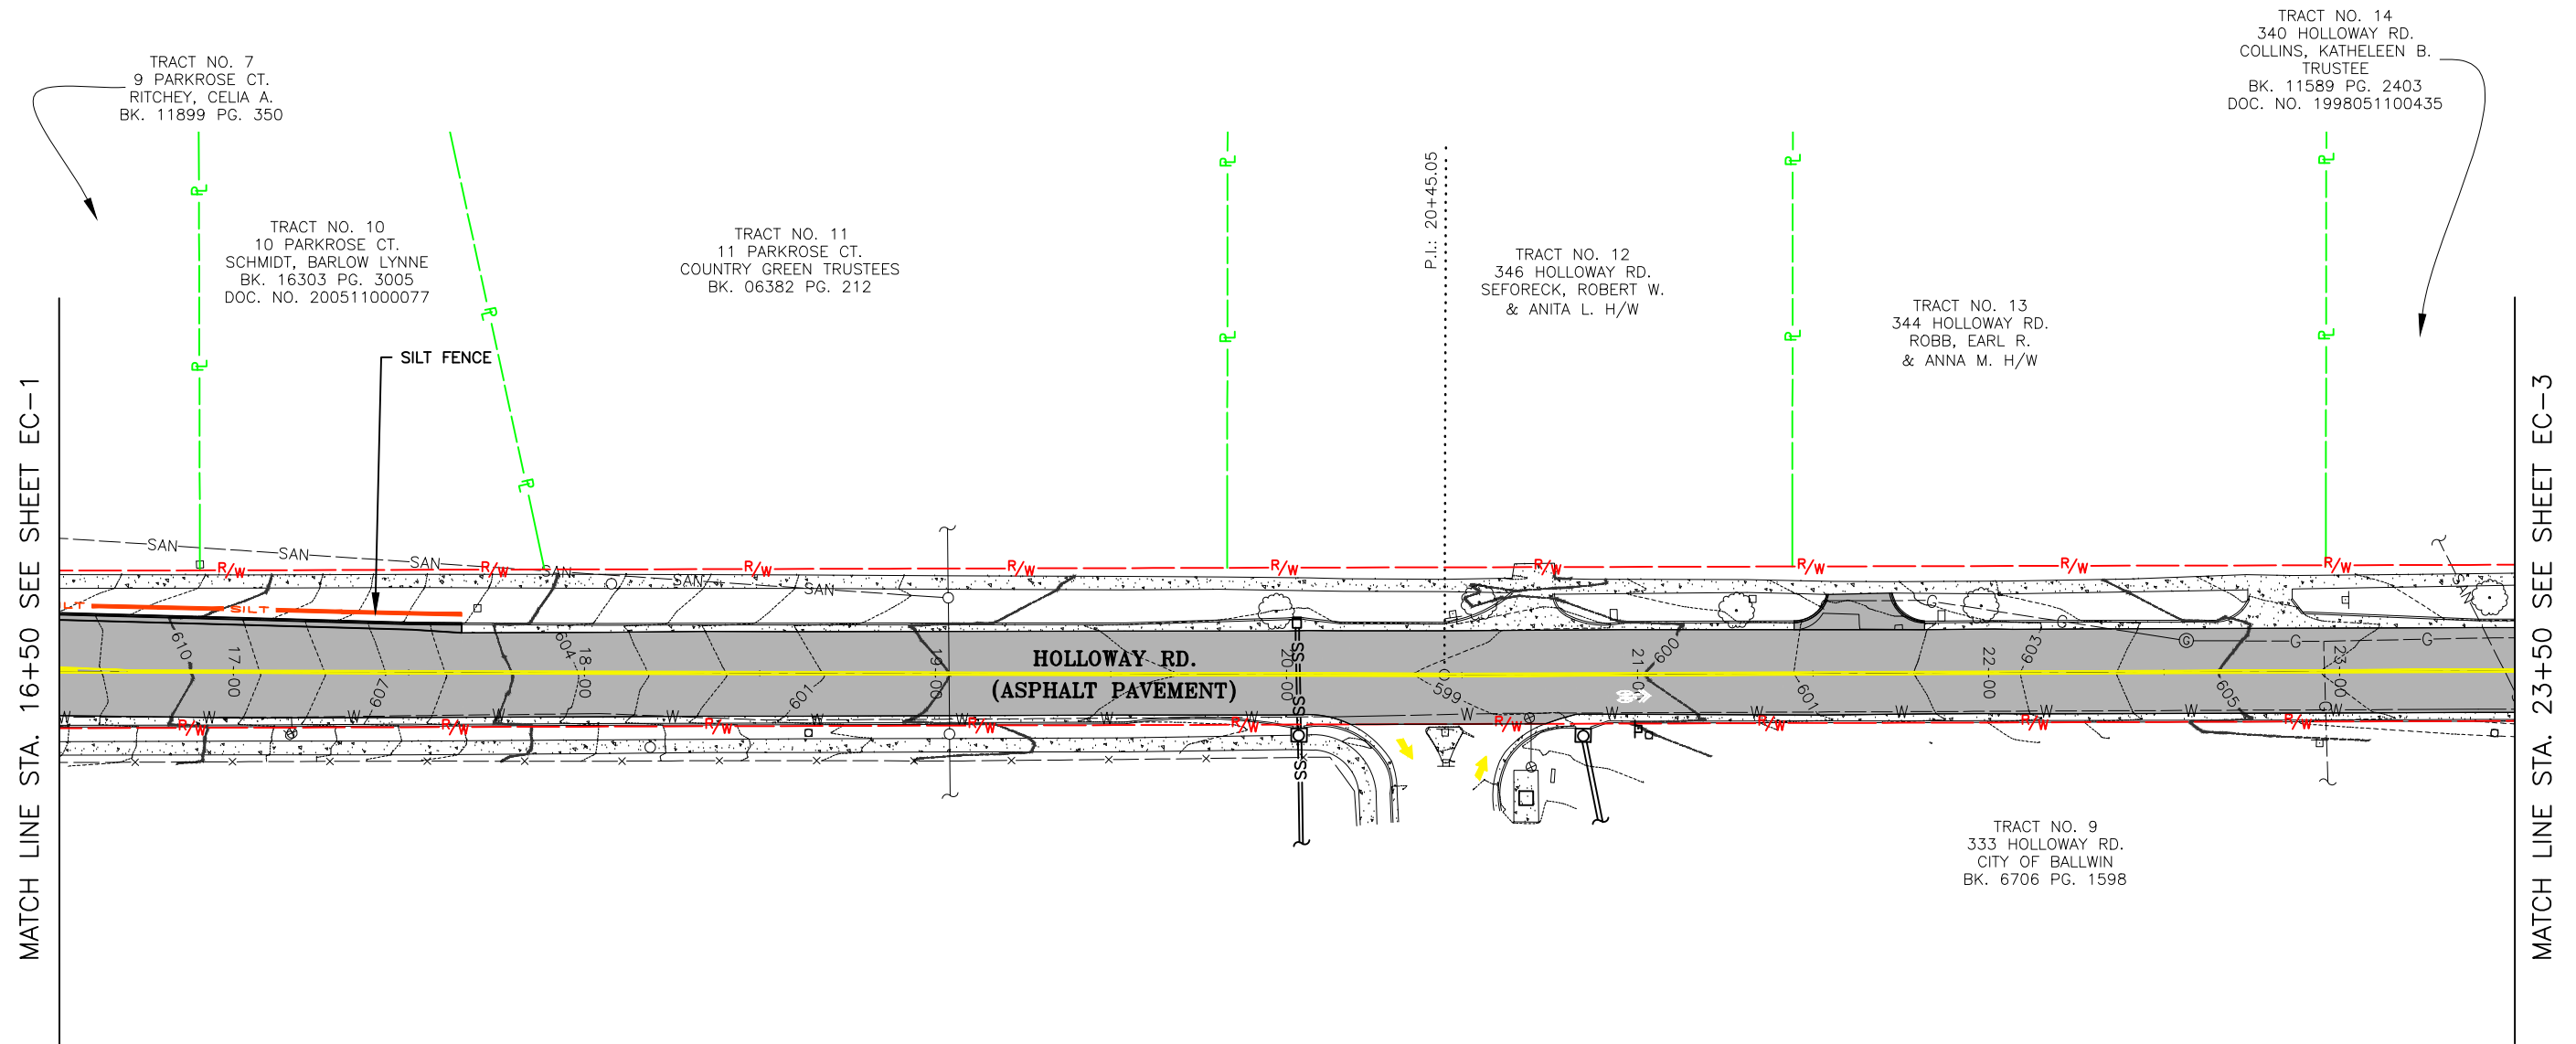
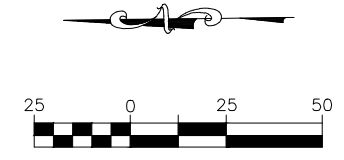
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HOLLOWAY ROAD IMPROVEMENTS
 FEDERAL PROJECT NO. STP-4939(608)
 CITY OF BALLWIN, MISSOURI

EROSION CONTROL PLAN	
DATE:	REVISION:
DWN BY:	APPD BY:
K.J.W.	M.D.S.
DATE:	JANUARY 2021
SCALE:	1" = 50'
PROJ. NO.:	SC19-981
DWG. NO.:	EC-1

EROSION CONTROL PLAN



Drawing name: I:\SC19-981 Holloway Road, Ballwin, MO\AUTOCAD DRAWINGS\EROSION CONTROL PLAN.dwg Tab: EC-2 Plotted on: Feb 09, 2021 - 10:32am Plotted by: kweliff

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STATE OF MISSOURI

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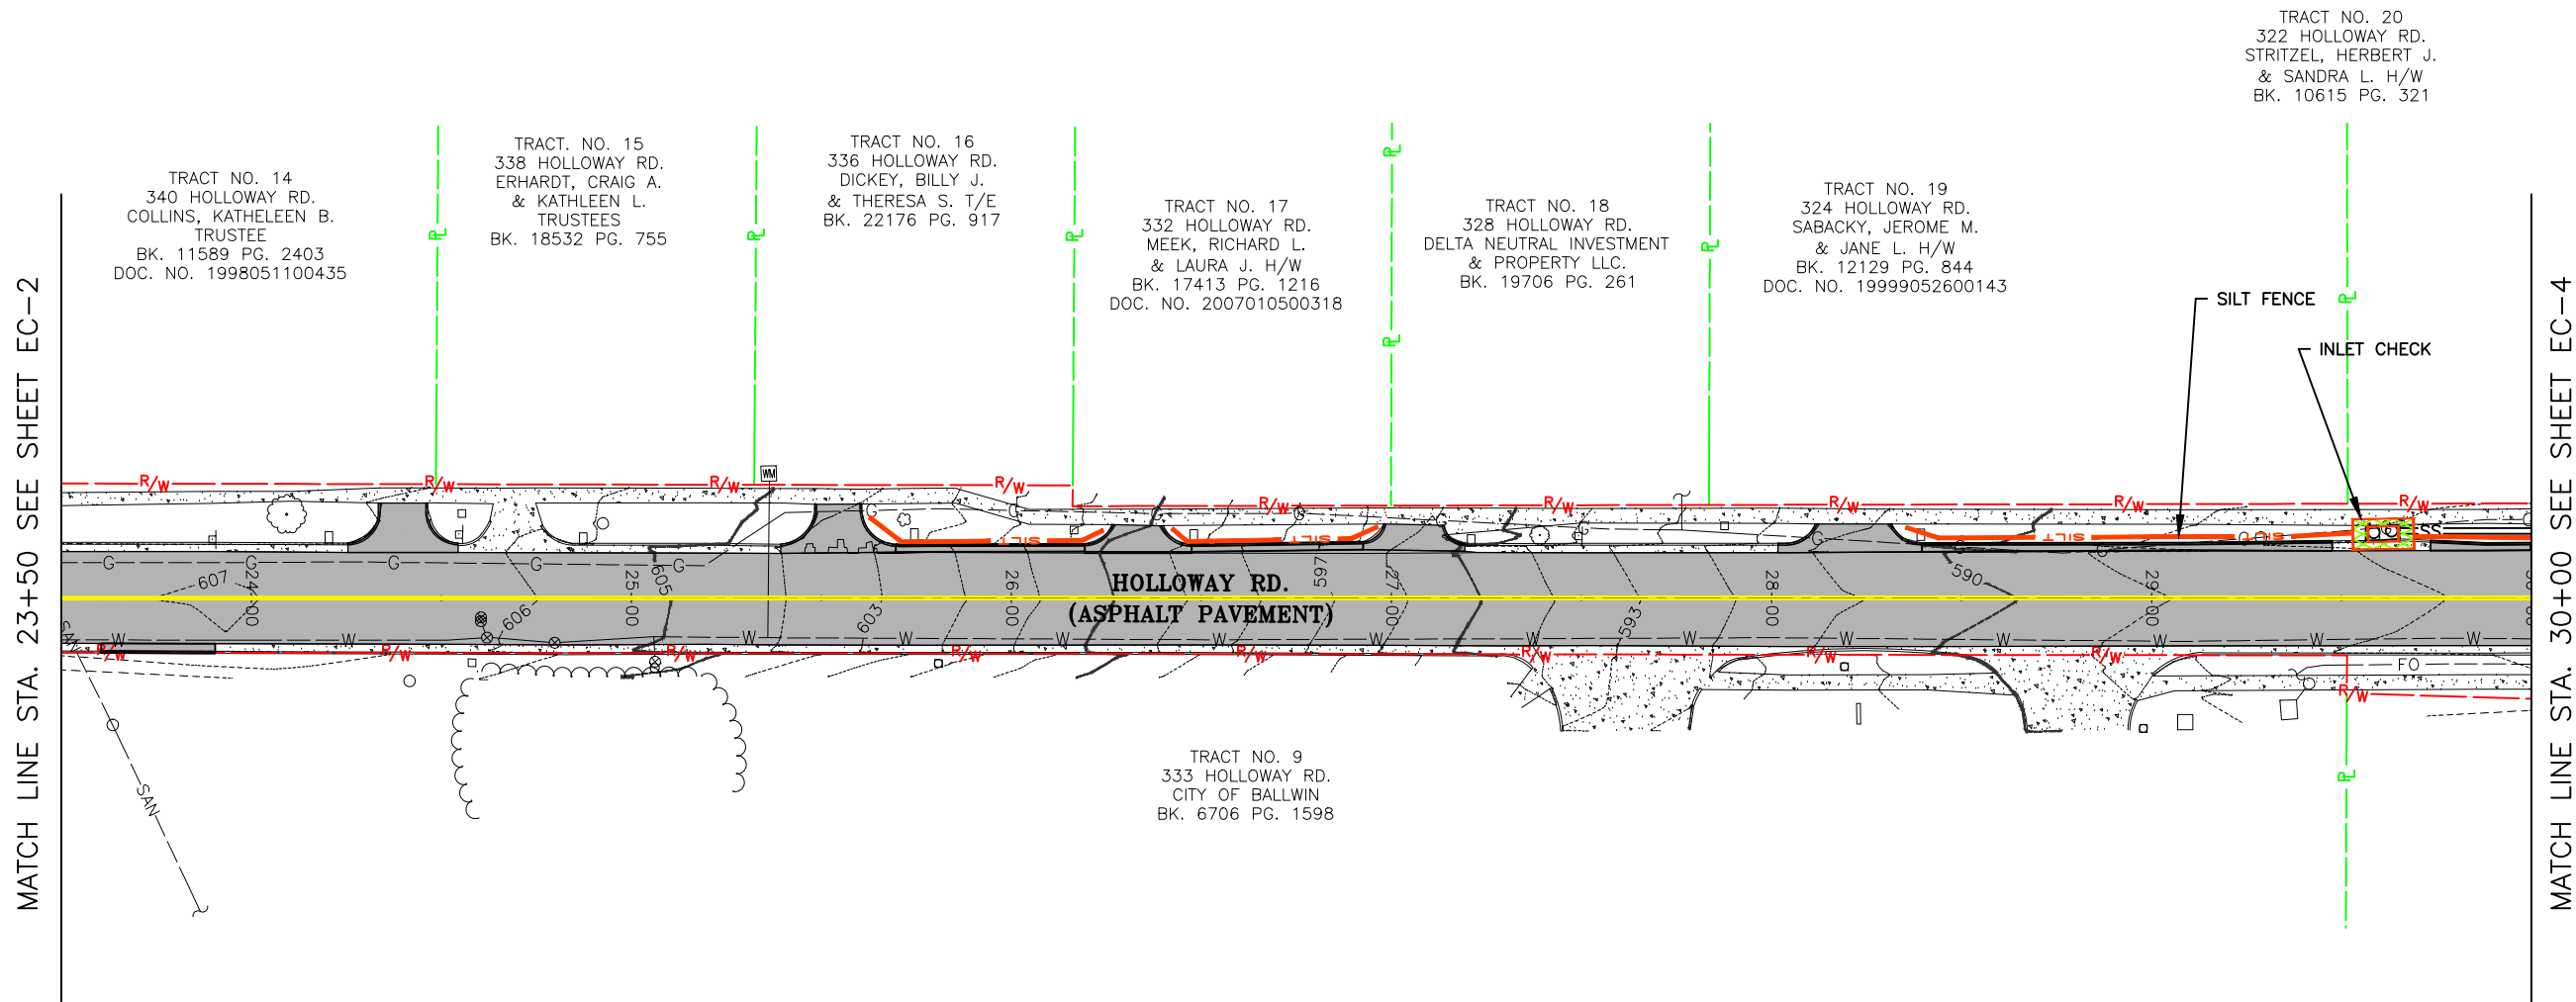
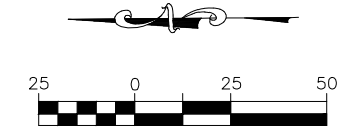
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HOLLOWAY ROAD IMPROVEMENTS
FEDERAL PROJECT NO. STP-4939(608)
CITY OF BALLWIN, MISSOURI

DATE	REVISION

DWN. BY: K.J.W.	APPD. BY: M.D.S.
DATE: JANUARY 2021	
SCALE: 1" = 50'	
PROJ. NO.: SC19-981	
DWG. NO.: EC-2	

EROSION CONTROL PLAN



Drawing name: U:\SC19-981 Holloway Road, Ballwin, MO\AUTOCAD DRAWINGS\EROSION CONTROL PLAN.dwg Tab: EC-3 Plotted on: Feb 09, 2021 - 10:32am Plotted by: kwelff

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KEVIN J. WOLFF
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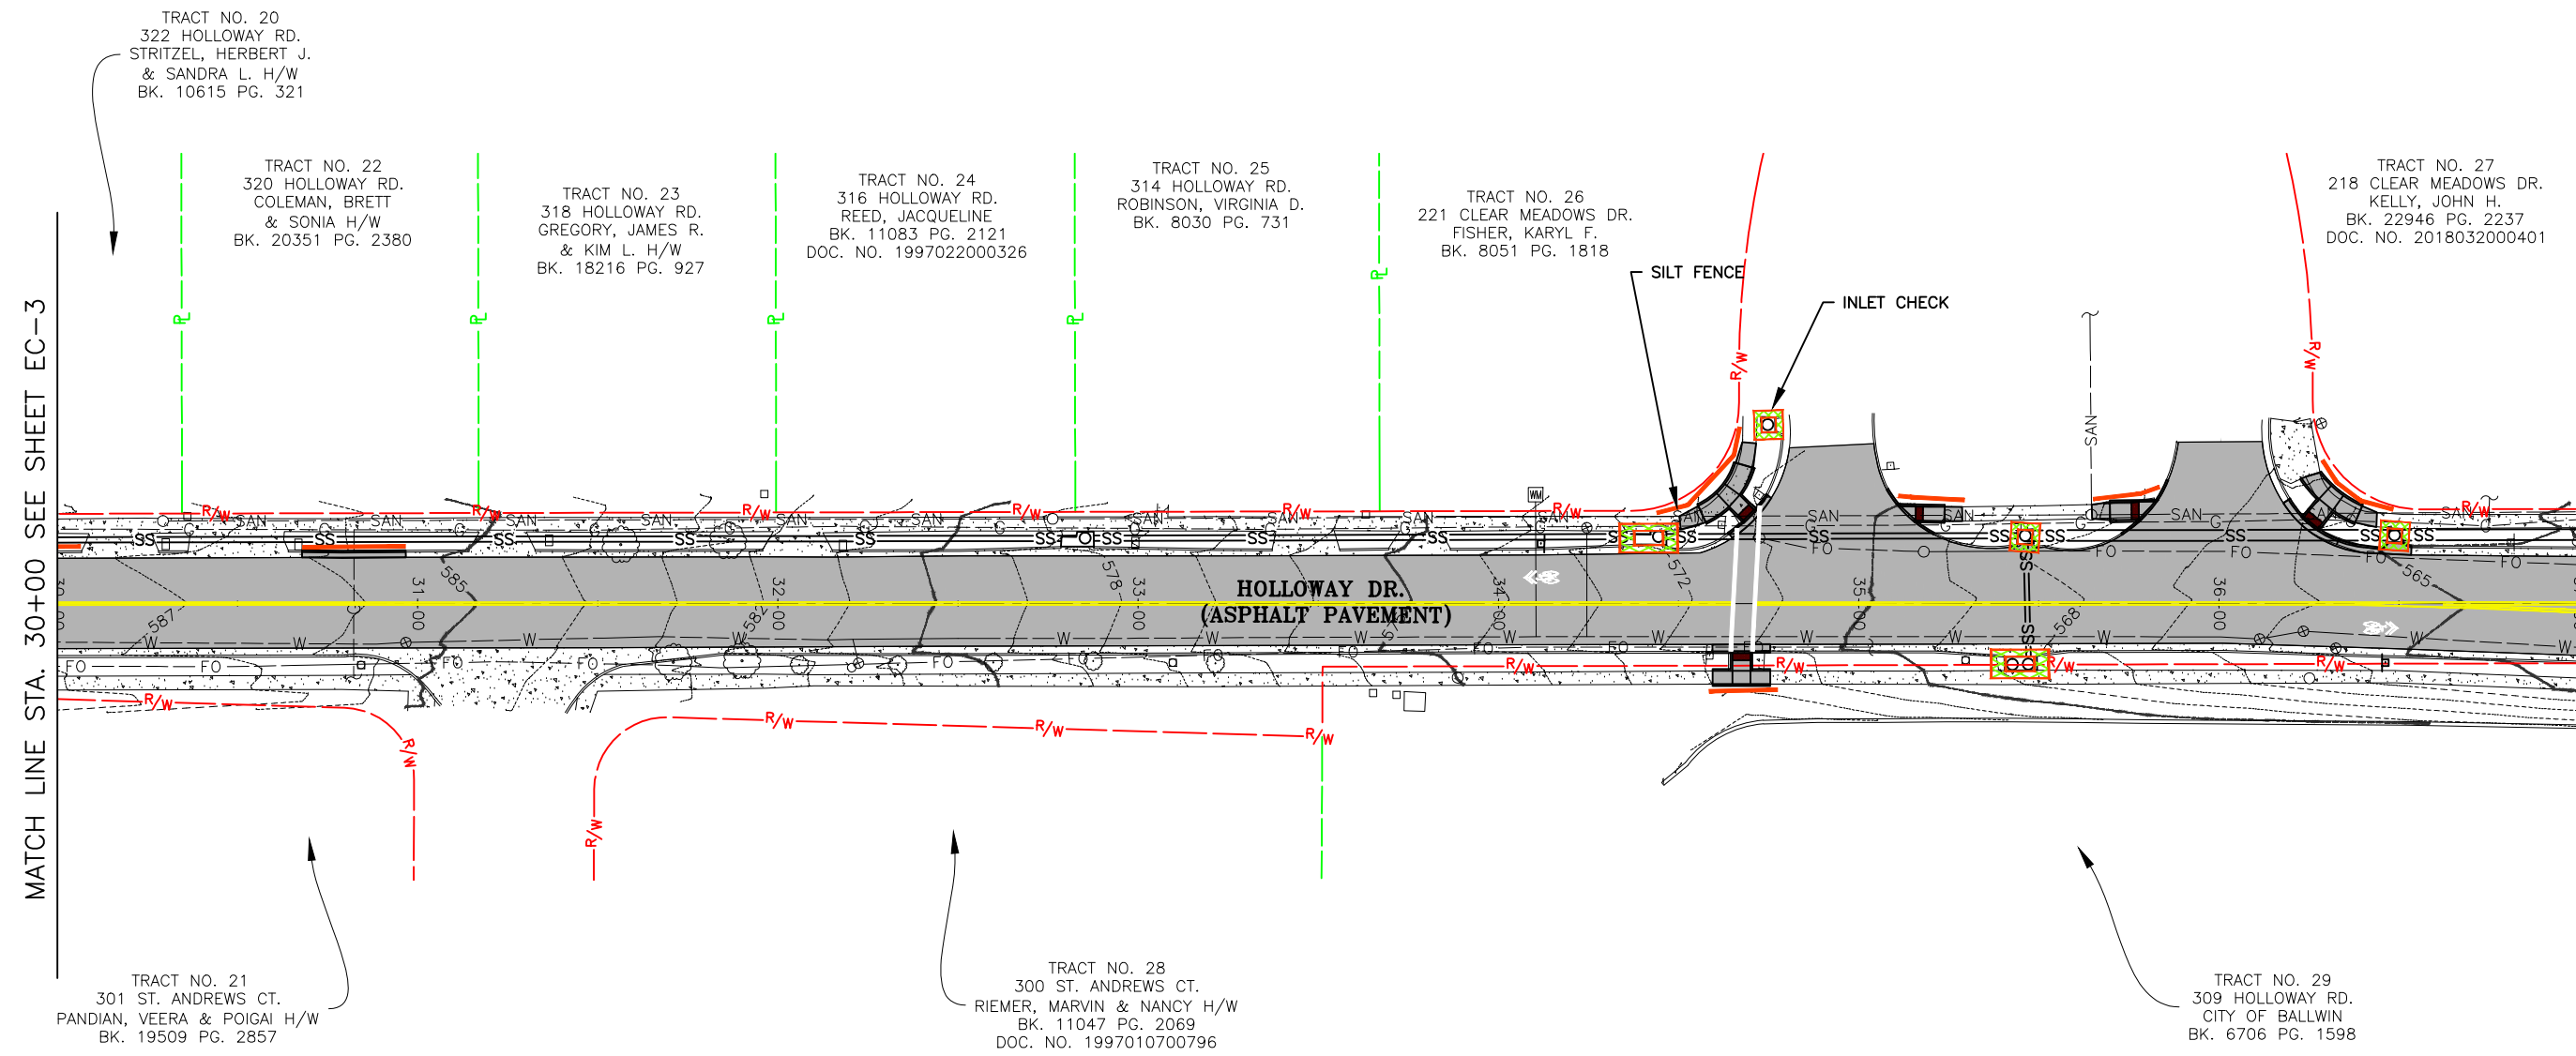
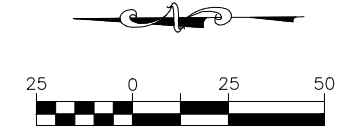
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HOLLOWAY ROAD IMPROVEMENTS
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CITY OF BALLWIN, MISSOURI

EROSION CONTROL PLAN	DATE	REVISION

DWN BY: K.J.W.	APPD BY: M.D.S.
DATE: JANUARY 2021	
SCALE: 1" = 50'	
PROJ. NO.: SC19-981	
DWG. NO.: EC-3	

EROSION CONTROL PLAN



MATCH LINE STA. 30+00 SEE SHEET EC-3

MATCH LINE STA. 37+00 SEE SHEET EC-5

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STATE OF MISSOURI

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CITY OF BALLWIN, MISSOURI

EROSION CONTROL PLAN	DATE	REVISION

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DATE: JANUARY 2021	
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DWG. NO.: EC-4	

Drawing name: I:\SC19-981 Holloway Road, Ballwin, MO\AUTOCAD DRAWINGS\EROSION CONTROL PLAN.dwg Tab: EC-4 Plotted on: Feb 09, 2021 - 10:32am Plotted by: kweliff

EROSION CONTROL PLAN

TRACT NO. 31
304 HOLLOWAY RD.
MURPHY, WILLIAM G. &
TURNER, HELEN H/W
BK. 14674 PG. 1852
DOC. NO. 2003031800355

TRACT NO. 32
302 HOLLOWAY RD.
SCHIECHTER, JAMES
& PATRICIA T/E
BK. 23144 PG. 2341
DOC. NO. 2018080800438



TRACT NO. 29
309 HOLLOWAY RD.
CITY OF BALLWIN
BK. 6706 PG. 1598

TRACT NO. 29
309 HOLLOWAY RD.
CITY OF BALLWIN
BK. 6706 PG. 1598

TRACT NO. 33
221 BLUE SAGE CT.
MIMG XCII SEVEN TRAILS LLC.
BK. 22652 PG.1507
DOC. NO. 2017081500432

50' TRACT OF LAND
CONVEYED TO CITY
OF BALLWIN
BK. 6480, PG. 987

TRACT NO. 29
309 HOLLOWAY RD.
CITY OF BALLWIN
BK. 6706 PG. 1598

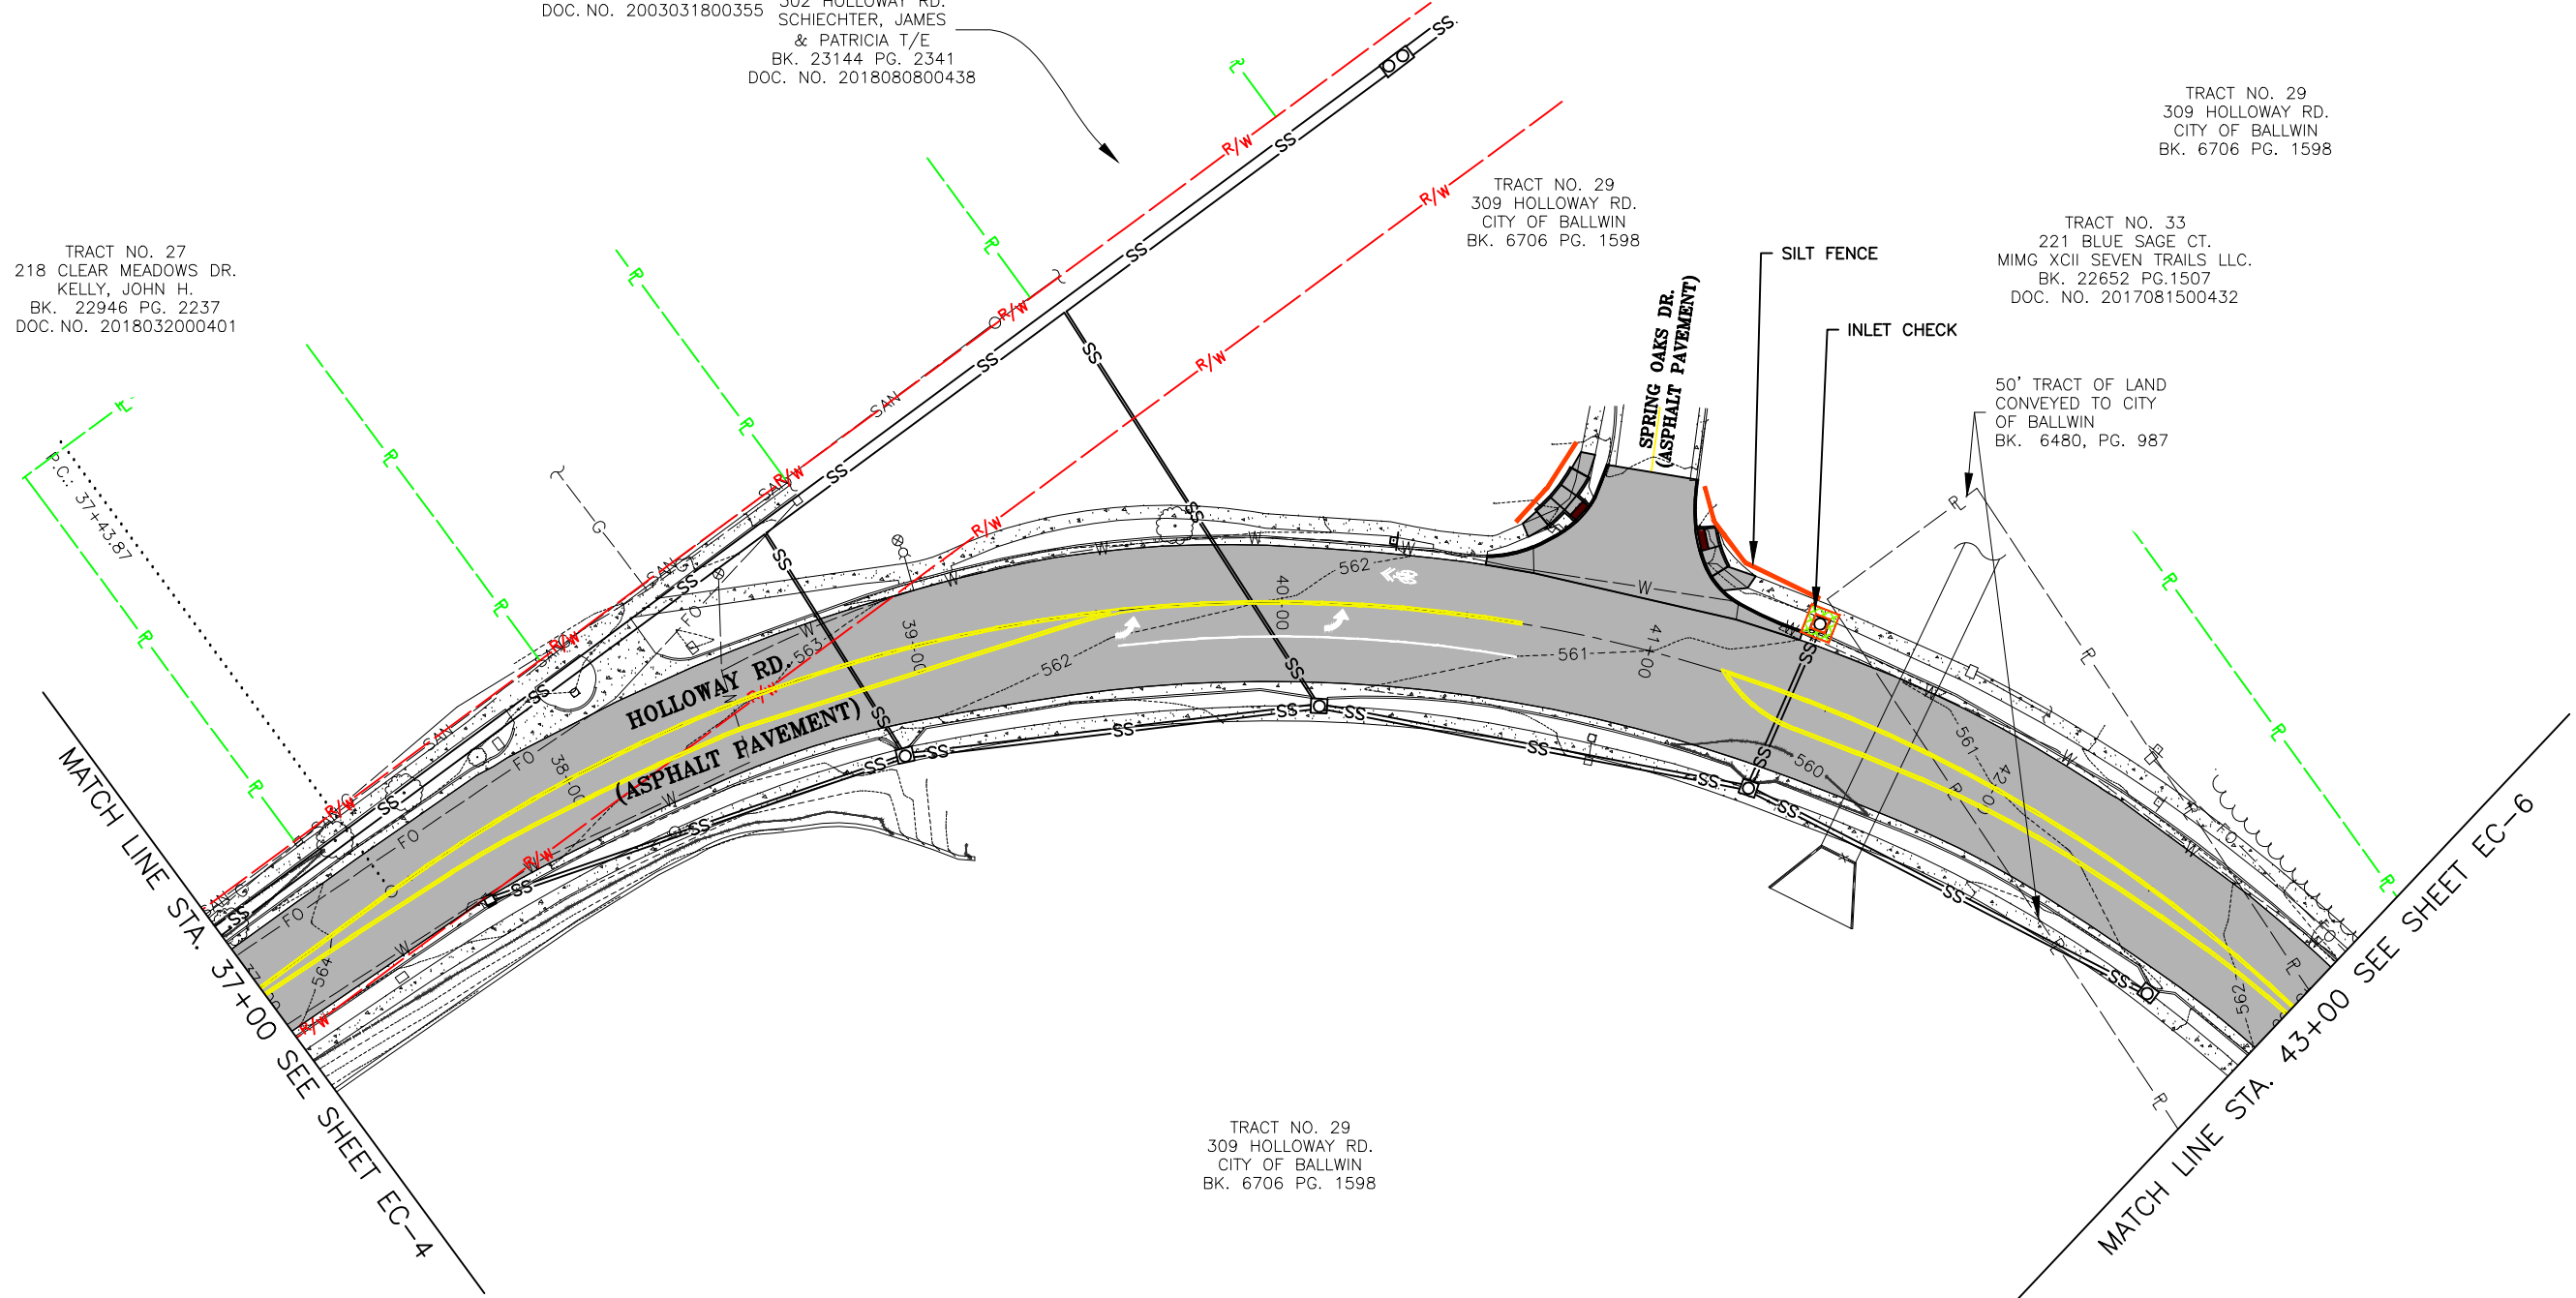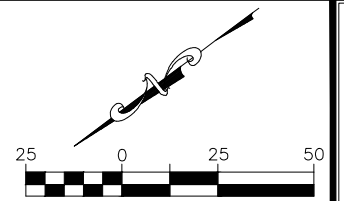

TRACT NO. 27
218 CLEAR MEADOWS DR.
KELLY, JOHN H.
BK. 22946 PG. 2237
DOC. NO. 2018032000401

MATCH LINE STA. 37+00 SEE SHEET EC-4

MATCH LINE STA. 43+00 SEE SHEET EC-6

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LAND SURVEYING CERTIFICATE OF AUTHORITY NUMBER - 20070704529

1/28/21
KEVIN J. WOLFF
NO. PE-200400889
STATE OF MISSOURI
REGISTERED PROFESSIONAL ENGINEER
FOR SC ENGINEERING LLC,
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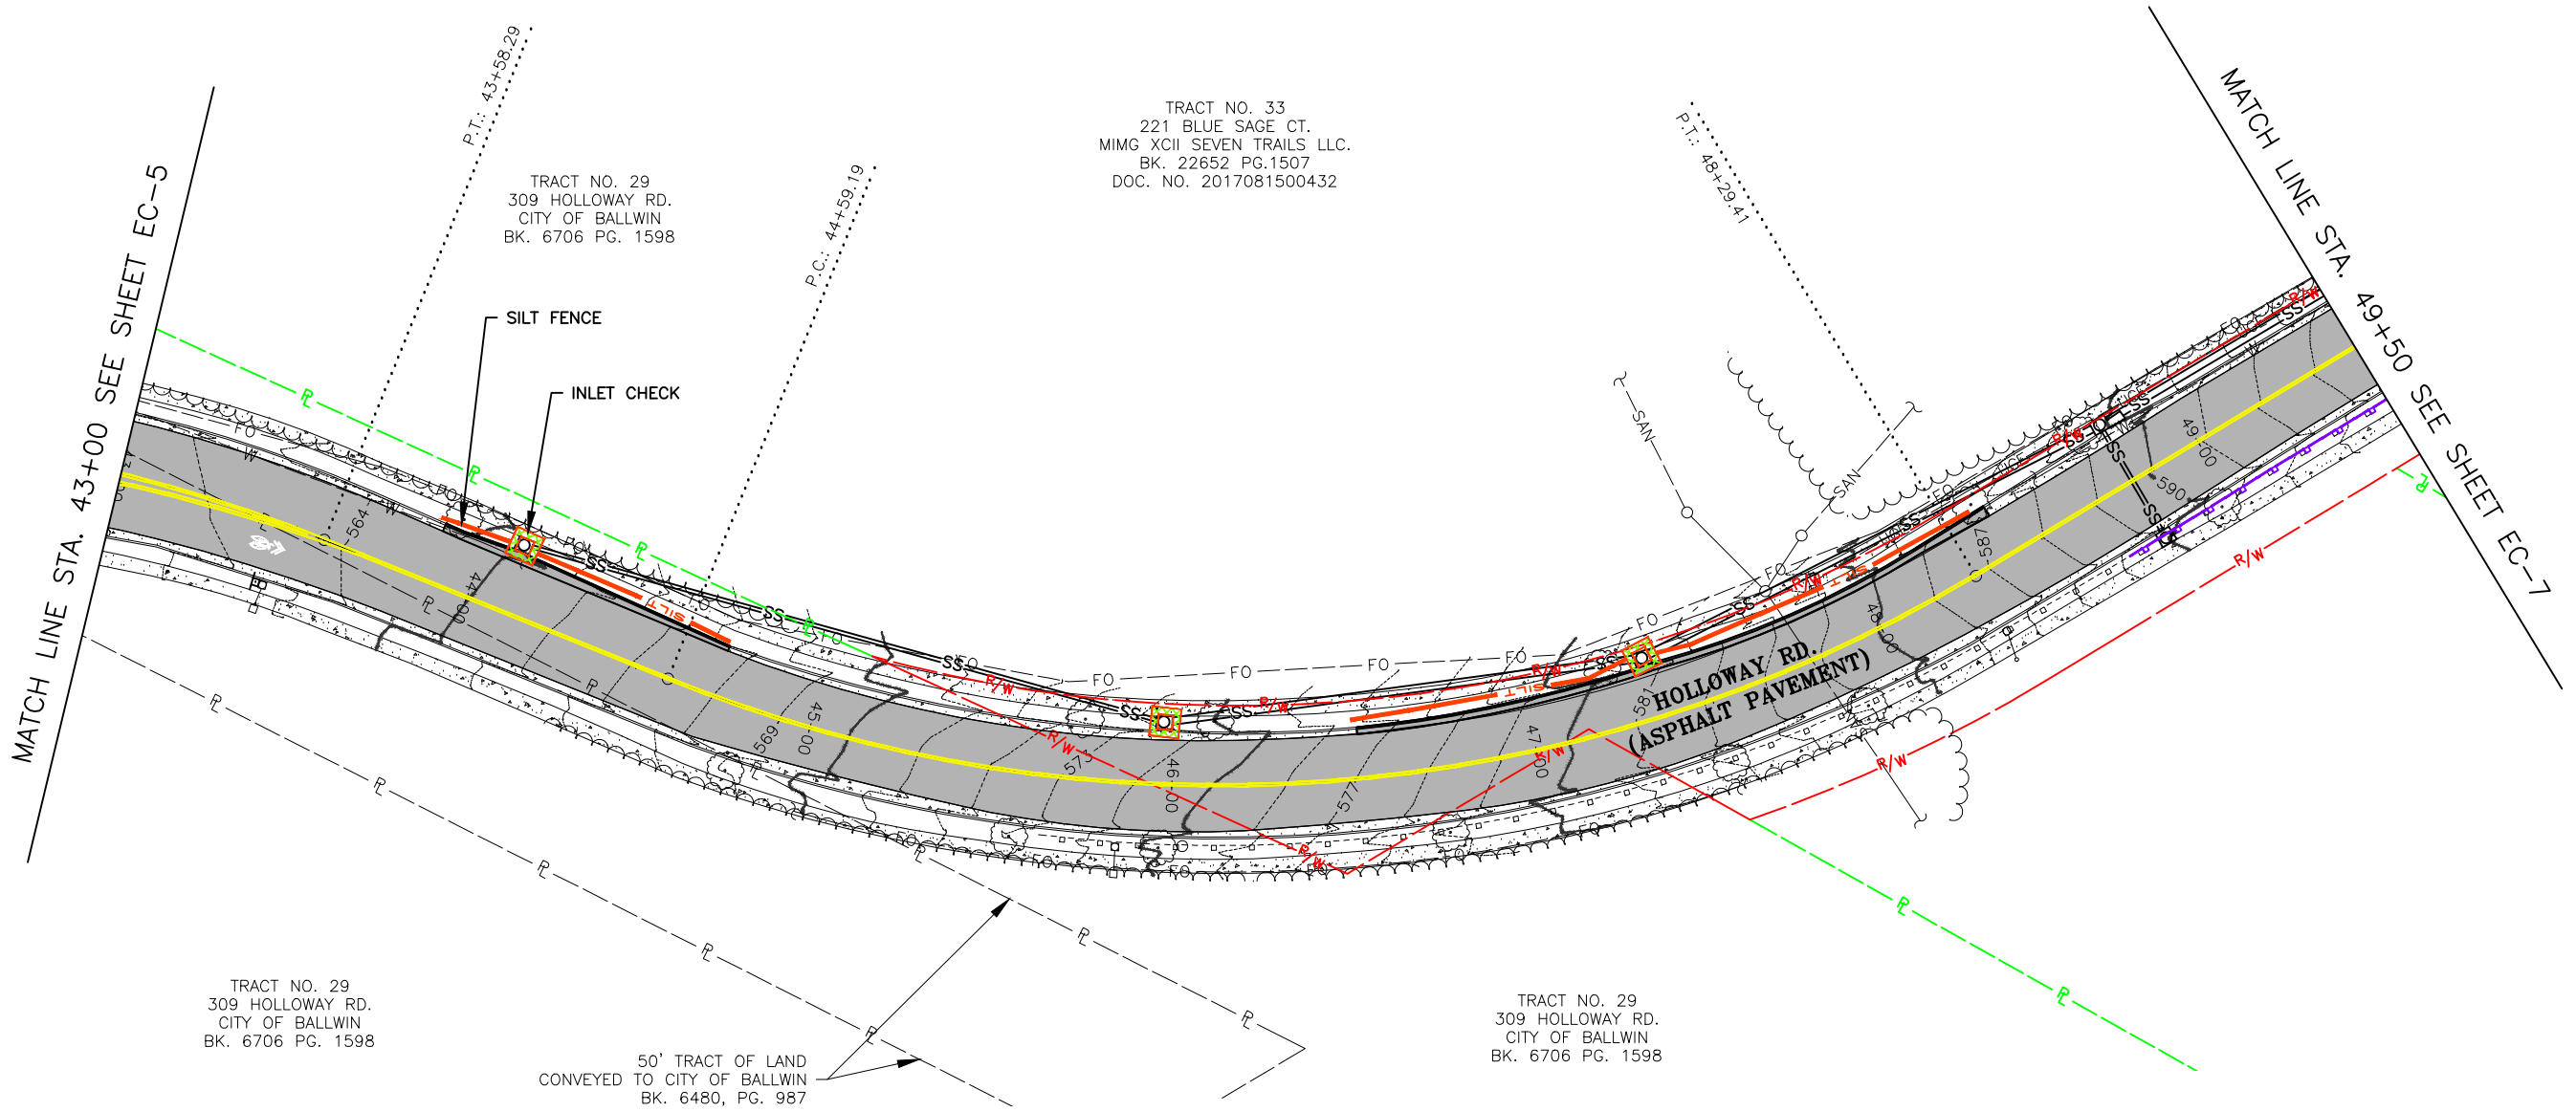
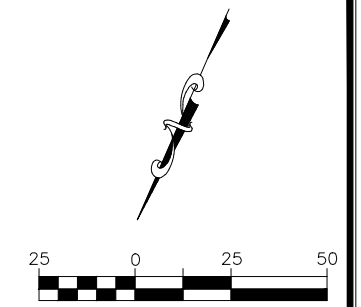
HOLLOWAY ROAD IMPROVEMENTS
FEDERAL PROJECT NO. STP-4939(608)
CITY OF BALLWIN, MISSOURI

DATE	REVISION

DWN. BY:	APPD. BY:
K.J.W.	M.D.S.
DATE:	JANUARY 2021
SCALE:	1" = 50'
PROJ. NO.:	SC19-981
DWG. NO.:	EC-5

Drawing name: U:\SC19-981 Holloway Road, Ballwin, MO\AUTOCAD DRAWINGS\EROSION CONTROL PLAN.dwg Tab: EC-5 Plotted on: Feb 09, 2021 - 10:32am Plotted by: kweliff

EROSION CONTROL PLAN



TRACT NO. 33
 221 BLUE SAGE CT.
 MIMG XCII SEVEN TRAILS LLC.
 BK. 22652 PG.1507
 DOC. NO. 2017081500432

TRACT NO. 29
 309 HOLLOWAY RD.
 CITY OF BALLWIN
 BK. 6706 PG. 1598

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 CITY OF BALLWIN
 BK. 6706 PG. 1598

50' TRACT OF LAND
 CONVEYED
 TO CITY OF BALLWIN
 BK. 6480, PG. 987

TRACT NO. 29
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 BK. 6706 PG. 1598

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 LAND SURVEYING CERTIFICATE OF AUTHORITY NUMBER - 2007004529

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 FENTON, MISSOURI 65026

STATE OF MISSOURI

KEVIN J. WOLFF P.E.

1/28/21

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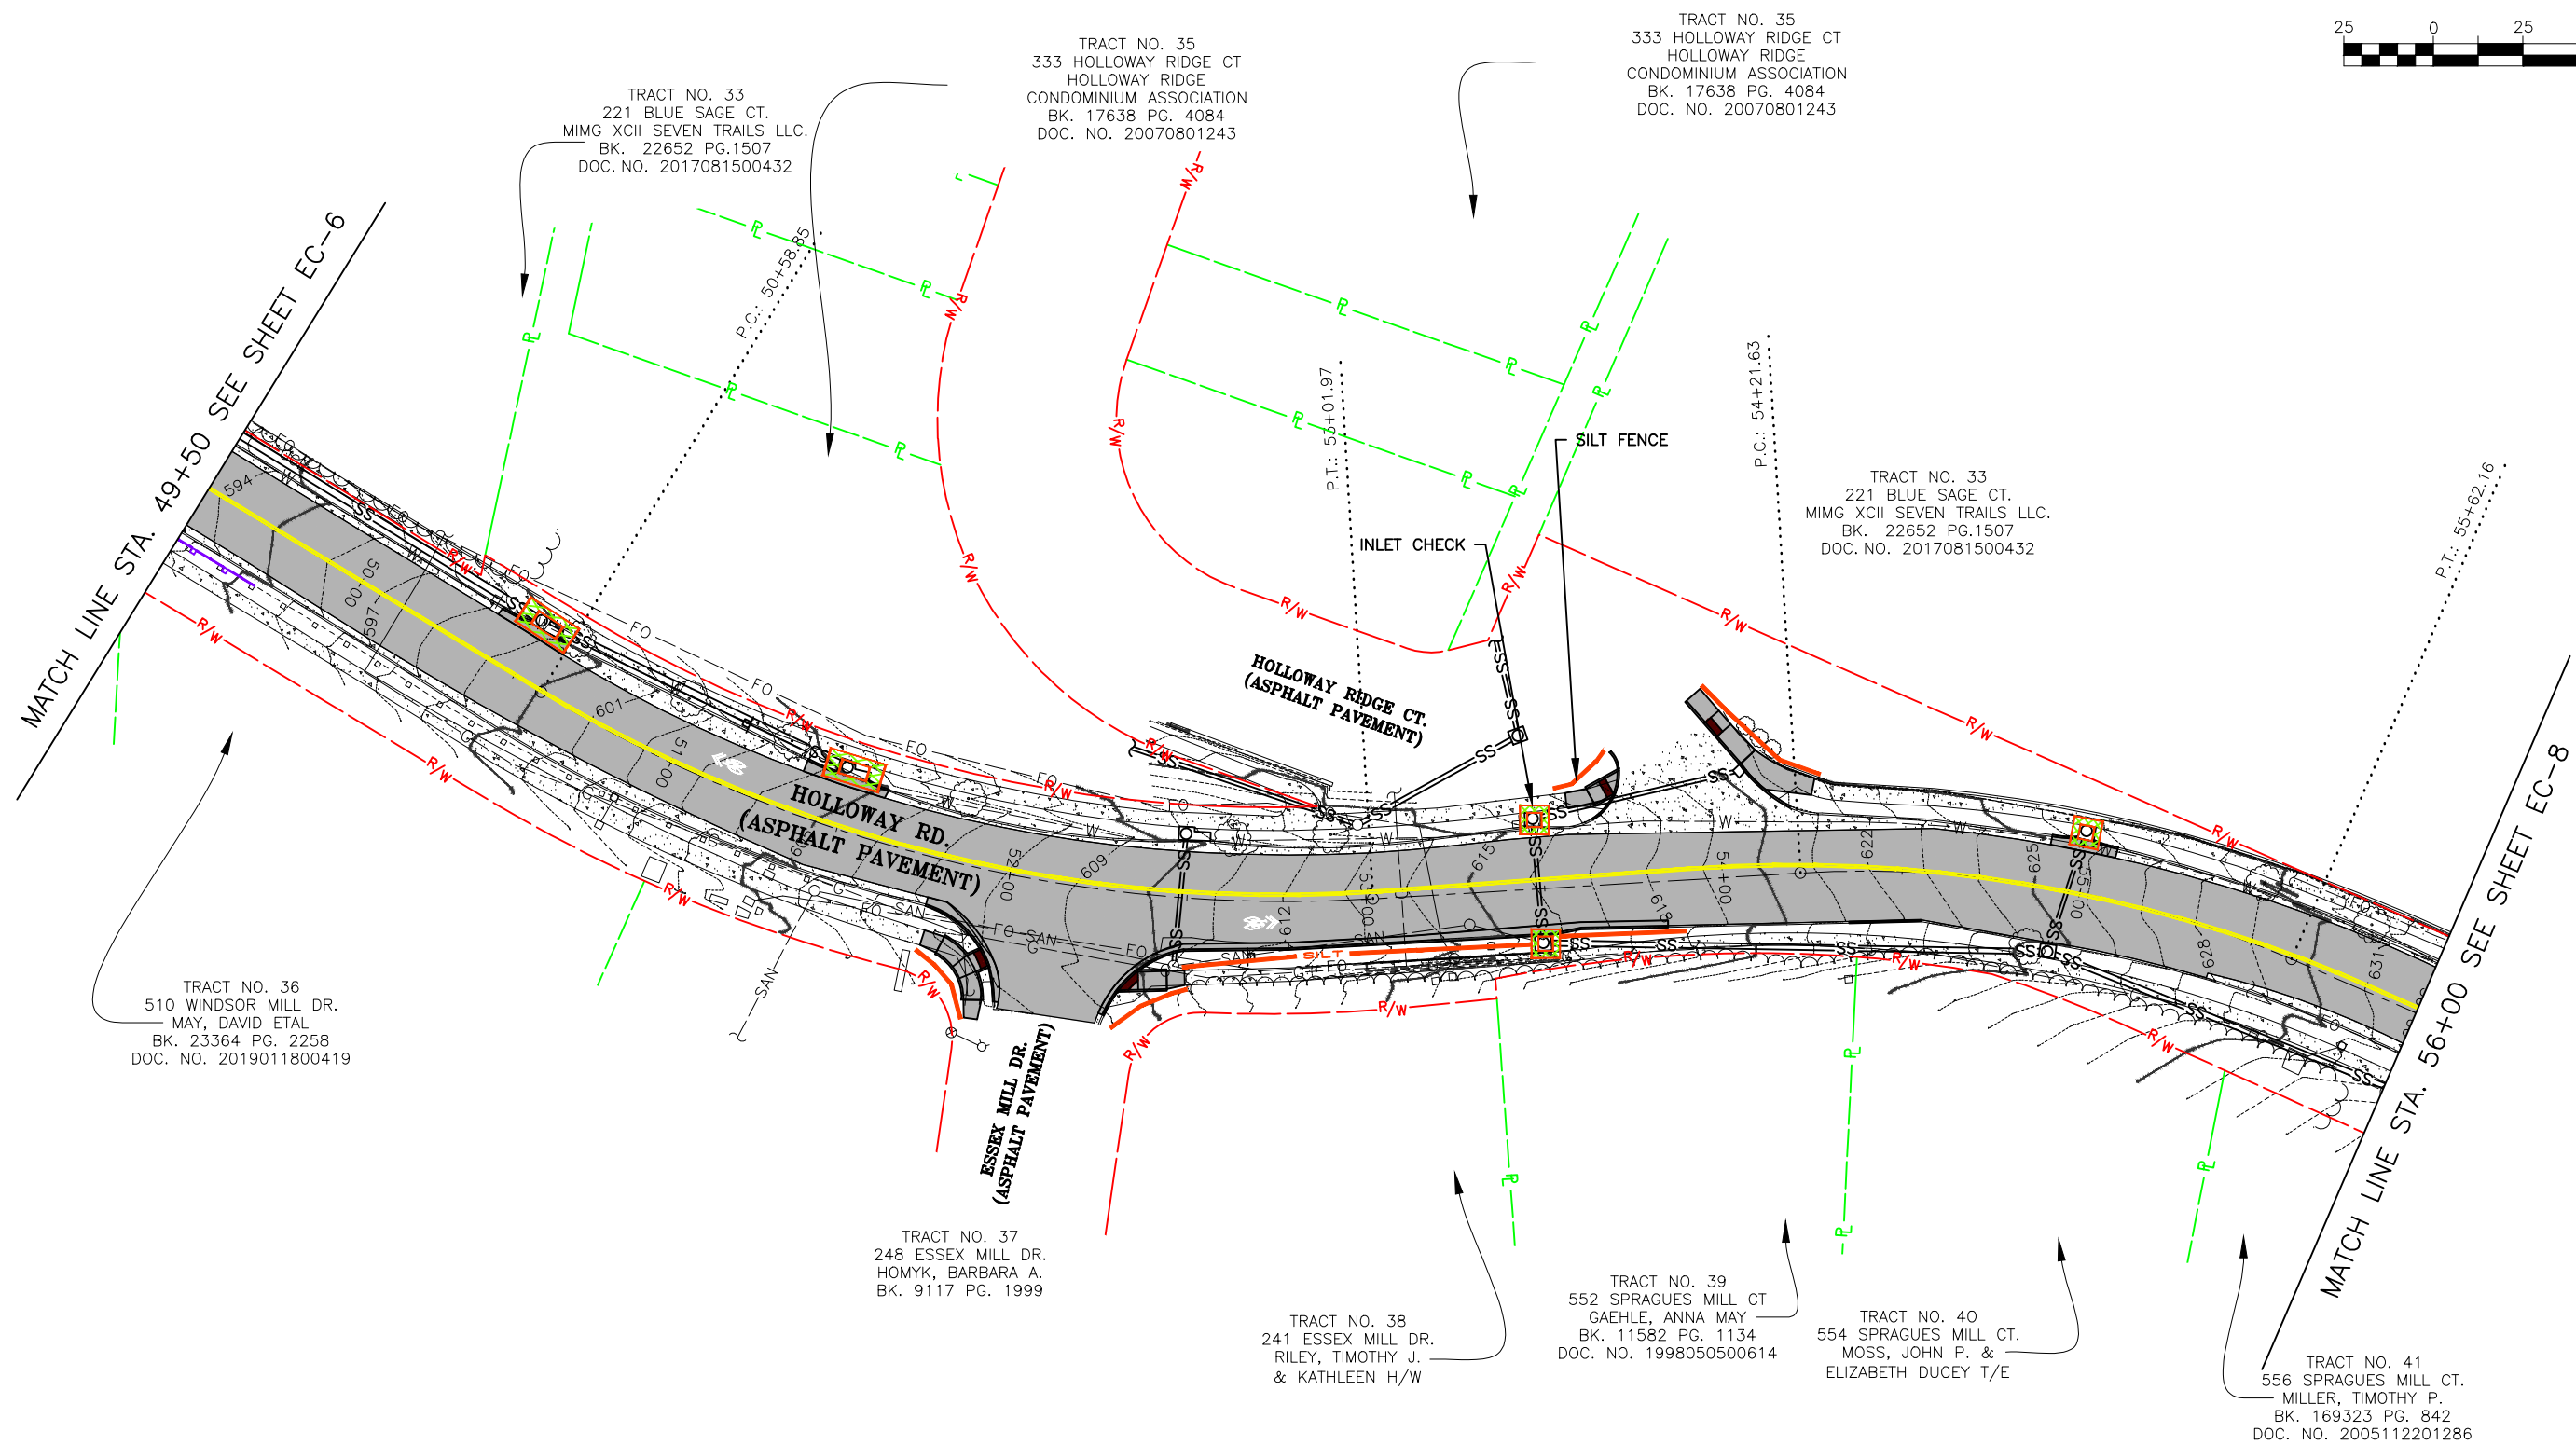
HOLLOWAY ROAD IMPROVEMENTS
FEDERAL PROJECT NO. STP-4939(608)
CITY OF BALLWIN, MISSOURI

EROSION CONTROL PLAN	
DATE	REVISION

DWN. BY:	APPD. BY:
K.J.W.	M.D.S.
DATE:	DATE:
JANUARY 2021	
SCALE:	
1" = 50'	
PROJ. NO.:	
SC19-981	
DWG. NO.:	
EC-6	

Drawing name: J:\SC19-981 Holloway Road, Ballwin, MO\AUTOCAD DRAWINGS\EROSION CONTROL PLAN.dwg Tab: EC-6 Plotted on: Feb 09, 2021 - 10:32am Plotted by: kwelff

EROSION CONTROL PLAN



TRACT NO. 33
221 BLUE SAGE CT.
MIMG XCII SEVEN TRAILS LLC.
BK. 22652 PG.1507
DOC. NO. 2017081500432

TRACT NO. 35
333 HOLLOWAY RIDGE CT
HOLLOWAY RIDGE
CONDOMINIUM ASSOCIATION
BK. 17638 PG. 4084
DOC. NO. 20070801243

TRACT NO. 35
333 HOLLOWAY RIDGE CT
HOLLOWAY RIDGE
CONDOMINIUM ASSOCIATION
BK. 17638 PG. 4084
DOC. NO. 20070801243

TRACT NO. 33
221 BLUE SAGE CT.
MIMG XCII SEVEN TRAILS LLC.
BK. 22652 PG.1507
DOC. NO. 2017081500432

TRACT NO. 36
510 WINDSOR MILL DR.
MAY, DAVID ETAL
BK. 23364 PG. 2258
DOC. NO. 2019011800419

TRACT NO. 37
248 ESSEX MILL DR.
HOMYK, BARBARA A.
BK. 9117 PG. 1999

TRACT NO. 38
241 ESSEX MILL DR.
RILEY, TIMOTHY J.
& KATHLEEN H/W

TRACT NO. 39
552 SPRAGUES MILL CT
GAEHLE, ANNA MAY
BK. 11582 PG. 1134
DOC. NO. 1998050500614

TRACT NO. 40
554 SPRAGUES MILL CT.
MOSS, JOHN P. &
ELIZABETH DUCEY T/E

TRACT NO. 41
556 SPRAGUES MILL CT.
MILLER, TIMOTHY P.
BK. 169323 PG. 842
DOC. NO. 2005112201286

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LAND SURVEYING CERTIFICATE OF AUTHORITY NUMBER - 2007004529

STATE OF MISSOURI

KEVIN J. WOLFF P.E.
Professional Engineer

1/28/21

KEVIN J. WOLFF
NO. PE-200400899
STATE OF MISSOURI
REGISTERED PROFESSIONAL ENGINEER
FOR SC ENGINEERING LLC,
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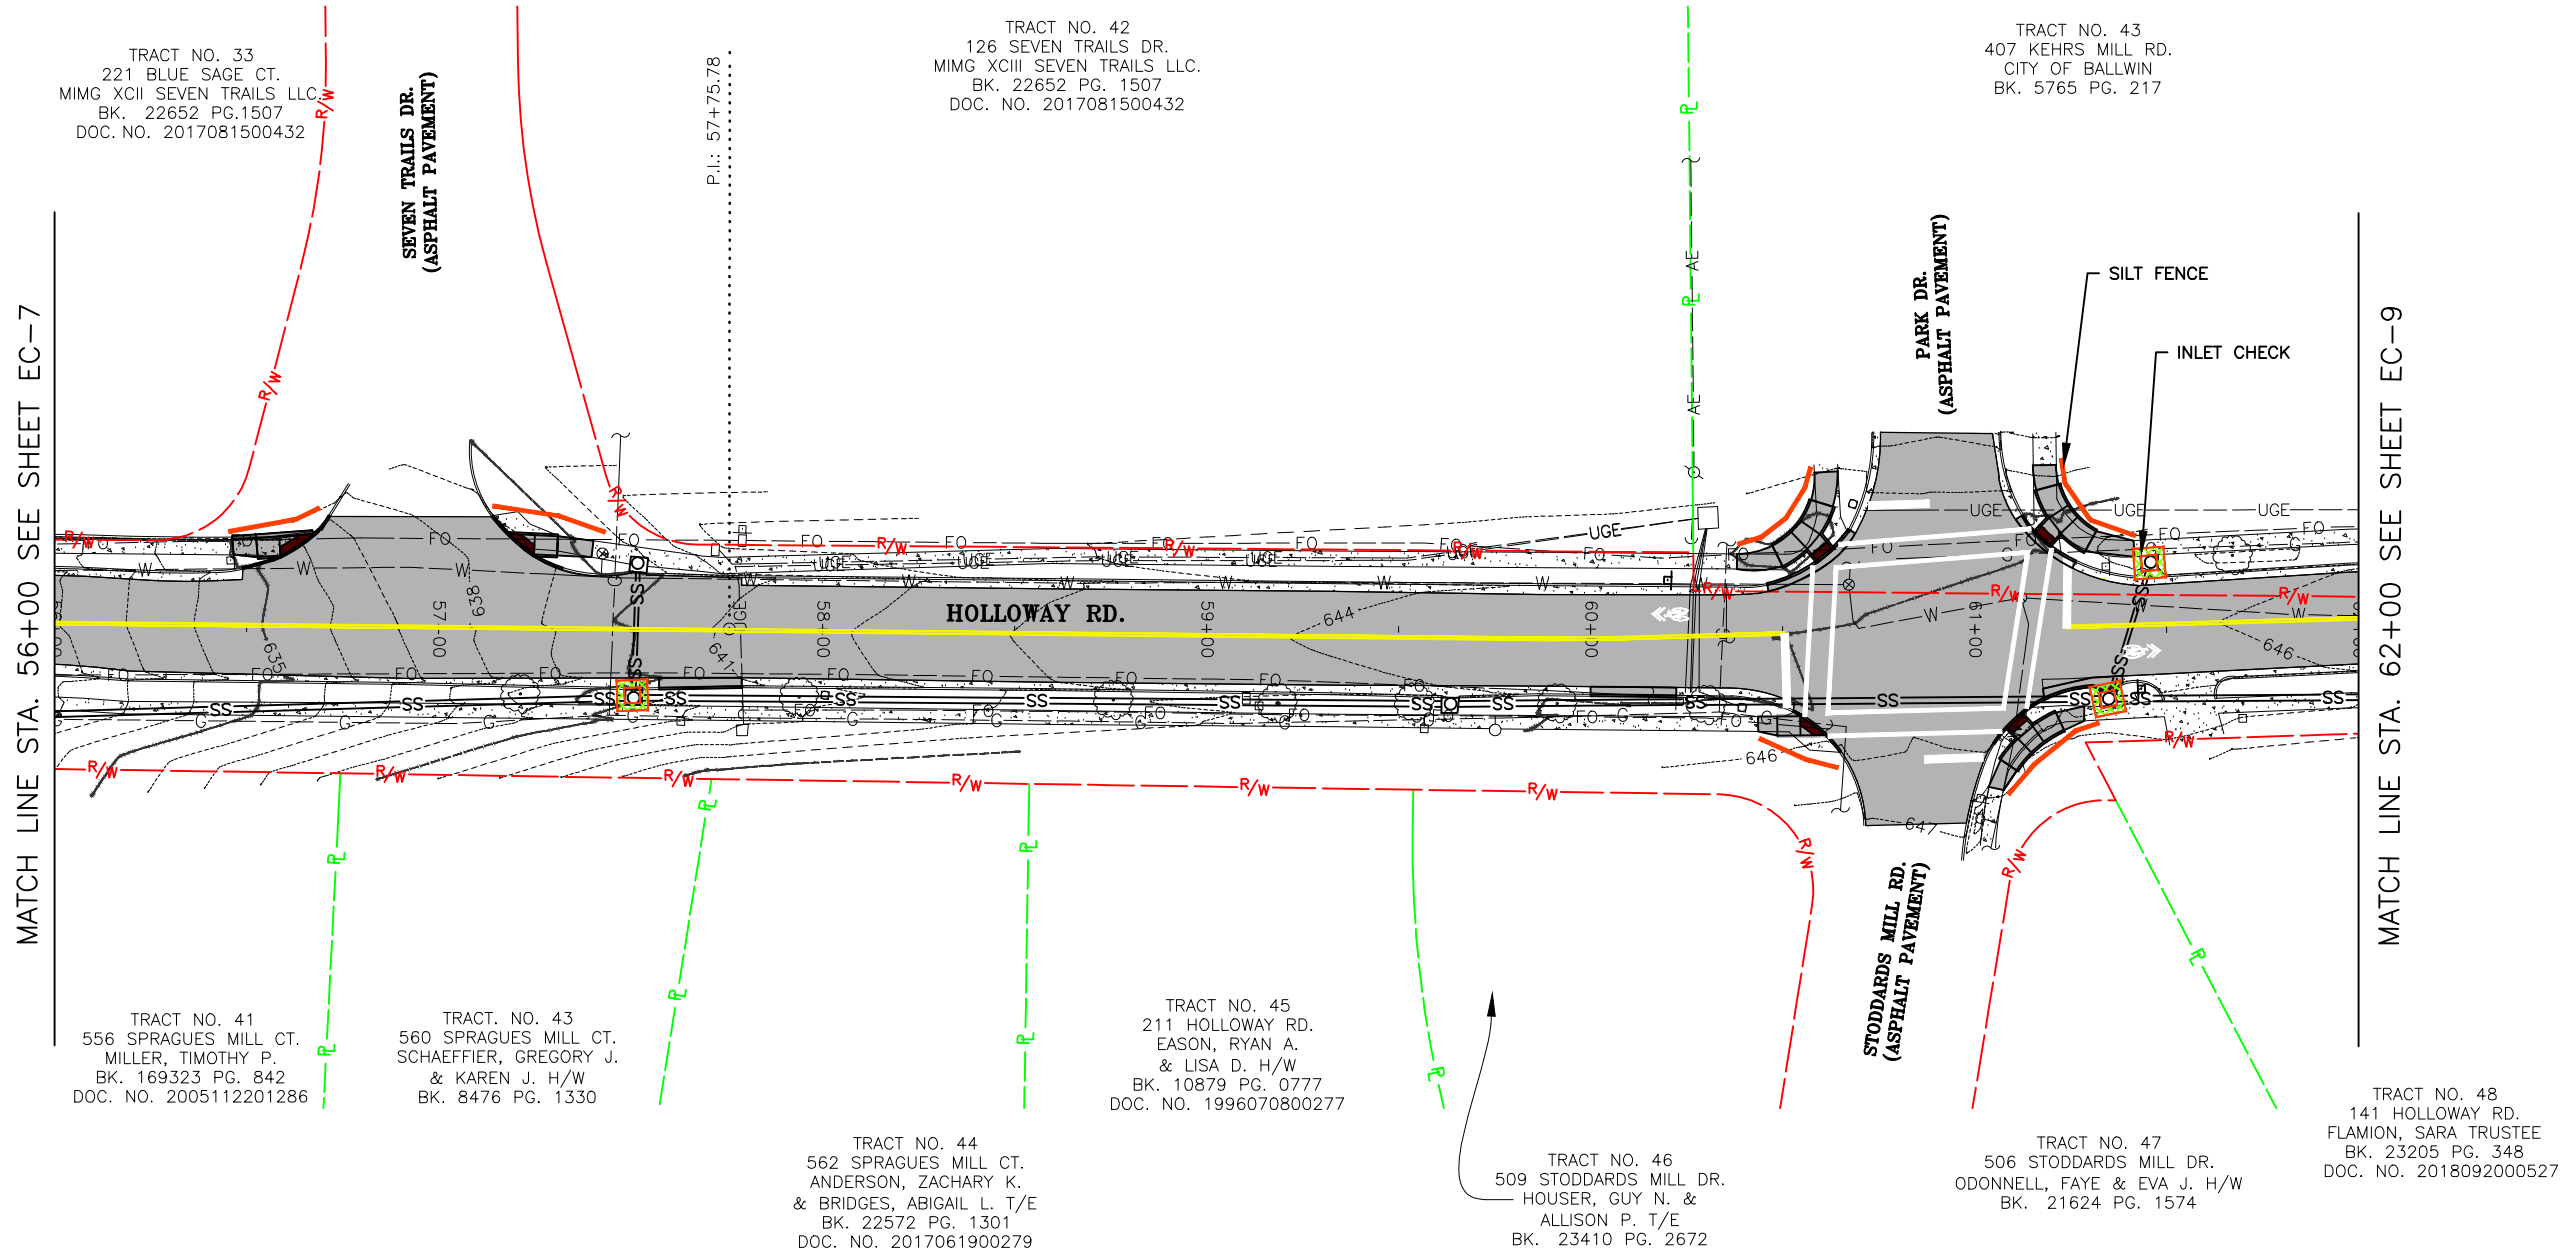
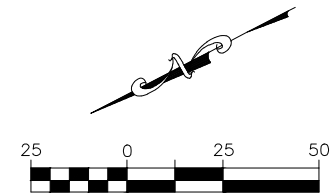
HOLLOWAY ROAD IMPROVEMENTS
FEDERAL PROJECT NO. STP-4939(608)
CITY OF BALLWIN, MISSOURI

DATE	REVISION

DWN. BY: K.J.W. APPD. BY: M.D.S.
DATE: JANUARY 2021
SCALE: 1" = 50'
PROJ. NO.: SC19-981
DWG. NO.: EC-7

Drawing name: U:\SC19-981 Holloway Road, Ballwin, MO\AUTOCAD DRAWINGS\EROSION CONTROL PLAN.dwg Tab: EC-7 Plotted on: Feb 09, 2021 - 10:32am Plotted by: kwolff

EROSION CONTROL PLAN



MATCH LINE STA. 56+00 SEE SHEET EC-7

MATCH LINE STA. 62+00 SEE SHEET EC-9

TRACT NO. 33
221 BLUE SAGE CT.
MIMG XCII SEVEN TRAILS LLC
BK. 22652 PG.1507
DOC. NO. 2017081500432

TRACT NO. 42
126 SEVEN TRAILS DR.
MIMG XCIII SEVEN TRAILS LLC.
BK. 22652 PG. 1507
DOC. NO. 2017081500432

TRACT NO. 43
407 KEHRS MILL RD.
CITY OF BALLWIN
BK. 5765 PG. 217

TRACT NO. 41
556 SPRAGUES MILL CT.
MILLER, TIMOTHY P.
BK. 169323 PG. 842
DOC. NO. 2005112201286

TRACT NO. 43
560 SPRAGUES MILL CT.
SCHAEFFIER, GREGORY J.
& KAREN J. H/W
BK. 8476 PG. 1330

TRACT NO. 44
562 SPRAGUES MILL CT.
ANDERSON, ZACHARY K.
& BRIDGES, ABIGAIL L. T/E
BK. 22572 PG. 1301
DOC. NO. 2017061900279

TRACT NO. 45
211 HOLLOWAY RD.
EASON, RYAN A.
& LISA D. H/W
BK. 10879 PG. 0777
DOC. NO. 1996070800277

TRACT NO. 46
509 STODDARDS MILL DR.
HOUSER, GUY N. &
ALLISON P. T/E
BK. 23410 PG. 2672

TRACT NO. 47
506 STODDARDS MILL DR.
ODONNELL, FAYE & EVA J. H/W
BK. 21624 PG. 1574

TRACT NO. 48
141 HOLLOWAY RD.
FLAMION, SARA TRUSTEE
BK. 23205 PG. 348
DOC. NO. 2018092000527

Drawing name: U:\SC19-981 Holloway Road, Ballwin, MO\AUTOCAD DRAWINGS\EROSION CONTROL PLAN.dwg Tab: EC-8 Plotted on: Feb 09, 2021 - 10:53am Plotted by: kwelff

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STATE OF MISSOURI

KEVIN J. WOLFF, P.E.
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NO. PE-200400889
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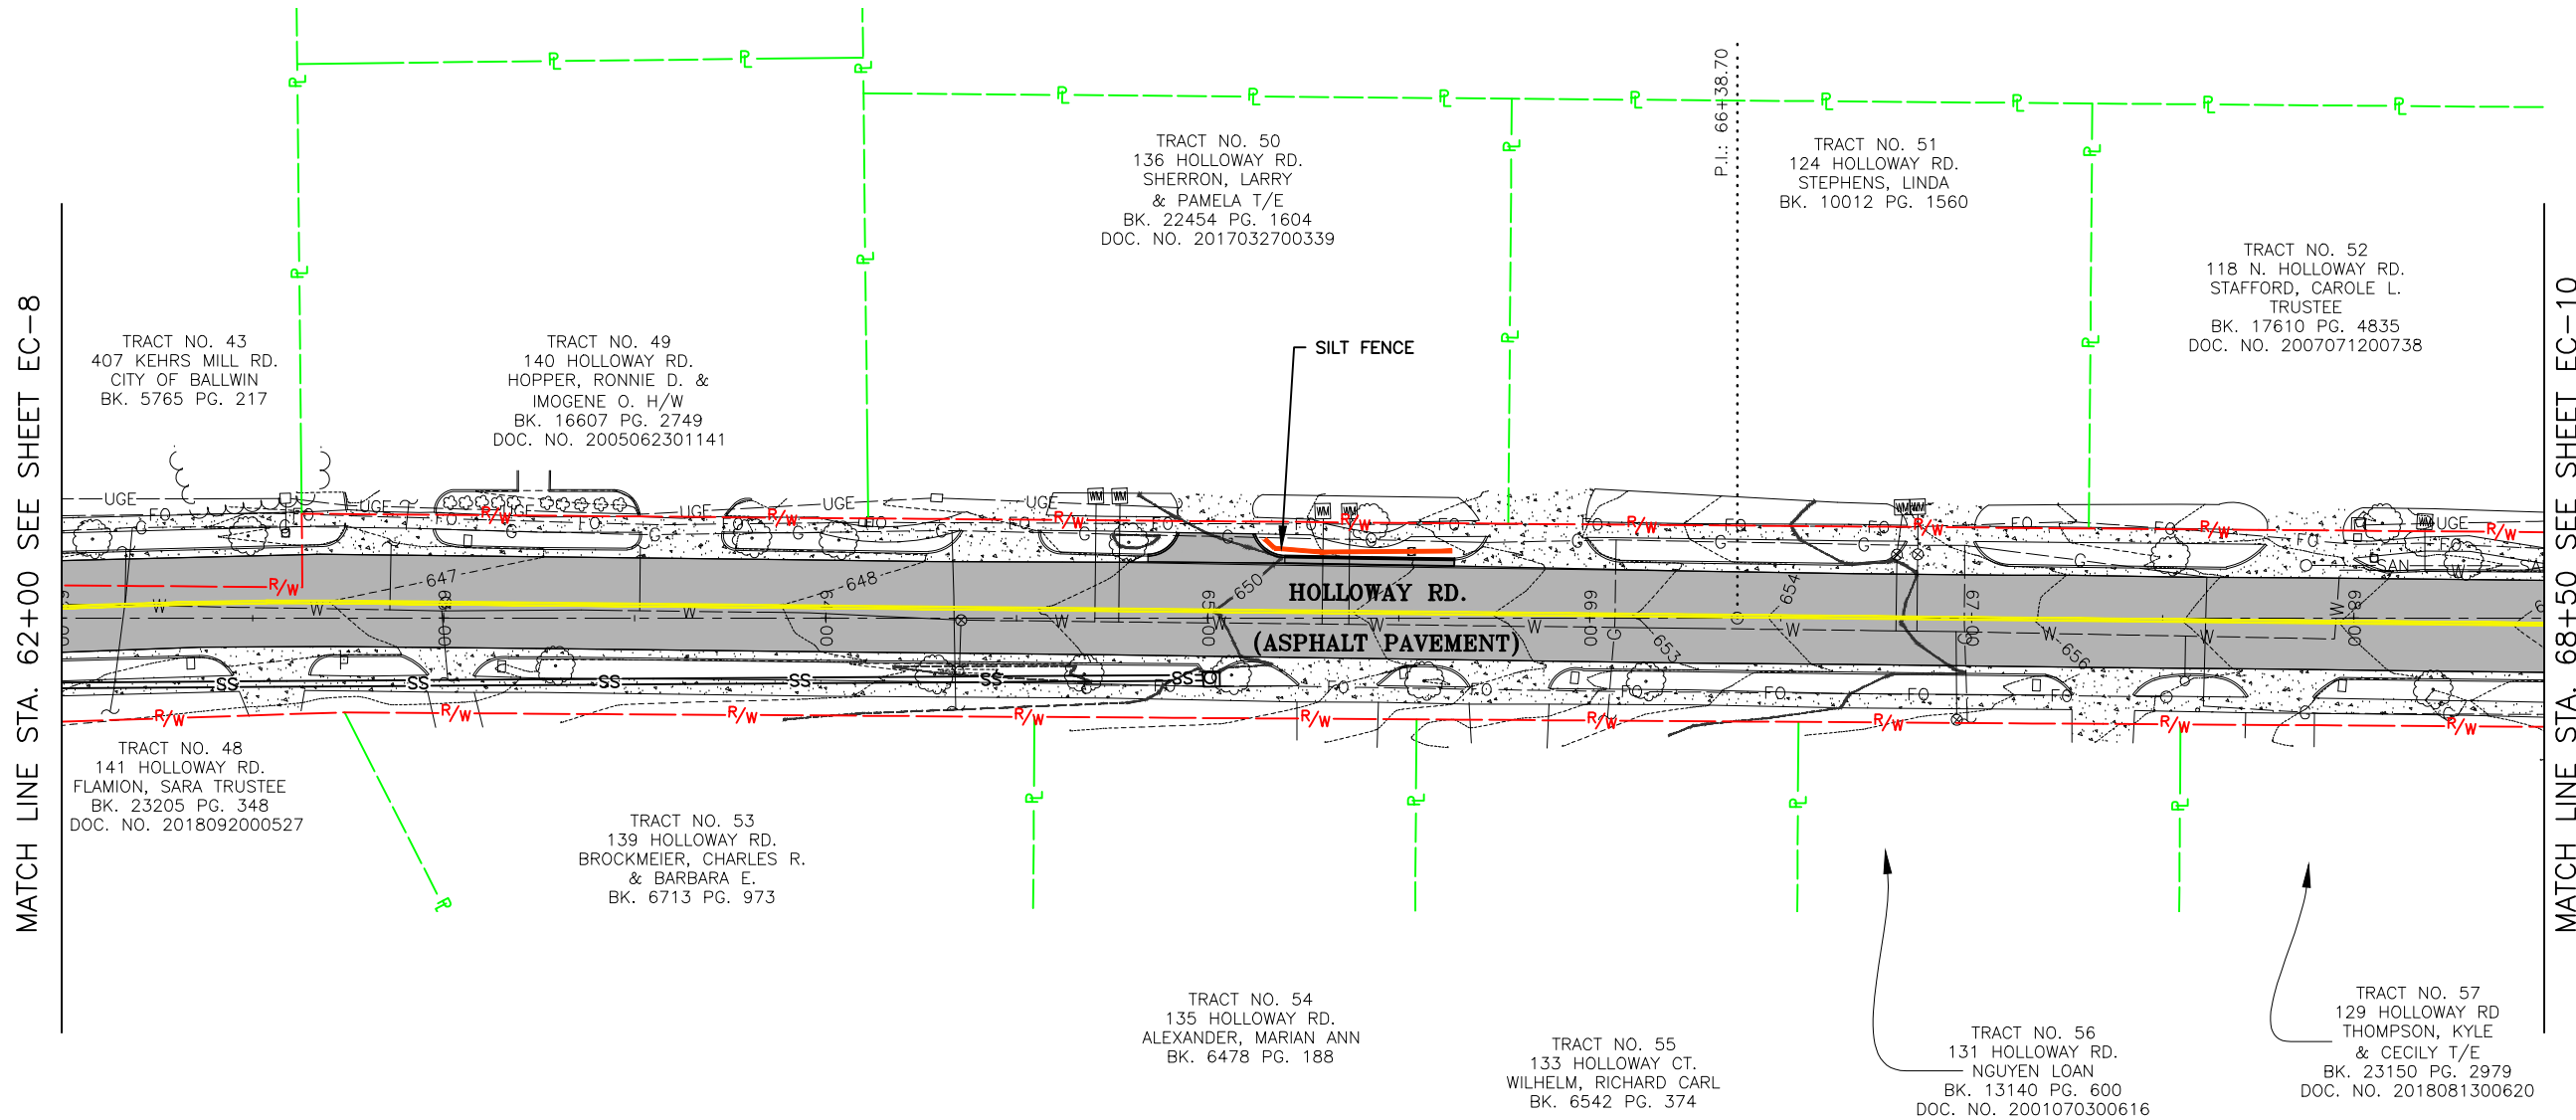
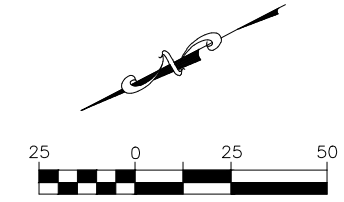
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CITY OF BALLWIN, MISSOURI

DATE	REVISION

DWN. BY:	APPD. BY:
K.J.W.	M.D.S.
DATE:	DATE:
JANUARY 2021	
SCALE:	
1" = 50'	
PROJ. NO.:	
SC19-981	
DWG. NO.:	
EC-8	

EROSION CONTROL PLAN



Drawing name: U:\SC19-981 Holloway Road, Ballwin, MO\AUTOCAD DRAWINGS\EROSION CONTROL PLAN.dwg Tab: EC-9 Plotted on: Feb 09, 2021 - 10:53am Plotted by: kweliff

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STATE OF MISSOURI

KEVIN J. WOLFF, P.E.

1/28/21

NO. PE-200400889
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REGISTERED PROFESSIONAL ENGINEER
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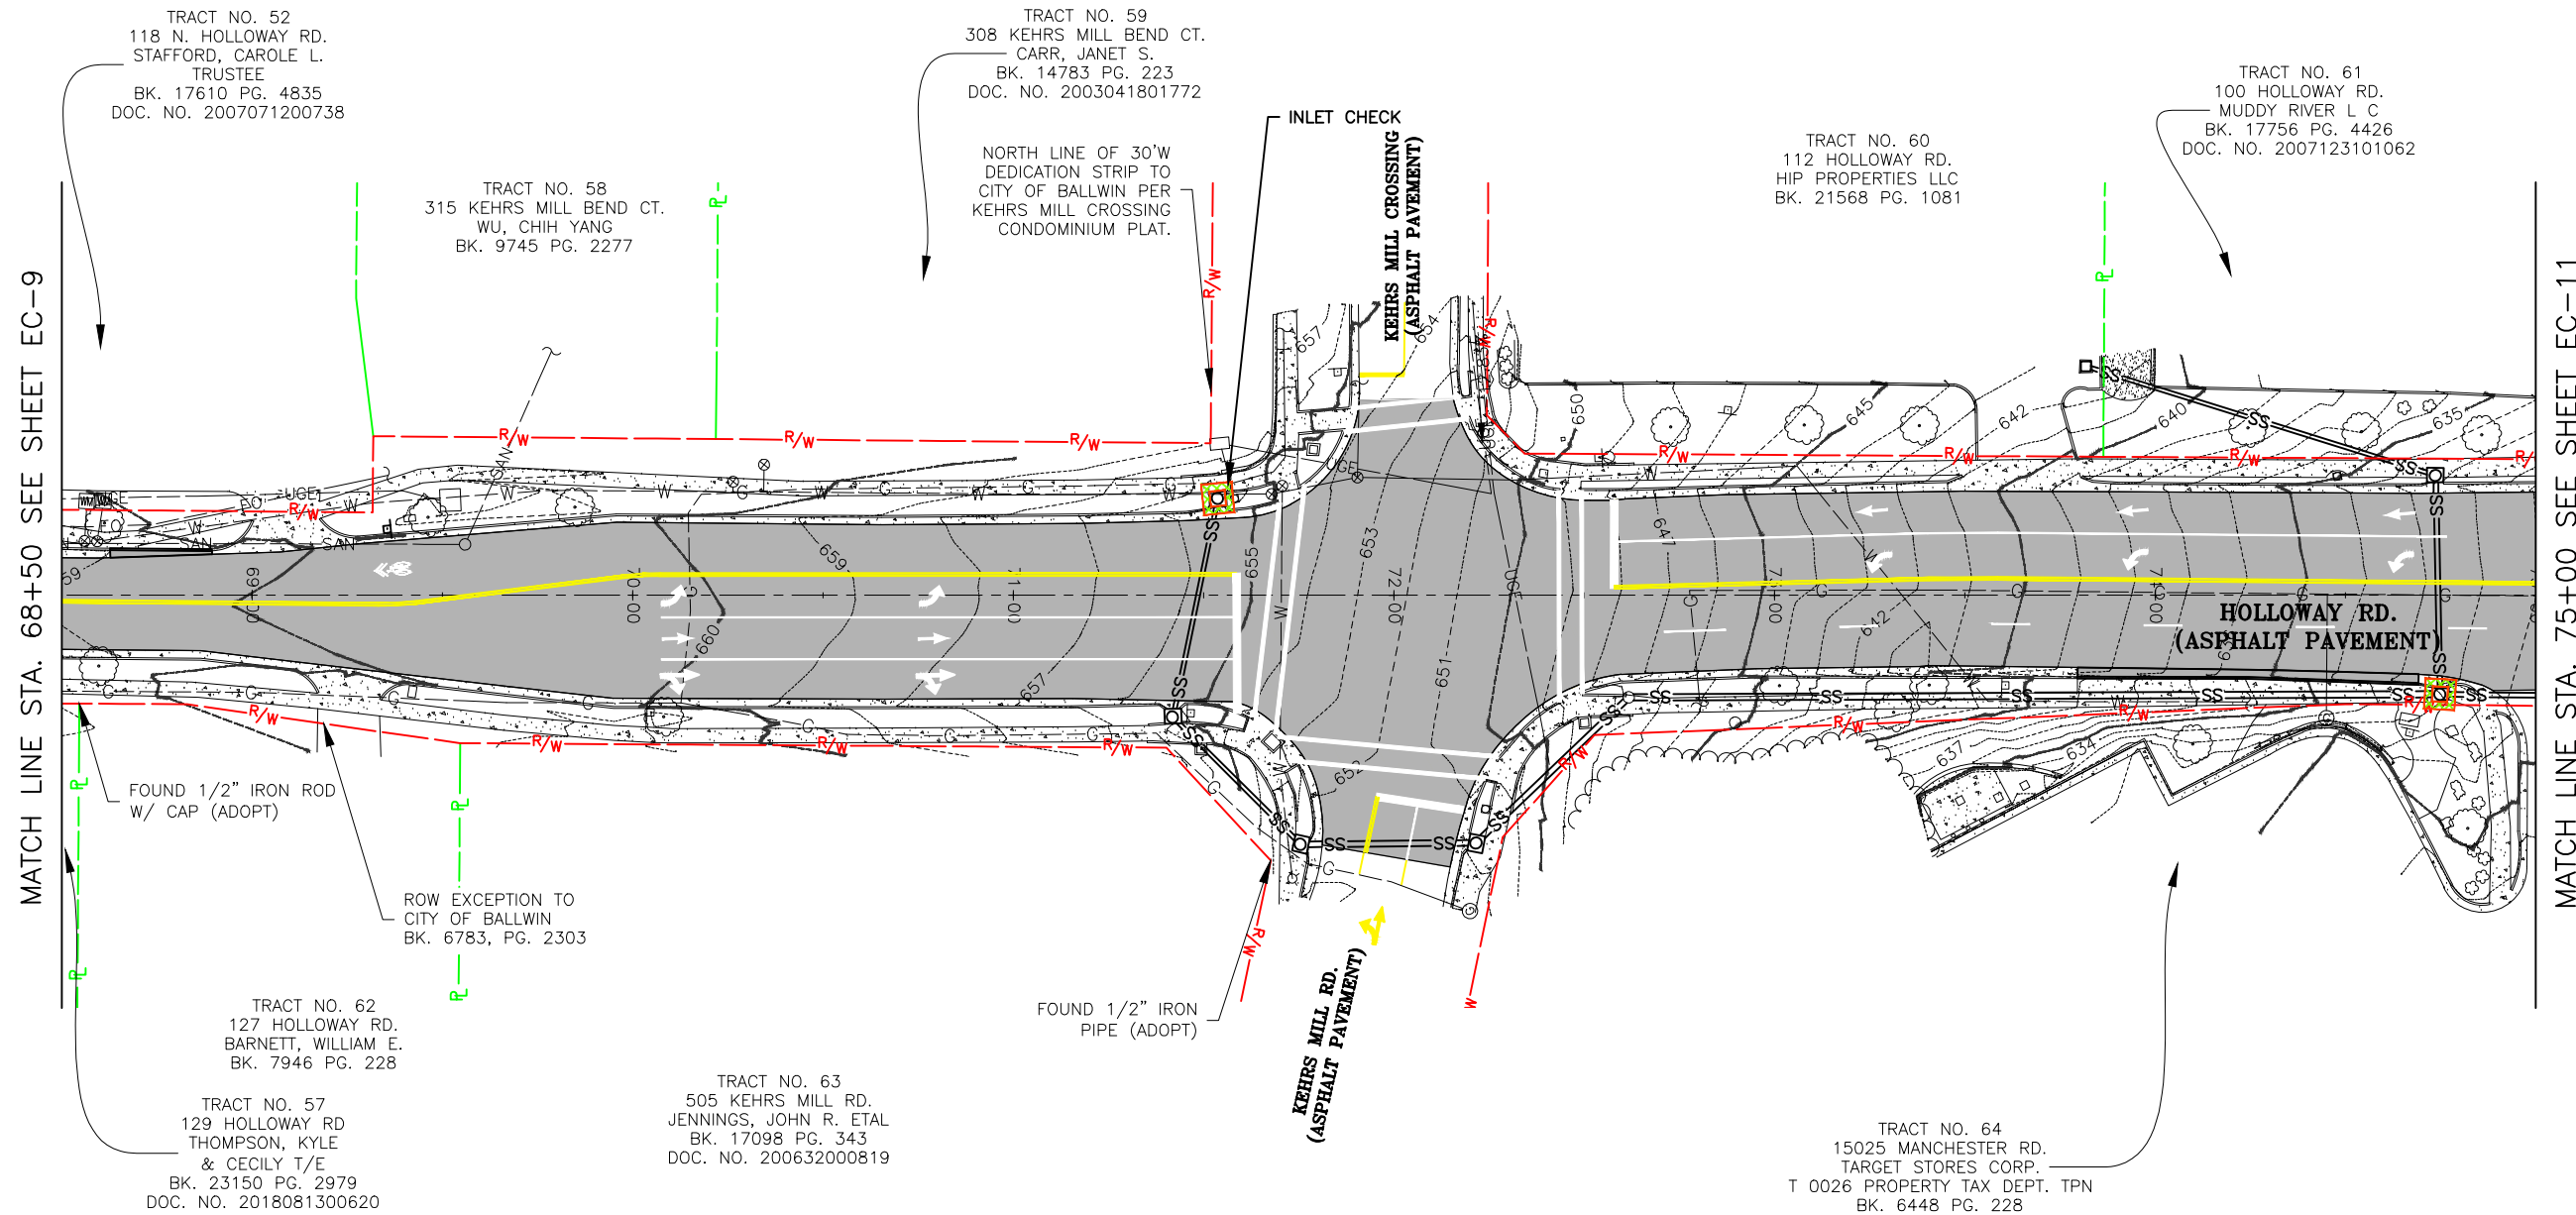
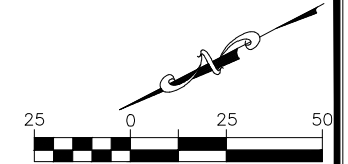
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FEDERAL PROJECT NO. STP-4939(608)
CITY OF BALLWIN, MISSOURI

DATE	REVISION

DWN BY: K.J.W.	APPD BY: M.D.S.
DATE: JANUARY 2021	
SCALE: 1" = 50'	
PROJ. NO: SC19-981	
DWG. NO: EC-9	

EROSION CONTROL PLAN



MATCH LINE STA. 68+50 SEE SHEET EC-9

MATCH LINE STA. 75+00 SEE SHEET EC-11

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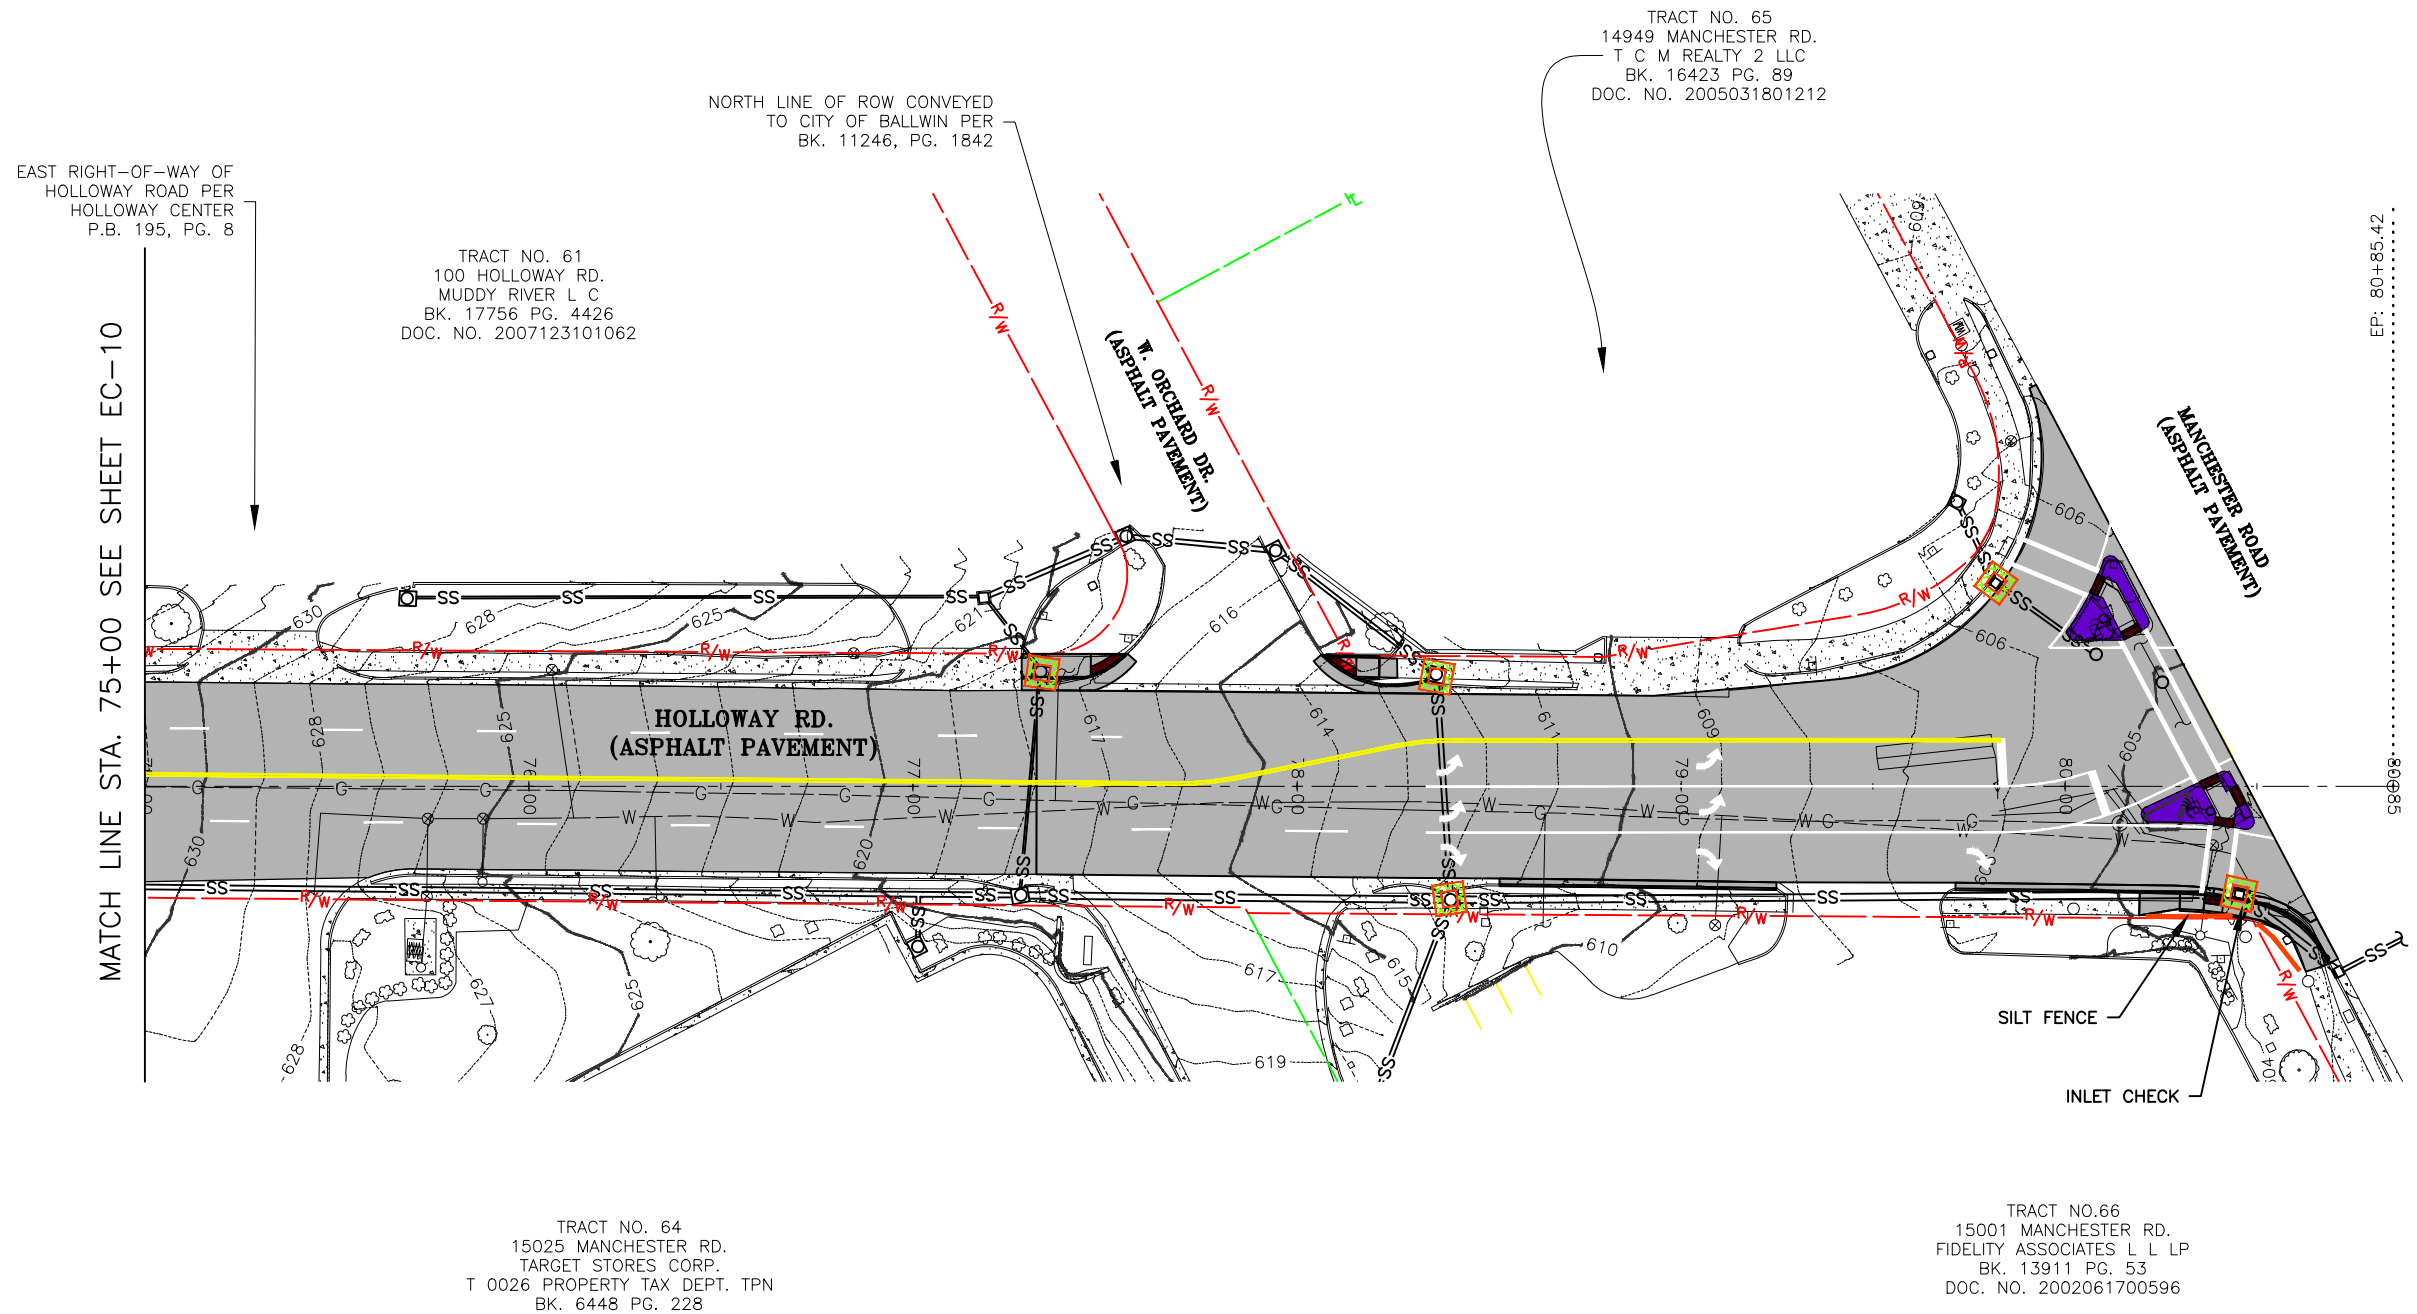
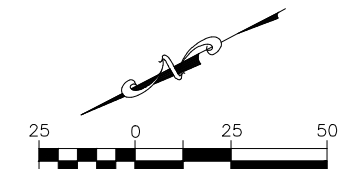
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CITY OF BALLWIN, MISSOURI

DATE	REVISION

DWN. BY: K.J.W.	APPD. BY: M.D.S.
DATE: JANUARY 2021	
SCALE: 1" = 50'	
PROJ. NO. SC19-981	
DWG. NO. EC-10	

EROSION CONTROL PLAN



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STATE OF MISSOURI

KEVIN J. WOLFF, P.E.

PROFESSIONAL ENGINEER

1/28/21

KEVIN J. WOLFF
NO. PE-200400889
STATE OF MISSOURI
REGISTERED PROFESSIONAL ENGINEER
FOR SC ENGINEERING LLC,
DBA COCHRAN



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CITY OF BALLWIN, MISSOURI


EROSION CONTROL PLAN	
DATE	REVISION
DWN BY: K.J.W.	APPD BY: M.D.S.
DATE: JANUARY 2021	
SCALE: 1" = 50'	
PROJ. NO: SC19-981	
DWG. NO: EC-11	

EROSION CONTROL DETAILS




DETAIL A
SILTATION CONTROL DETAILS
NO SCALE

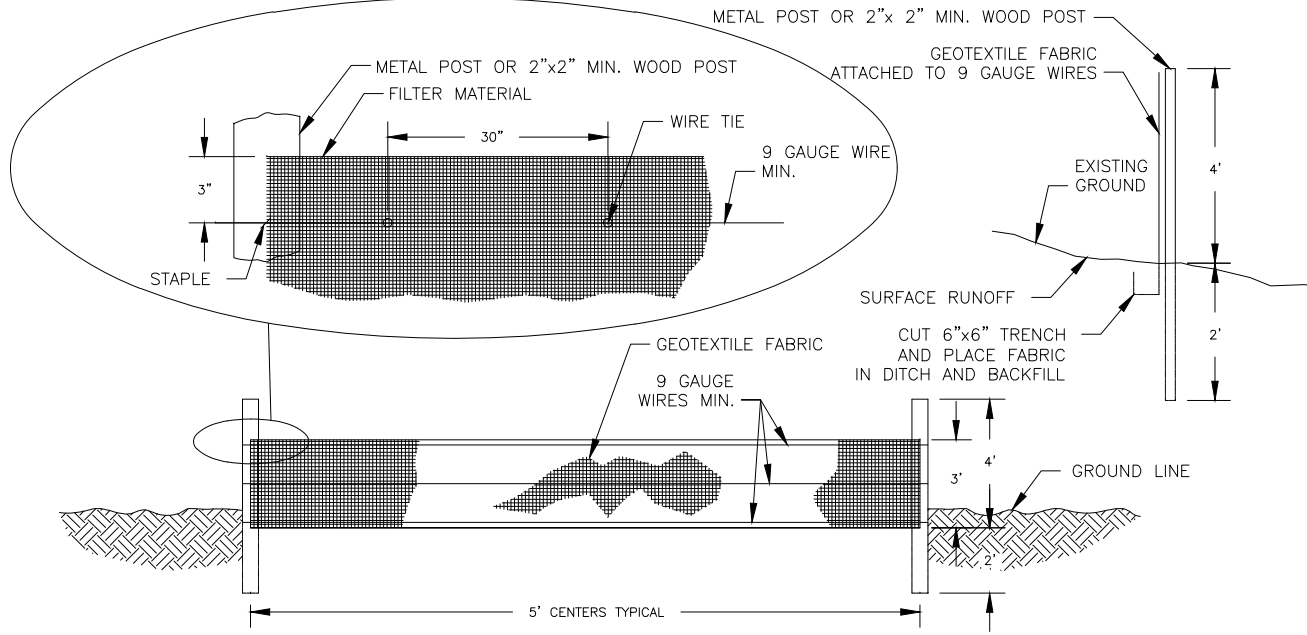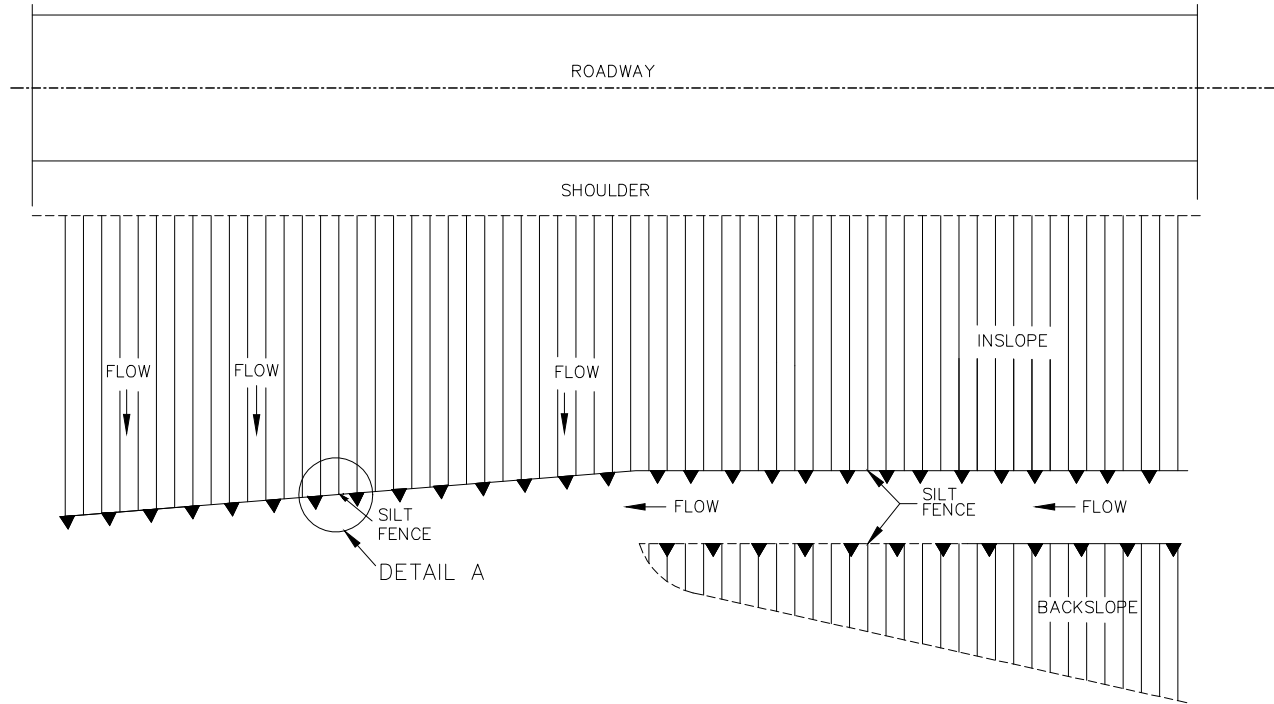- GENERAL NOTES:**
- SILTATION CONTROL DEVICES TO REMAIN IN PLACE UNTIL ADEQUATE VEGETATIVE GROWTH ENSURES NO FURTHER EROSION OF THE SOIL. THE CONTRACTOR SHALL BE RESPONSIBLE FOR REMOVING THE SILT FENCE.
 - SILT FENCES SHALL BE INSPECTED PERIODICALLY FOR DAMAGE AND FOR THE AMOUNT OF SEDIMENTATION WHICH HAS ACCUMULATED. REMOVAL OF SEDIMENT WILL BE REQUIRED WHEN IT REACHES 1/2 OF THE HEIGHT OF THE SILT FENCE.
 - ATTACHMENT OF THE GEOTEXTILE FABRIC TO BE IN ACCORDANCE WITH THE MANUFACTURER'S RECOMMENDATION.
 - SILTATION CONTROL SHALL BE INSTALLED AS NEEDED OR AS DIRECTED BY THE ENGINEER TO ENSURE THAT NO SILT LEAVES THE CONSTRUCTION AREA.
 - USE SILT FENCE FOR ALL SLOPES OVER 3 FEET IN HEIGHT.
 - FOR FABRIC SILT FENCE:
MINIMUM LONGITUDINAL SPLICE OVERLAP SHALL BE 2' WITH A POST AT EACH END.
SECURE FABRIC TO POSTS.
 - SILT FENCE SHALL NOT BE USED ACROSS DRAINAGE DITCHES AND DRAINS. DITCH CHECK SHALL BE USED AS SHOWN ON SHEET EC-2 OR AS DIRECTED BY ENGINEER.
 - CONTRACTOR SHALL USE INLET CHECK EROSION CONTROL DEVICES TO PREVENT ANY SILT OR DEBRIS FROM ENTERING ANY NEW OR EXISTING CURB INLETS DURING CONSTRUCTION.

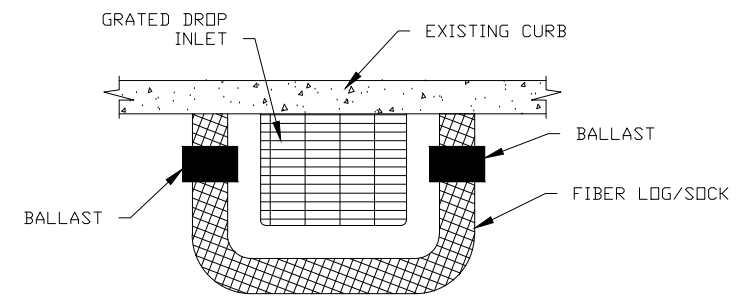

CURB DROP INLET PROTECTION
NO SCALE

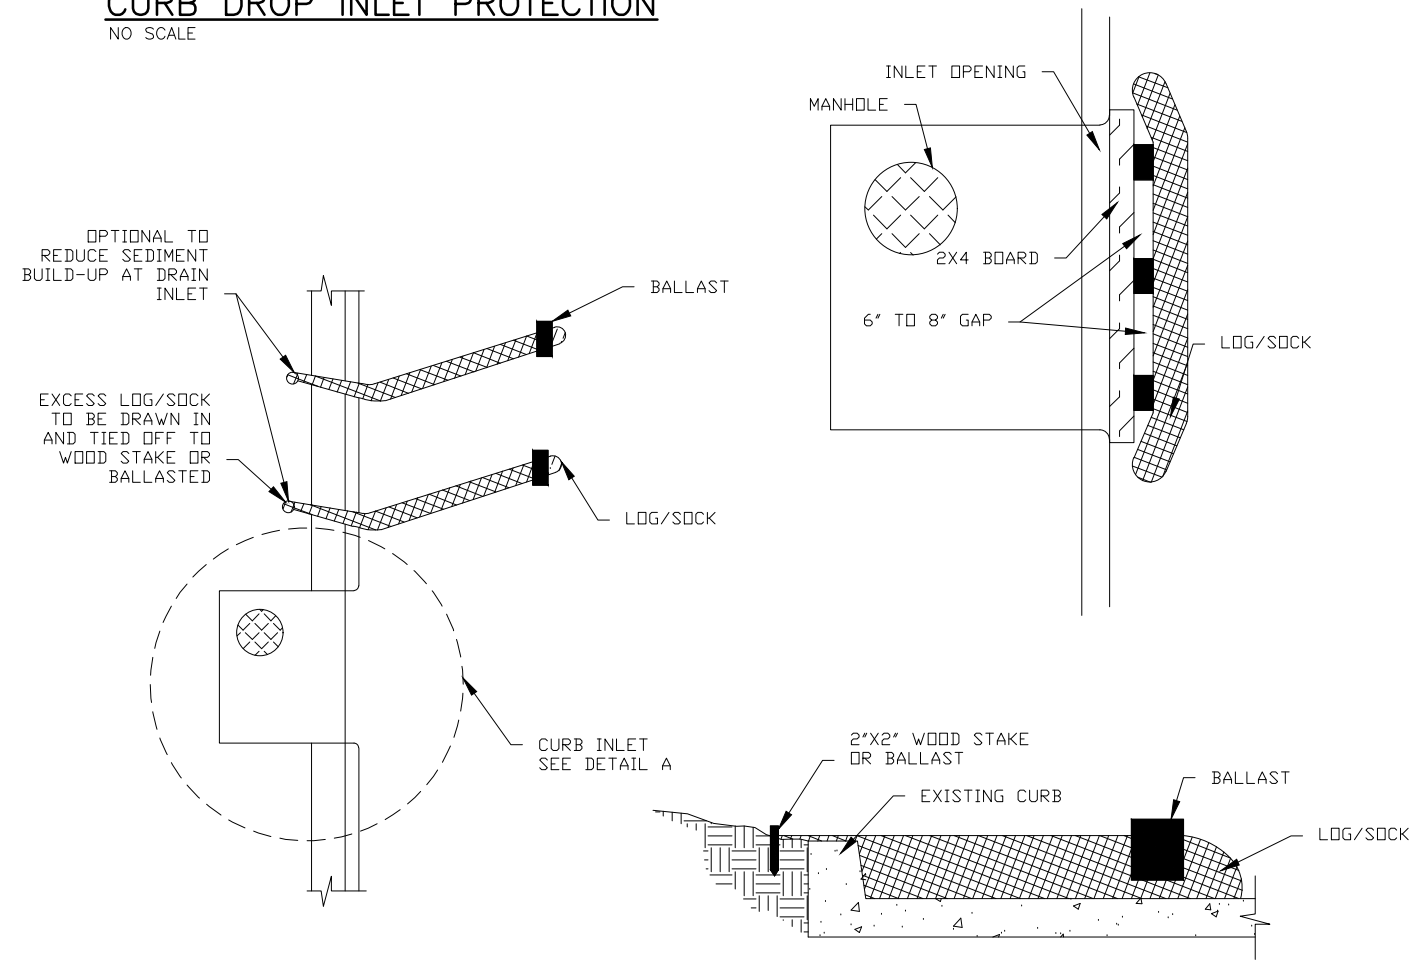

CURB INLET PROTECTION
NO SCALE

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LAND SURVEYING CERTIFICATE OF AUTHORITY NUMBER - 2007004529

737 RUDDER ROAD
FENTON, MISSOURI 65026

STATE OF MISSOURI
KEVIN J. WOLFF, P.E.
Professional Engineer
1/28/21
NO. PE-204400859
STATE OF MISSOURI
REGISTERED PROFESSIONAL ENGINEER
FOR SC ENGINEERING LLC,
DBA COCHRAN

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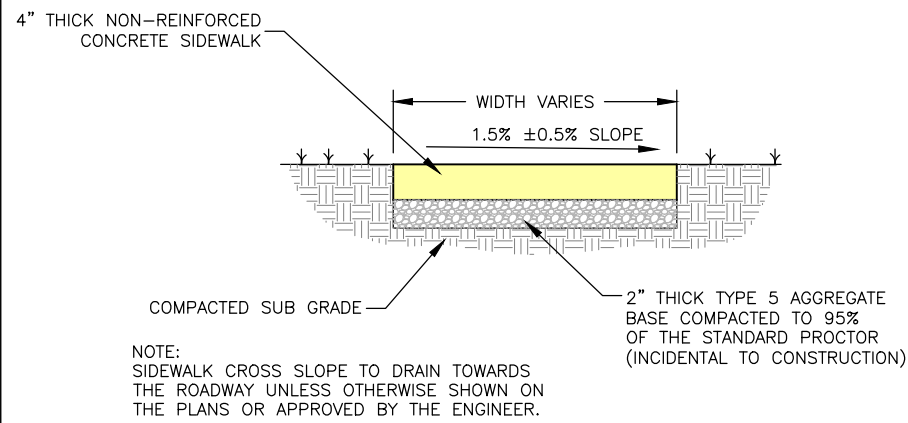
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FEDERAL PROJECT NO. STP-4939(608)
CITY OF BALLWIN, MISSOURI


EROSION CONTROL DETAILS

DATE:	DATE:
DWN BY:	APPD BY:
K.J.W.	M.D.S.
DATE: JANUARY 2021	
SCALE: 1" = 50'	
PROJ. NO.: SC19-981	
DWG. NO.: EC-12	

Drawing name: I:\SC19-981 Holloway Road, Ballwin, MO\AUTOCAD DRAWINGS\SIDEWALK AND RAMP DETAILS.dwg Tab: DE-1 Plotted on: Feb 09, 2021 - 10:33am Plotted by: knloff




SIDEWALK CROSS-SECTION DETAIL
NO SCALE

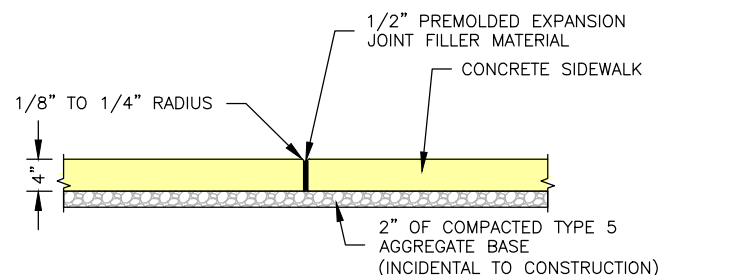

NOTE: USE THIS TYPE OF JOINT EVERY 15' ON CENTER AND AT ALL STREET INTERSECTIONS

TYPICAL SIDEWALK EXPANSION JOINT
NO SCALE

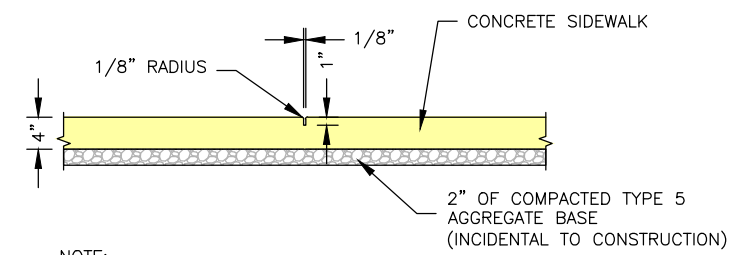

NOTE: USE THIS TYPE OF JOINT EVERY 5' ON CENTER.


TYPICAL SIDEWALK CONTROL JOINT
NO SCALE

SIDEWALK NOTES:


WHEN A JOINT FALLS WITHIN FIVE FEET OR CONTACTS AN OBJECT (I.E. SIGN POST, LIGHT BASE, POLE, STRUCTURE, CORNER OF A BUILDING, ETC.), THE JOINT SHALL BE MOVED TO PERMIT THE JOINT TO FALL IN THE CENTER OF THE OBJECT AND THE ADJACENT JOINT SPACING SHALL BE ADJUSTED ACCORDINGLY. THE ENGINEER HAS THE RIGHT TO MAKE ADJUSTMENTS TO THE PLACEMENT OF THE JOINTS IN THE FIELD AS HE DEEMS NECESSARY.

WHEN INSTALLING SIGNS IN NEW SIDEWALKS, PVC SLEEVES SHALL BE INSTALLED PRIOR TO PLACEMENT OF ANY NEW CONCRETE. PVC SLEEVE SHALL BE SCHEDULE 40 PVC. THE LENGTH OF THE SLEEVE SHALL BE THE SAME AS THE THICKNESS OF THE SIDEWALK AND AGGREGATE BASE. THE PVC SLEEVE SHALL BE INSTALLED FLUSH WITH THE FINISH GRADE OF THE SURROUNDING SIDEWALK. BACK FILL THE VOID BETWEEN THE SLEEVE AND SIGN POST WITH SAND TO WITHIN 1" OF THE FINISHED SURFACE. FILL THE FINAL 1" WITH NON-SHRINK GROUT.

NOTES:
ALL DOWNSPOUT PIPE UNDER SIDEWALK SHALL BE 4" SCHEDULE 40 PVC PIPE.
CONTRACTOR SHALL EXTEND EXISTING DOWNSPOUTS AS NECESSARY TO PROVIDE ADEQUATE DRAINAGE TO FLOWLINE OF GUTTER.

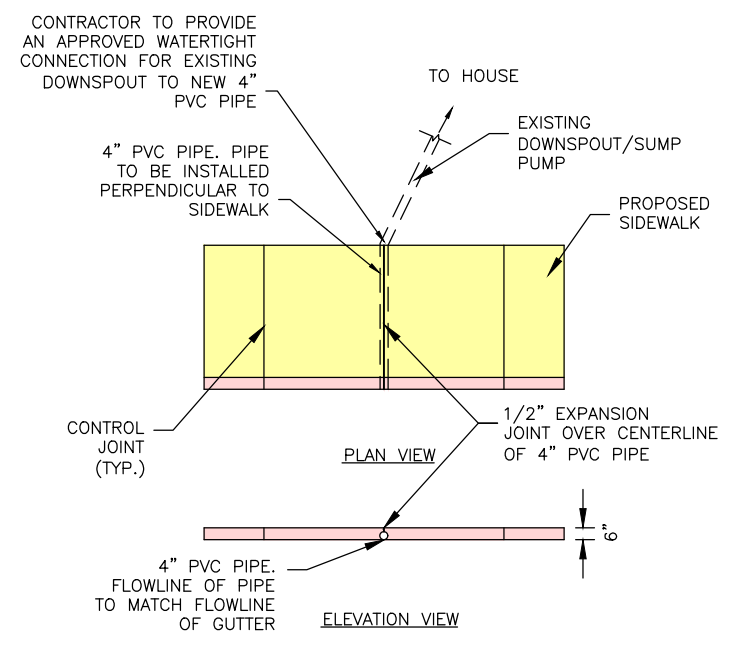

EXTENSION OF PRIVATE DRAIN PIPE THROUGH SIDEWALK
NO SCALE

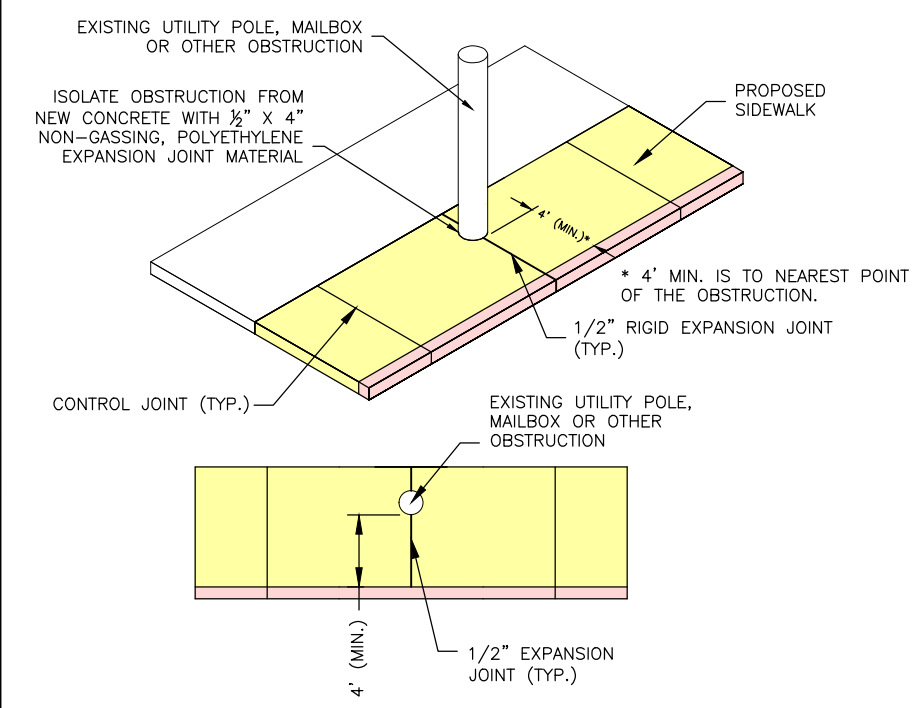


SIDEWALK SECTION AT OBSTRUCTION
NO SCALE

LEGEND

- ← 1.0% MIN., 2% MAX. CROSS SLOPE.
- ↕ LANDING AREA. MIN. 5' X 5' WITH 1.0% MIN., 2.0% MAX. SLOPE IN ANY DIRECTION.
- ← MAX. RAMP SLOPE IS 1V:12H (8.33%) AND HAVE A CROSS SLOPE OF 1.0% MIN., 2% MAX.
- ▨ DETECTABLE WARNING DEVICE. EXTEND 2' IN DIRECTION OF TRAVEL.

NOTE: THE SURFACE OF THE PEDESTRIAN ACCESS ROUTE SHALL BE LEVEL AND FLUSH WITH THE TOP OF THE RAIL AT THE OUTER EDGES OF THE RAIL. THE SURFACE BETWEEN THE RAILS SHALL BE ALIGNED WITH THE TOP OF THE RAIL.

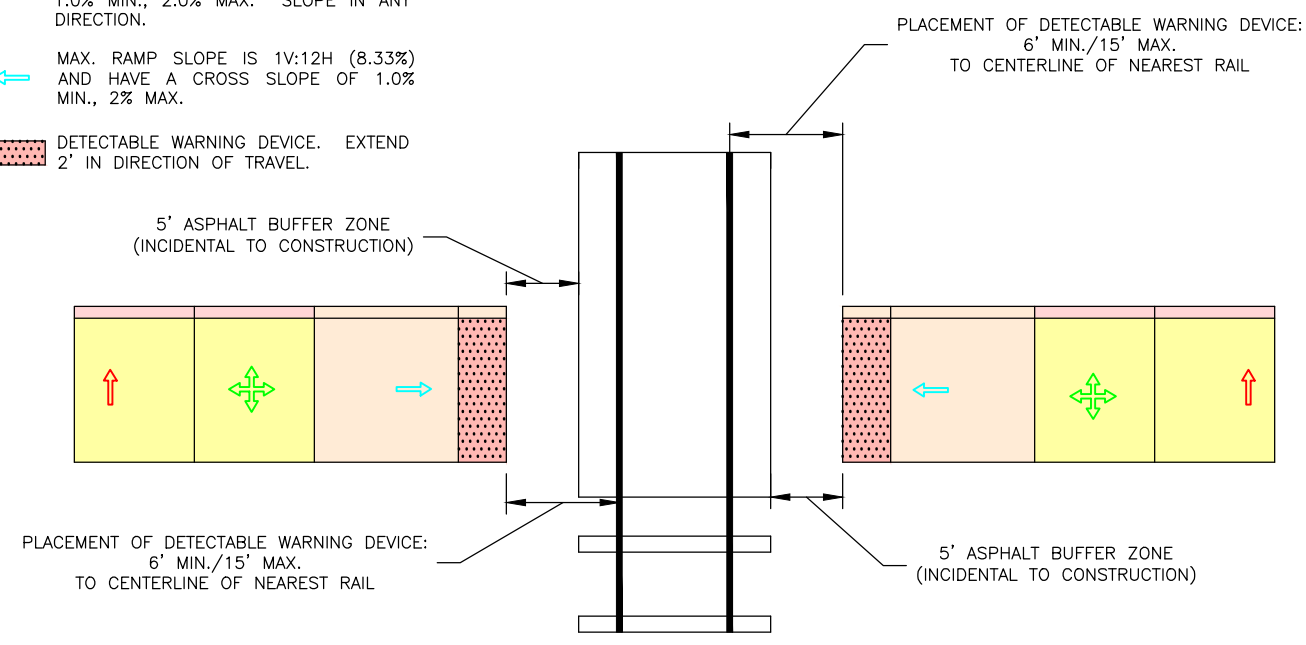

RAMP AND DETECTABLE WARNING PLACEMENT AT RAIL ROAD CROSSING
NO SCALE

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FENTON, MISSOURI 65026

COCHRAN

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Land Surveying
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Master Planning
General Consulting
ENGINEERING CERTIFICATE OF AUTHORITY NUMBER - 2007006937
LAND SURVEYING CERTIFICATE OF AUTHORITY NUMBER - 2007004529

STATE OF MISSOURI
PROFESSIONAL ENGINEER

KEVIN J. WOLFF, P.E.
NO. PE-200400889
STATE OF MISSOURI
REGISTERED PROFESSIONAL ENGINEER
FOR SC ENGINEERING LLC,
DBA COCHRAN



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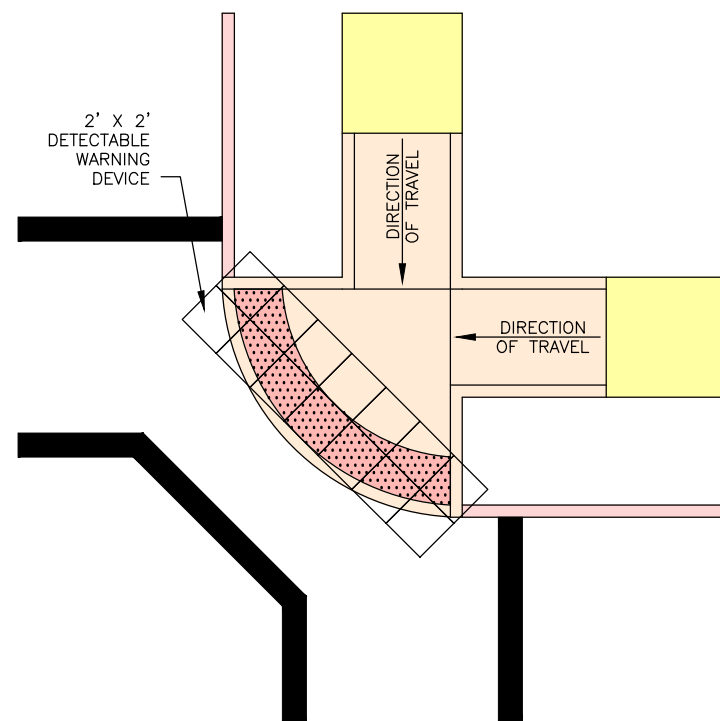
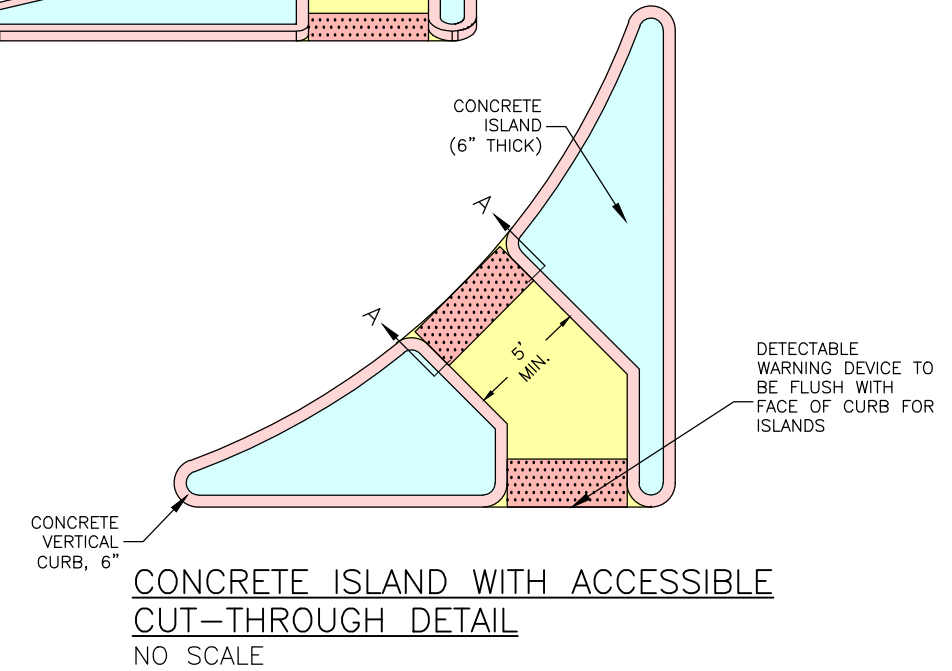
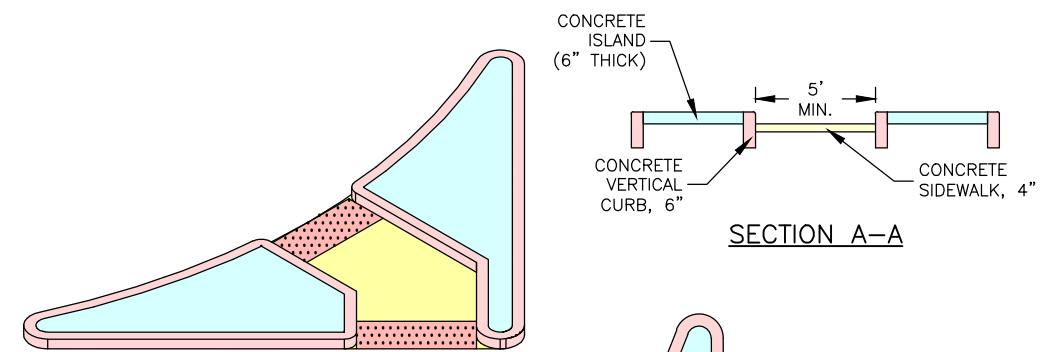
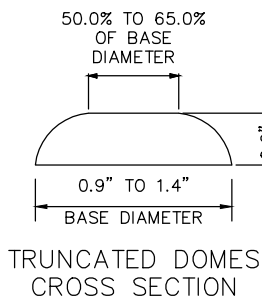
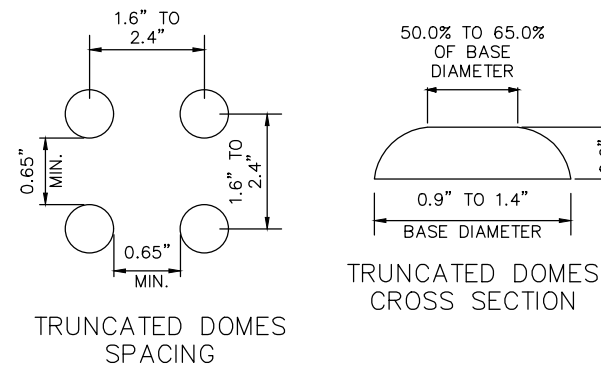
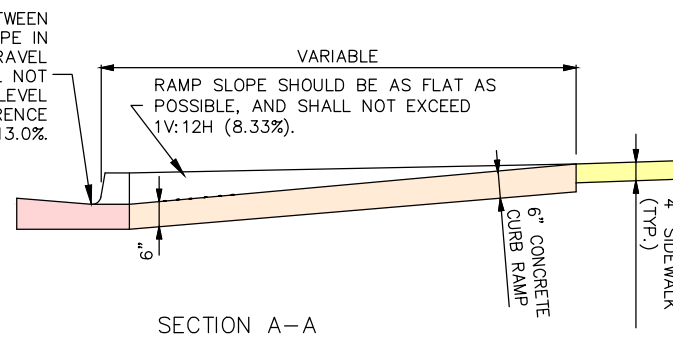
HOLLOWAY ROAD IMPROVEMENTS
FEDERAL PROJECT NO. STP-4939(608)
CITY OF BALLWIN, MISSOURI

DATE:	DATE:	DATE:	DATE:
REVISION:	REVISION:	REVISION:	REVISION:
DWN. BY:	APPD. BY:	DWN. BY:	APPD. BY:
K.J.W.	M.D.S.	K.J.W.	M.D.S.
DATE:	DATE:	DATE:	DATE:
JANUARY 2021	JANUARY 2021	JANUARY 2021	JANUARY 2021
SCALE:	SCALE:	SCALE:	SCALE:
AS SHOWN	AS SHOWN	AS SHOWN	AS SHOWN
PROJ. NO.:	PROJ. NO.:	PROJ. NO.:	PROJ. NO.:
SC19-981	SC19-981	SC19-981	SC19-981
DWG. NO.:	DWG. NO.:	DWG. NO.:	DWG. NO.:
DE-1	DE-1	DE-1	DE-1

Drawing name: I:\SC19-981 Holloway Road, Ballwin, MO\AUTOCAD DRAWINGS\SIDEWALK AND RAMP DETAILS.dwg Tab: DE-2 Plotted on: Feb 09, 2021 - 10:33am Plotted by: knoiff




ALGEBRAIC DIFFERENCE BETWEEN PAVEMENT OR GUTTER SLOPE IN DIRECTION OF PEDESTRIAN TRAVEL AND CURB RAMP SLOPE SHALL NOT EXCEED 13.0%. PROVIDE 24" LEVEL LANDING IF ALGEBRAIC DIFFERENCE EXCEEDS 13.0%.

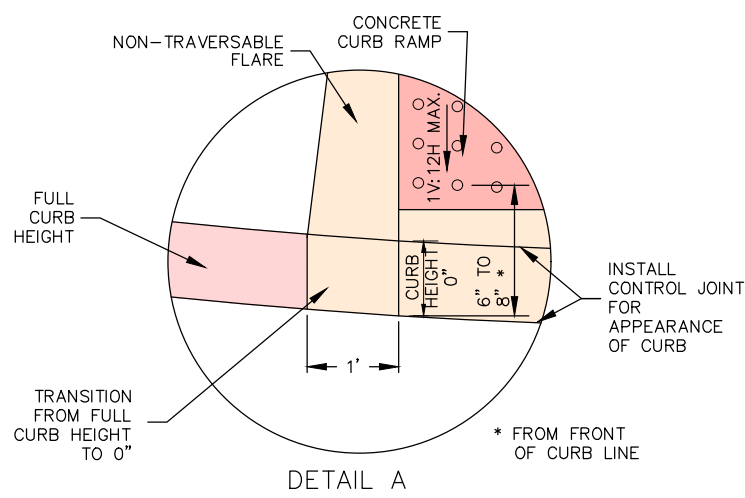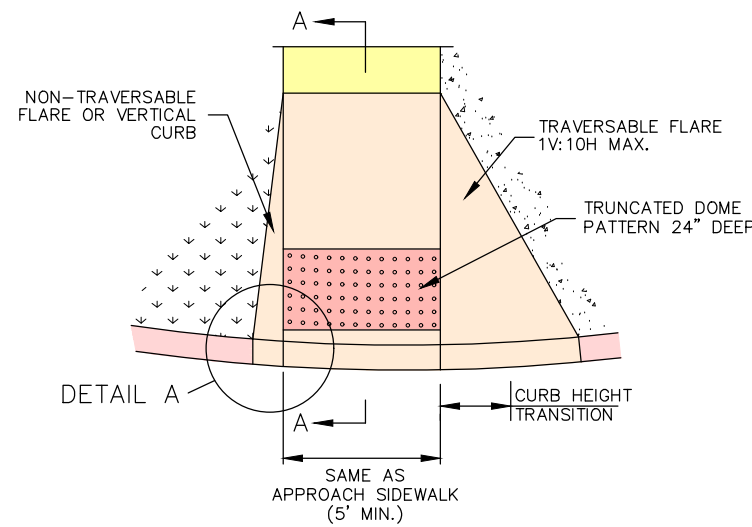


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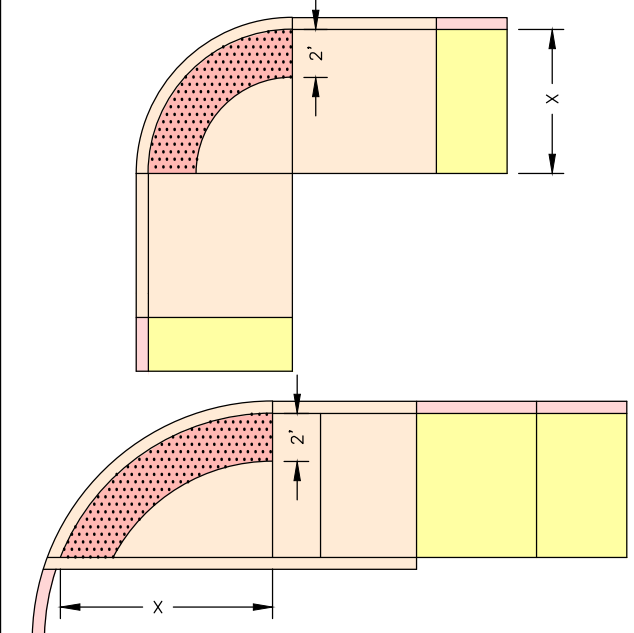
1. CONTRACTOR MUST TRIM THE DETECTABLE WARNING PANELS TO PROVIDE A 2' DEEP STRIP THAT IS THE FULL WIDTH OF THE RAMP AND FOLLOWS THE CURVATURE OF THE CURB.
2. 2' X 2' DETECTABLE WARNING PANEL IS FOR REFERENCE ONLY. CONTRACTOR MAY USE ALTERNATE SIZED PANELS TO MINIMIZE CUTTING.
3. THE DETECTABLE WARNING DEVICE LAYOUT FOR 1 DIRECTIONAL RAMP MUST BE USED WHEN THE "X" DIMENSION IS GREATER THAN 5 FEET. WHEN "X" IS LESS THAN 5 FEET, THE DETECTABLE WARNING DEVICES SHALL BE AT THE BOTTOM OF THE RAMP AND PARALLEL TO THE DIRECTION OF TRAVEL.

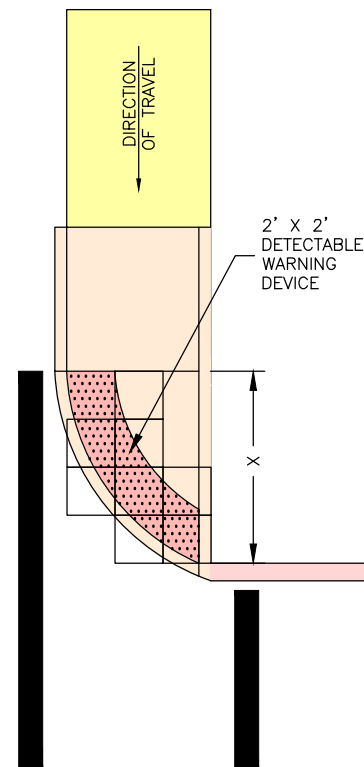

WHEN DISTANCE "X" IS LESS THAN 5', TRUNCATED DOME DETECTABLE WARNING DEVICE SHALL BE PLACED PERPENDICULAR TO THE PATH OF TRAVEL.

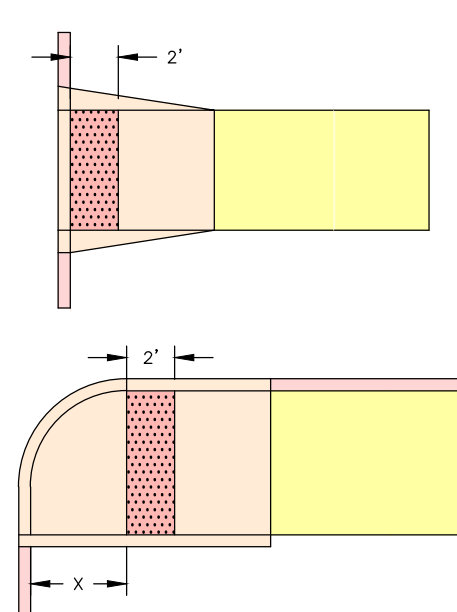

WHEN DISTANCE "X" IS GREATER THAN 5', TRUNCATED DOME DETECTABLE WARNING DEVICE SHALL BE PLACED PARALLEL TO THE BOTTOM OF THE CURB RAMP.



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FENTON, MISSOURI 63026

STATE OF MISSOURI

KEVIN J. WOLFE, P.E.

1/28/21

NO. PE-200400899

STATE OF MISSOURI

REGISTERED PROFESSIONAL ENGINEER FOR SC ENGINEERING LLC, DBA COCHRAN

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



HOLLOWAY ROAD IMPROVEMENTS

FEDERAL PROJECT NO. STP-4939(608)

CITY OF BALLWIN, MISSOURI

DATE	REVISION
DWN BY: K.J.W.	APPD BY: M.D.S.
DATE: JANUARY 2021	SCALE: AS SHOWN
PROJ. NO: SC19-981	DWG. NO: DE-2


LEGEND

-  1.0% MIN., 2.0% MAX. CROSS SLOPE.
-  LANDING AREA. MIN. 5' X 5' WITH 1.0% MIN., 2.0% MAX. SLOPE IN ANY DIRECTION.
-  MAX. RAMP SLOPE IS 1V:12H (8.33%) AND HAVE A CROSS SLOPE OF 1.0% MIN., 2.0% MAX.
-  DETECTABLE WARNING DEVICE. EXTEND 2' IN DIRECTION OF TRAVEL.


KEYED NOTES

- (1) 1' OR VERTICAL CURB AS DIRECTED BY THE ENGINEER. IF TRAVERSABLE, MAX. SLOPE IS 1V:10H WHEN MEASURED PARALLEL TO CURB LINE.
- (2) SEE PLAN SHEETS FOR WIDTH. SIDEWALKS AT CURB SHALL BE A MINIMUM OF 6' WIDE AND SIDEWALKS WITH A TREE LAWN SHALL BE A MINIMUM OF 5', WIDE UNLESS OTHERWISE APPROVED BY THE ENGINEER.
- (3) DETECTABLE WARNING DEVICES ARE NOT USED ON EVERY CURB RAMP INSTALLED. SEE SITE PLAN FOR LOCATIONS WITH DETECTABLE WARNING DEVICES.
- (4) TRANSITION AREA SLOPE TO BE MAXIMUM OF 5.0% OR MATCH STREET GRADE. SLOPES SHALL NOT CREATE AN AREA THAT HOLDS WATER.


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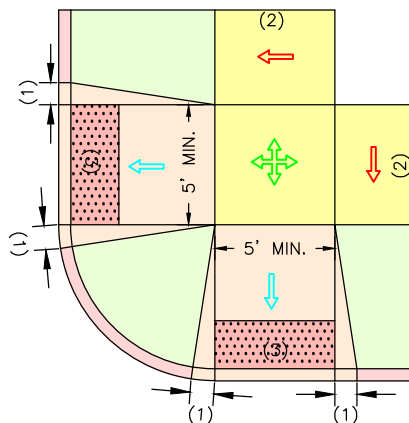
TYPE A1

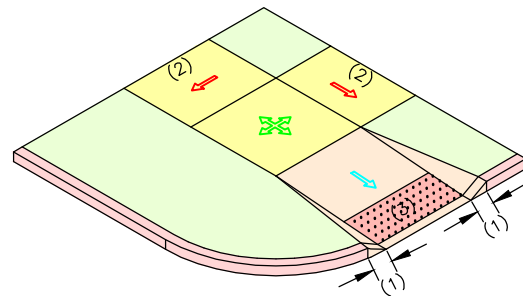

TYPE A2

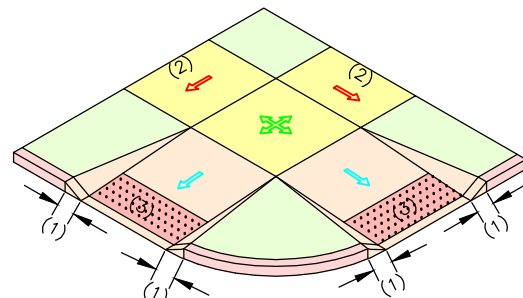


TYPE A1

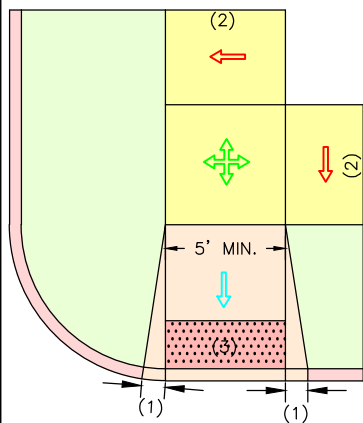


TYPE A2


TYPE A1 AND A2 CURB RAMP PERPENDICULAR WITH TREE LAWN (6' OR GREATER)
NO SCALE

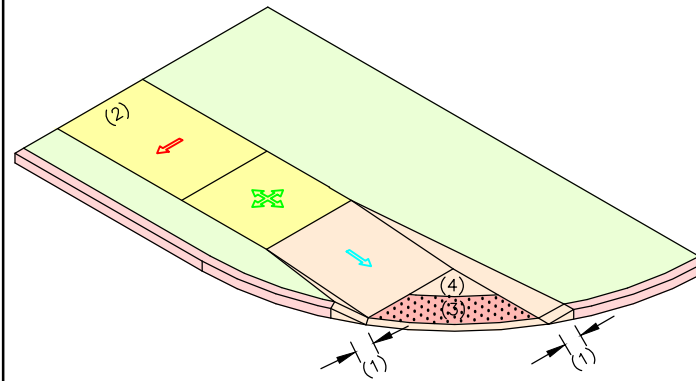

TYPE A3 CURB RAMP PERPENDICULAR WITH TREE LAWN LARGE RADIUS
NO SCALE

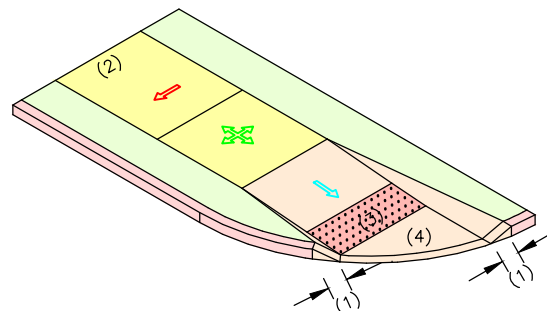




TYPE A4 CURB RAMP PERPENDICULAR WITH TREE LAWN, SMALL RADIUS
NO SCALE

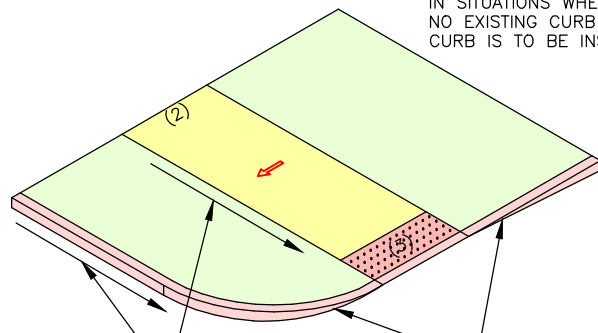

TYPE A5 CURB RAMP PERPENDICULAR WITH TREE LAWN, NO RAMP
NO SCALE

NOTE: TYPE A5 ALSO APPLIES IN SITUATIONS WHERE THERE IS NO EXISTING CURB AND NO CURB IS TO BE INSTALLED.

SIDEWALK GRADE TO MATCH ROAD GRADE
ROAD WARPS UP TO SIDEWALK HEIGHT. NO SIDEWALK RAMP NEEDED.

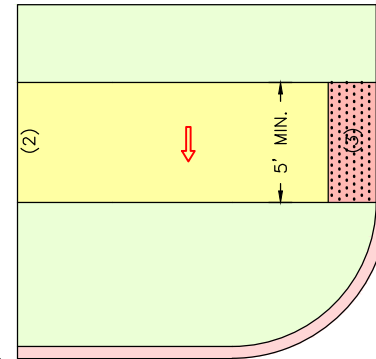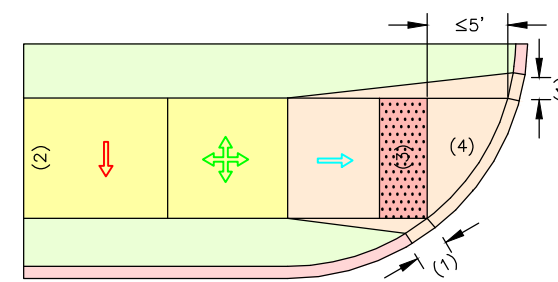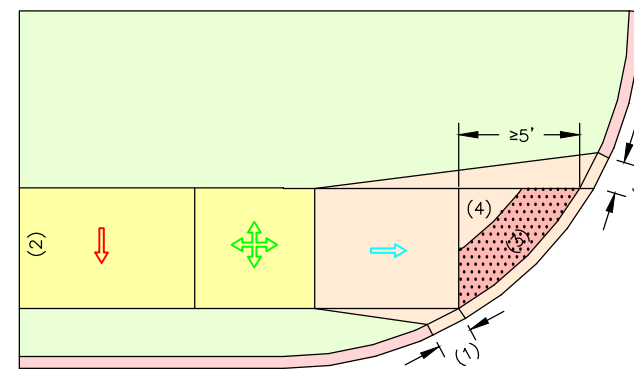

CURB RAMP GENERAL NOTES:

ALL AREAS OF THE PEDESTRIAN ACCESS ROUTE MUST BE COMPLIANT WITH THE "AMERICANS WITH DISABILITIES ACT ACCESSIBILITY GUIDELINES (ADAAG)". EXCEPTIONS MUST BE APPROVED BY THE ENGINEER.

FINISHED SIDEWALK SHALL BE STABLE, SLIP RESISTANT AND SURFACE DOES NOT POND WATER.

SIDEWALK AND RAMP CROSS SLOPES SHALL BE A MINIMUM OF 1.0% TO FACILITATE DRAINAGE AND A MAXIMUM OF 2.0% TO BE USABLE FOR DISABLED INDIVIDUALS.

STORMWATER INLETS, SIGNS, POSTS, MANHOLE COVERS, PULL BOXES AND OTHER ACCESS LIDS SHOULD BE AVOIDED WITHIN THE SIDEWALK. IF SUCH A LOCATION IS NECESSARY, THE FEATURE MUST MEET ADA STANDARDS.

THE RUNNING GRADE OF A SIDEWALK SHALL NOT EXCEED 5.0% UNLESS IT IS MATCHING THE GRADE OF THE ADJACENT ROADWAY.

ALL RAMP SLOPES SHALL NOT HAVE RUNNING SLOPES GREATER THAN 8.33% OR 1V:12H. RAMP LENGTH NOT REQUIRED TO EXCEED 15 FEET.

PEDESTRIAN ACCESS ROUTE SHALL CONTINUE ACROSS DRIVEWAYS.

LANDINGS SHALL BE CONSTRUCTED AT THE TOP AND/OR BOTTOM OF A CURB RAMP WHEREVER A TURNING MOVEMENT OR ACCESS TO PEDESTRIAN PUSH BUTTON IS REQUIRED.

LANDINGS LOCATED IN THE ROADWAY MUST BE COMPLETELY CONTAINED WITHIN THE CROSSWALK.

SIDE FLARES OF CURB RAMP, IN THE PATH OF PEDESTRIAN TRAVEL (TRAVERSABLE), SHALL NOT EXCEED A SLOPE OF 1V:10H. SIDE FLARES OUTSIDE THE PEDESTRIAN PATH (NONTRAVERSABLE) MAY BE 1V:2H OR VERTICAL.

TRANSITION FROM SIDEWALK TO GUTTER TO ROADWAY MUST BE FLUSH.

DETECTABLE WARNING DEVICE (TRUNCATED DOMES) SHALL BE PRE-FORMED AND INSTALLED AS PER MANUFACTURER'S RECOMMENDATIONS, AT PUBLIC STREET INTERSECTIONS AND ANY SIGNALIZED INTERSECTIONS. STAMPED CONCRETE WILL NOT BE ACCEPTED.

THE DETECTABLE WARNING DEVICE SHALL BE RED. TRUNCATED DOMES SHALL SPAN THE FULL WIDTH (WITHIN 2") OF THE RAMP OR LANDING.

DETECTABLE WARNING DOMES SHALL BE ALIGNED PARALLEL TO THE SLOPE WHEN INSTALLED ON A RAMP. WHEN INSTALLED ON A LANDING OR BLENDED TRANSITION, THEY SHALL BE ALIGNED PERPENDICULAR OR RADIAL TO THE BREAK BETWEEN THE RAMP, LANDING OR BLENDED TRANSITION AND THE STREET.

IF CONSTRUCTION OF 5' X 5' LANDING IS NOT FEASIBLE, 4' X 4' LANDING MAY BE USED WITH APPROVAL FROM THE ENGINEER.

RAMP WIDTH MAY BE REDUCED TO 4' WITH APPROVAL OF THE ENGINEER.

CURB RAMP AND INTEGRAL CURBS THAT ARE PART OF RAMP SHALL BE INCLUDED IN THE UNIT BID PRICE FOR CONCRETE SIDEWALK.

THE CONTRACTOR SHALL IDENTIFY THE REMOVAL LIMITS FOR THE SIDEWALK AND CURB. IF THE CONTRACTOR DETERMINES THE REMOVAL LIMITS ARE NOT ADEQUATE TO MEET ADA STANDARDS, THE CONTRACTOR SHALL STOP WORK IMMEDIATELY AND CONSULT THE ENGINEER TO DETERMINE THE BEST SOLUTION.

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REGISTERED PROFESSIONAL ENGINEER
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



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HOLLOWAY ROAD IMPROVEMENTS
FEDERAL PROJECT NO. STP-4939(608)
CITY OF BALLWIN, MISSOURI

DATE	REVISION

DWN BY: K.J.W.
APPD BY: M.D.S.
DATE: JANUARY 2021
SCALE: AS SHOWN
PROJ. NO: SC19-981
DWG. NO: DE-3

LEGEND

-  1.0% MIN., 2.0% MAX. CROSS SLOPE.
-  LANDING AREA. MIN. 5' X 5' WITH 1.0% MIN., 2.0% MAX. SLOPE IN ANY DIRECTION.
-  MAX. RAMP SLOPE IS 1V:12H (8.33%) AND HAVE A CROSS SLOPE OF 1.0% MIN., 2.0% MAX.
-  DETECTABLE WARNING DEVICE. EXTEND 2' IN DIRECTION OF TRAVEL.

KEYED NOTES

- (1) VARIABLE CURB HEIGHT. CURB MAY BE ELIMINATED IF UNNECESSARY AND APPROVED BY THE ENGINEER
- (2) SEE PLAN SHEETS FOR WIDTH. SIDEWALKS AT CURB SHALL BE A MINIMUM OF 6' WIDE AND SIDEWALKS WITH A TREE LAWN SHALL BE A MINIMUM OF 5', WIDE UNLESS OTHERWISE APPROVED BY THE ENGINEER.
- (3) FLARE MAX. SLOPE IS 1V:10H WHEN MEASURED PARALLEL TO CURB LINE.
- (4) CURB HEIGHT BETWEEN THE FLARES MAY RANGE BETWEEN 3" AND 6" AS NECESSARY WITH APPROVAL FROM THE ENGINEER.
- (5) CHAMFER CORNERS AT 45 DEGREE ANGLE.
- (6) 1' WIDE FLARE MAY BE SUBSTITUTED FOR VERTICAL CURB AT THE DISCRETION OF THE ENGINEER FOR NO ADDITION COST.
- (7) DETECTABLE WARNING DEVICES ARE NOT USED ON EVERY CURB RAMP INSTALLED. SEE SITE PLAN FOR LOCATIONS WITH DETECTABLE WARNING DEVICES.

CURB RAMP GENERAL NOTES:

ALL AREAS OF THE PEDESTRIAN ACCESS ROUTE MUST BE COMPLIANT WITH THE "AMERICANS WITH DISABILITIES ACT ACCESSIBILITY GUIDELINES (ADAAG)". EXCEPTIONS MUST BE APPROVED BY THE ENGINEER.

FINISHED SIDEWALK SHALL BE STABLE, SLIP RESISTANT AND SURFACE DOES NOT POND WATER.

SIDEWALK AND RAMP CROSS SLOPES SHALL BE A MINIMUM OF 1.0% TO FACILITATE DRAINAGE AND A MAXIMUM OF 2.0% TO BE USABLE FOR DISABLED INDIVIDUALS.

STORMWATER INLETS, SIGNS, POSTS, MANHOLE COVERS, PULL BOXES AND OTHER ACCESS LIDS SHOULD BE AVOIDED WITHIN THE SIDEWALK. IF SUCH A LOCATION IS NECESSARY, THE FEATURE MUST MEET ADA STANDARDS.

THE RUNNING GRADE OF A SIDEWALK SHALL NOT EXCEED 5.0% UNLESS IT IS MATCHING THE GRADE OF THE ADJACENT ROADWAY.

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PEDESTRIAN ACCESS ROUTE SHALL CONTINUE ACROSS DRIVEWAYS.

LANDINGS SHALL BE CONSTRUCTED AT THE TOP AND/OR BOTTOM OF A CURB RAMP WHEREVER A TURNING MOVEMENT OR ACCESS TO PEDESTRIAN PUSH BUTTON IS REQUIRED.

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DETECTABLE WARNING DOMES SHALL BE ALIGNED PARALLEL TO THE SLOPE WHEN INSTALLED ON A RAMP. WHEN INSTALLED ON A LANDING OR BLENDED TRANSITION, THEY SHALL BE ALIGNED PERPENDICULAR OR RADIAL TO THE BREAK BETWEEN THE RAMP, LANDING OR BLENDED TRANSITION AND THE STREET.



IF CONSTRUCTION OF 5' X 5' LANDING IS NOT FEASIBLE, 4' X 4' LANDING MAY BE USED WITH APPROVAL FROM THE ENGINEER.

RAMP WIDTH MAY BE REDUCED TO 4' WITH APPROVAL OF THE ENGINEER.



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THE CONTRACTOR SHALL IDENTIFY THE REMOVAL LIMITS FOR THE SIDEWALK AND CURB. IF THE CONTRACTOR DETERMINES THE REMOVAL LIMITS ARE NOT ADEQUATE TO MEET ADA STANDARDS, THE CONTRACTOR SHALL STOP WORK IMMEDIATELY AND CONSULT THE ENGINEER TO DETERMINE THE BEST SOLUTION.



21MSD-00086

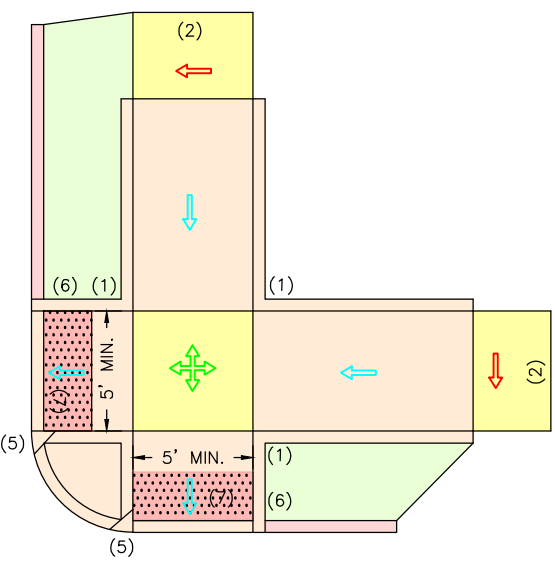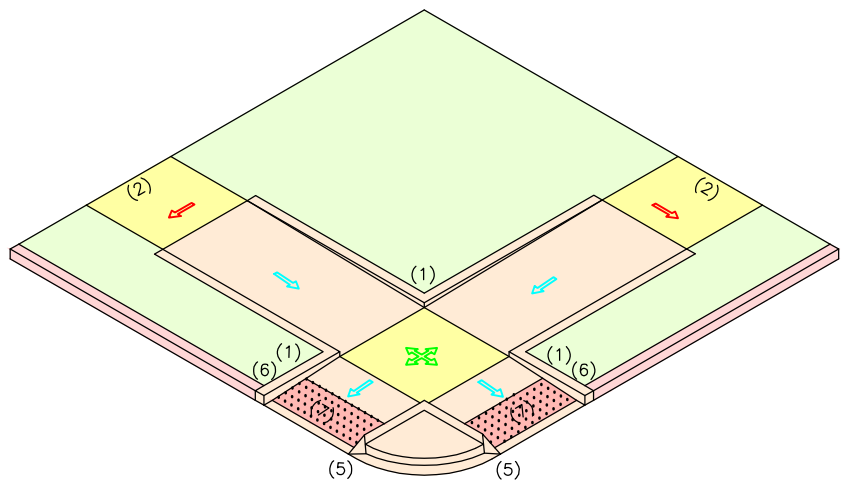

TYPE A6 CURB RAMP
PERPENDICULAR WITH SMALL TREE LAWN
(LESS THAN 6')
 NO SCALE

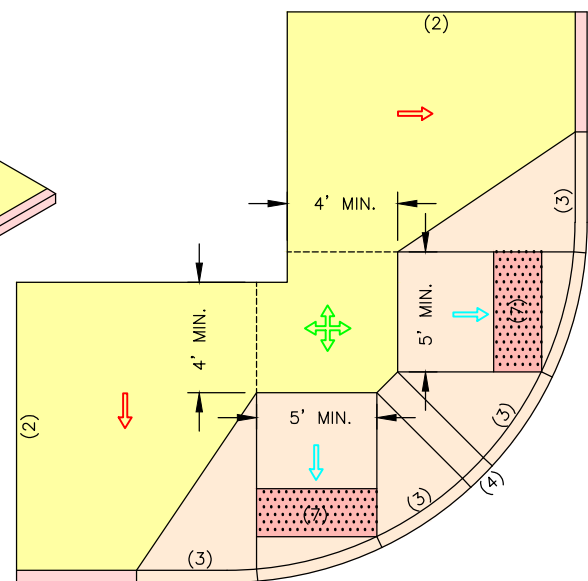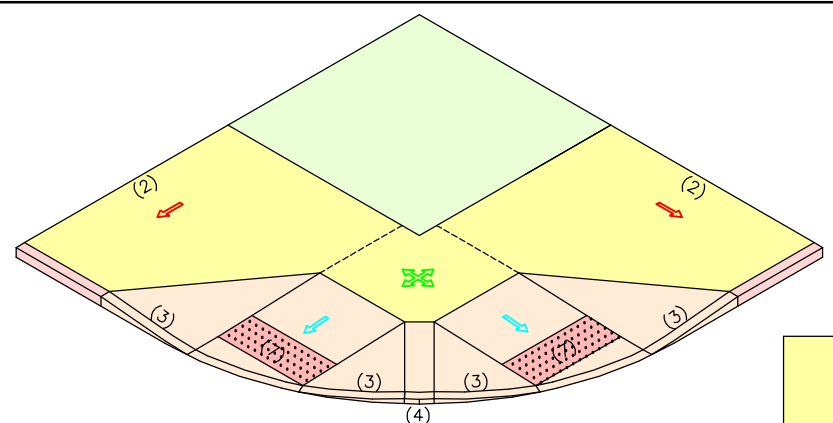

TYPE B1 CURB RAMP
PERPENDICULAR, FOR WIDE
SIDEWALK, NO TREE LAWN
 NO SCALE

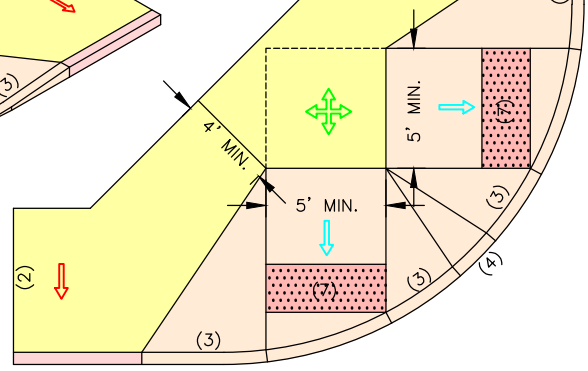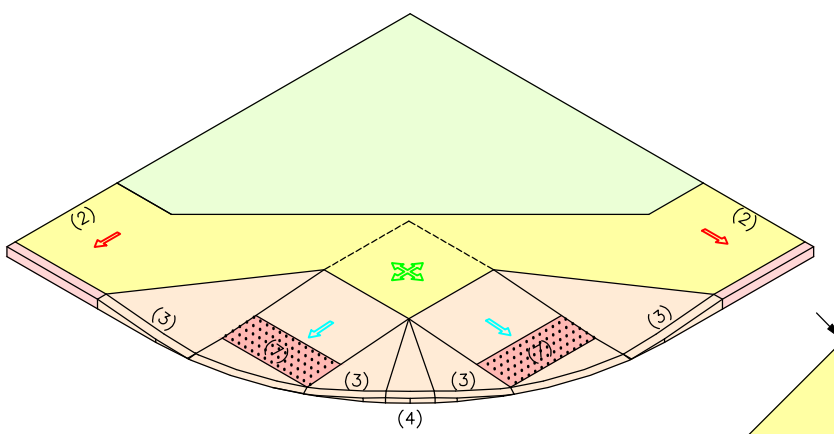

TYPE B2 CURB RAMP
PERPENDICULAR, FOR NARROW
SIDEWALK, NO TREE LAWN
 NO SCALE

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737 RUBBER ROAD
 FENTON, MISSOURI 65026

ENGINEERING CERTIFICATE OF AUTHORITY NUMBER - 2007006937
 LAND SURVEYING CERTIFICATE OF AUTHORITY NUMBER - 2007004629

STATE OF MISSOURI
 KEVIN J. WOLFF P.E.
 PE 2019
 PROFESSIONAL ENGINEERING

1/28/21
 KEVIN J. WOLFF
 NO. PE-200400859
 STATE OF MISSOURI
 REGISTERED PROFESSIONAL ENGINEER
 FOR SC ENGINEERING LLC,
 DBA COCHRAN

THIS SHEET HAS BEEN SIGNED,
 SEALED AND DATED ELECTRONICALLY

HOLLOWAY ROAD IMPROVEMENTS
 FEDERAL PROJECT NO. STP-4939(608)
 CITY OF BALLWIN, MISSOURI

DATE	REVISION

DWN BY: K.J.W. APPD BY: M.D.S.
 DATE: JANUARY 2021
 SCALE: AS SHOWN
 PROJ. NO: SC19-981
 DWG. NO: DE-4

LEGEND

- 1.0% MIN., 2.0% MAX. CROSS SLOPE.
- LANDING AREA. MIN. 5' X 5' WITH 1.0% MIN., 2.0% MAX. SLOPE IN ANY DIRECTION.
- MAX. RAMP SLOPE IS 1V:12H (8.33%) AND HAVE A CROSS SLOPE OF 1.0% MIN., 2.0% MAX.
- DETECTABLE WARNING DEVICE. EXTEND 2' IN DIRECTION OF TRAVEL.

KEYED NOTES

- (1) VARIABLE CURB HEIGHT. CURB MAY BE ELIMINATED IF UNNECESSARY AND APPROVED BY THE ENGINEER.
- (2) TRANSITION AREA SLOPE TO BE MAXIMUM OF 5.0% OR MATCH STREET GRADE. SLOPES SHALL NOT CREATE AN AREA THAT HOLDS WATER.
- (3) SEE PLAN SHEETS FOR WIDTH. SIDEWALKS AT CURB SHALL BE A MINIMUM OF 6' WIDE AND SIDEWALKS WITH A TREE LAWN SHALL BE A MINIMUM OF 5', WIDE UNLESS OTHERWISE APPROVED BY THE ENGINEER.
- (4) FLARE MAX. SLOPE IS 1V:10H WHEN MEASURED PARALLEL TO CURB LINE.
- (5) ENSURE THAT INSIDE EDGE OF CURVED RAMPS MAINTAIN A 1V:12H (8.33%) MAX. SLOPE.
- (6) ENSURE ADEQUATE DRAINAGE OF LANDING AREA. SLOPES SHALL NOT CREATE A LANDING AREA THAT HOLDS WATER.
- (7) 1' WIDE FLARE MAY BE SUBSTITUTED FOR VERTICAL CURB AT THE DISCRETION OF THE ENGINEER FOR NO ADDITION COST.
- (8) DETECTABLE WARNING DEVICES ARE NOT USED ON EVERY CURB RAMP INSTALLED. SEE SITE PLAN FOR LOCATIONS WITH DETECTABLE WARNING DEVICES.

CURB RAMP GENERAL NOTES:

ALL AREAS OF THE PEDESTRIAN ACCESS ROUTE MUST BE COMPLIANT WITH THE "AMERICANS WITH DISABILITIES ACT ACCESSIBILITY GUIDELINES (ADAAG)". EXCEPTIONS MUST BE APPROVED BY THE ENGINEER.

FINISHED SIDEWALK SHALL BE STABLE, SLIP RESISTANT AND SURFACE DOES NOT POND WATER.

SIDEWALK AND RAMP CROSS SLOPES SHALL BE A MINIMUM OF 1.0% TO FACILITATE DRAINAGE AND A MAXIMUM OF 2.0% TO BE USABLE FOR DISABLED INDIVIDUALS.

STORMWATER INLETS, SIGNS, POSTS, MANHOLE COVERS, PULL BOXES AND OTHER ACCESS LIDS SHOULD BE AVOIDED WITHIN THE SIDEWALK. IF SUCH A LOCATION IS NECESSARY, THE FEATURE MUST MEET ADA STANDARDS.

THE RUNNING GRADE OF A SIDEWALK SHALL NOT EXCEED 5.0% UNLESS IT IS MATCHING THE GRADE OF THE ADJACENT ROADWAY.

ALL RAMPS SHALL NOT HAVE RUNNING SLOPES GREATER THAN 8.33% OR 1V:12H. RAMP LENGTH NOT REQUIRED TO EXCEED 15 FEET.

PEDESTRIAN ACCESS ROUTE SHALL CONTINUE ACROSS DRIVEWAYS.

LANDINGS SHALL BE CONSTRUCTED AT THE TOP AND/OR BOTTOM OF A CURB RAMP WHEREVER A TURNING MOVEMENT OR ACCESS TO PEDESTRIAN PUSH BUTTON IS REQUIRED.

LANDINGS LOCATED IN THE ROADWAY MUST BE COMPLETELY CONTAINED WITHIN THE CROSSWALK.

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TRANSITION FROM SIDEWALK TO GUTTER TO ROADWAY MUST BE FLUSH.

DETECTABLE WARNING DEVICE (TRUNCATED DOMES) SHALL BE PRE-FORMED AND INSTALLED AS PER MANUFACTURER'S RECOMMENDATIONS, AT PUBLIC STREET INTERSECTIONS AND ANY SIGNALIZED INTERSECTIONS. STAMPED CONCRETE WILL NOT BE ACCEPTED.

THE DETECTABLE WARNING DEVICE SHALL BE RED. TRUNCATED DOMES SHALL SPAN THE FULL WIDTH (WITHIN 2") OF THE RAMP OR LANDING.

DETECTABLE WARNING DOMES SHALL BE ALIGNED PARALLEL TO THE SLOPE WHEN INSTALLED ON A RAMP. WHEN INSTALLED ON A LANDING OR BLENDED TRANSITION, THEY SHALL BE ALIGNED PERPENDICULAR OR RADIAL TO THE BREAK BETWEEN THE RAMP, LANDING OR BLENDED TRANSITION AND THE STREET.

IF CONSTRUCTION OF 5' X 5' LANDING IS NOT FEASIBLE, 4' X 4' LANDING MAY BE USED WITH APPROVAL FROM THE ENGINEER.

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THE CONTRACTOR SHALL IDENTIFY THE REMOVAL LIMITS FOR THE SIDEWALK AND CURB. IF THE CONTRACTOR DETERMINES THE REMOVAL LIMITS ARE NOT ADEQUATE TO MEET ADA STANDARDS, THE CONTRACTOR SHALL STOP WORK IMMEDIATELY AND CONSULT THE ENGINEER TO DETERMINE THE BEST SOLUTION.

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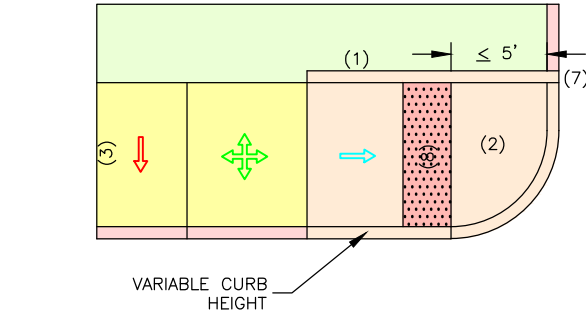
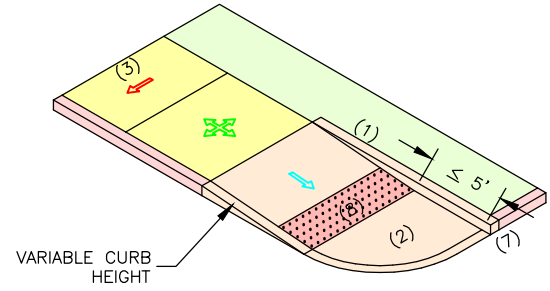
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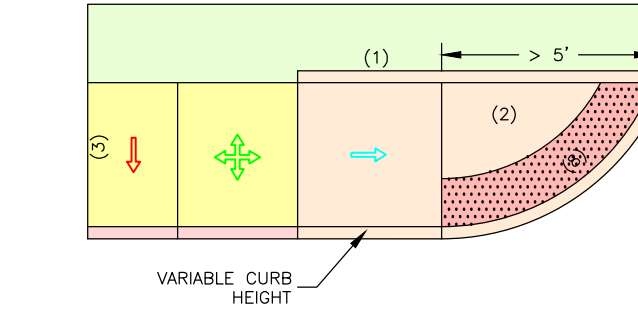
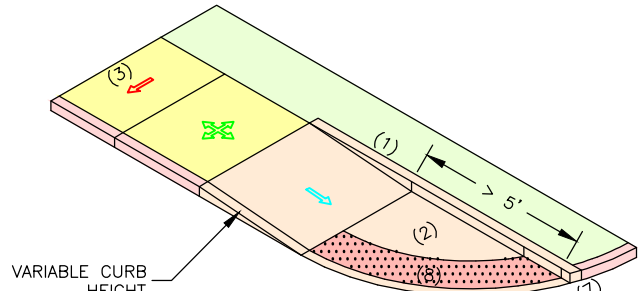
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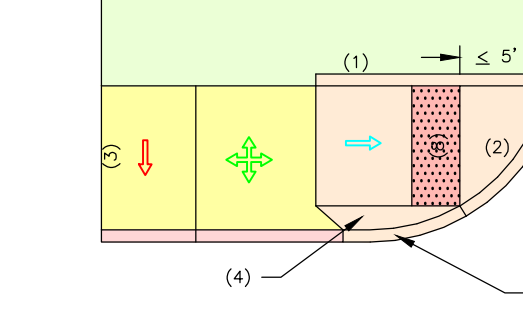
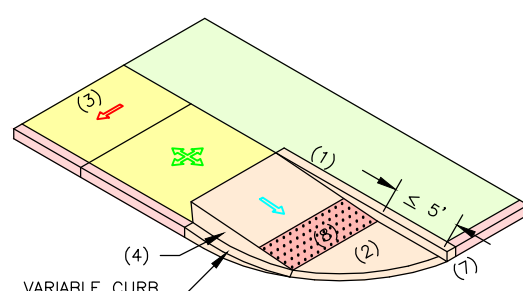
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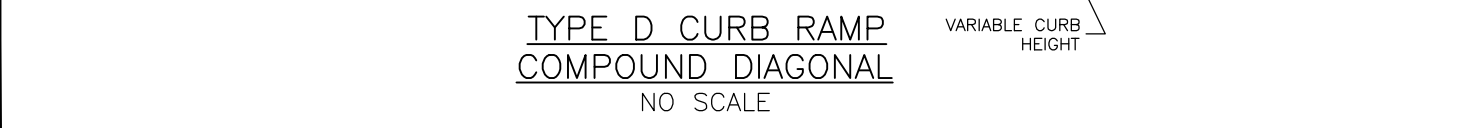
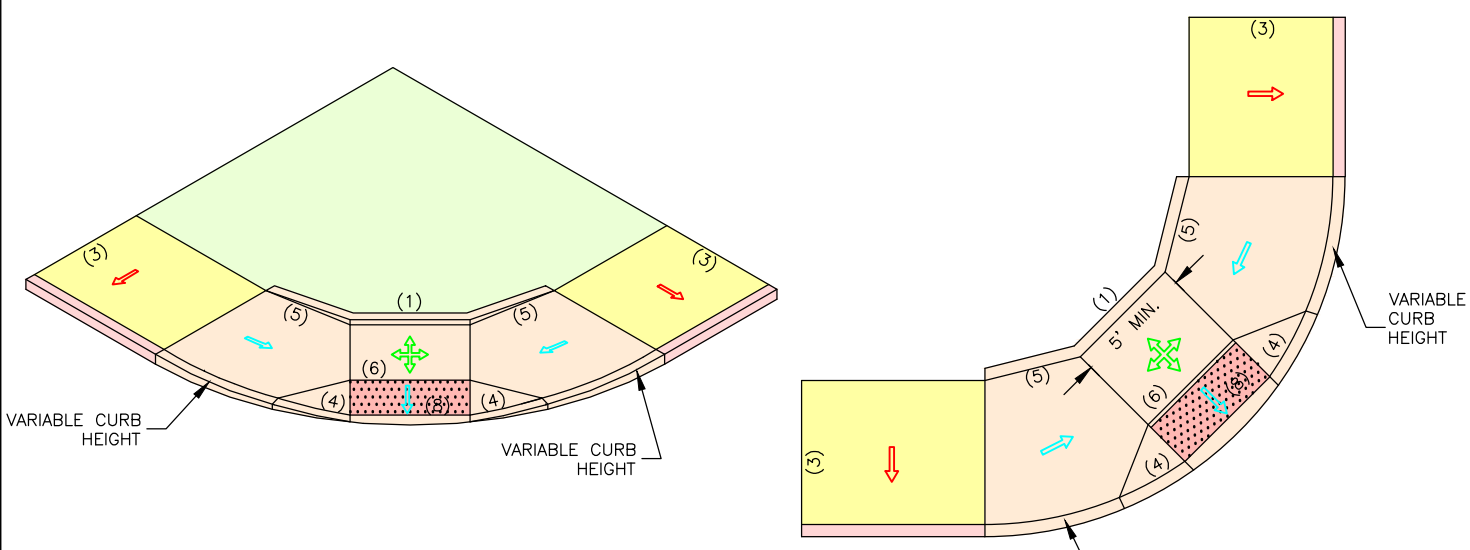
TYPE C1 CURB RAMP
PERPENDICULAR SMALL RADIUS
NO SCALE



TYPE C2 CURB RAMP
PERPENDICULAR LARGE RADIUS
NO SCALE



TYPE C3 CURB RAMP
PERPENDICULAR WITH TRAVERSABLE FLARE
NO SCALE



TYPE D CURB RAMP
COMPOUND DIAGONAL
NO SCALE

Drawing name: U:\SC19-981 Holloway Road, Ballwin, MO\AUTOCAD DRAWINGS\SIDEWALK AND RAMP DETAILS.dwg Tab: DE-5 Plotted on: Feb 09, 2021 - 10:33am Plotted by: knoff





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



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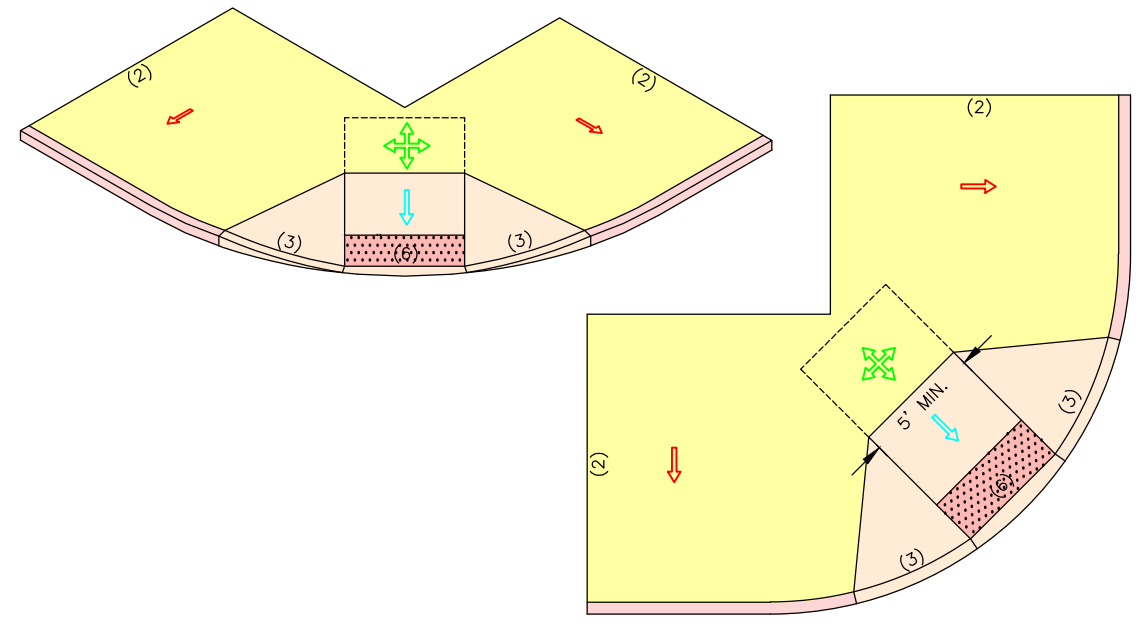
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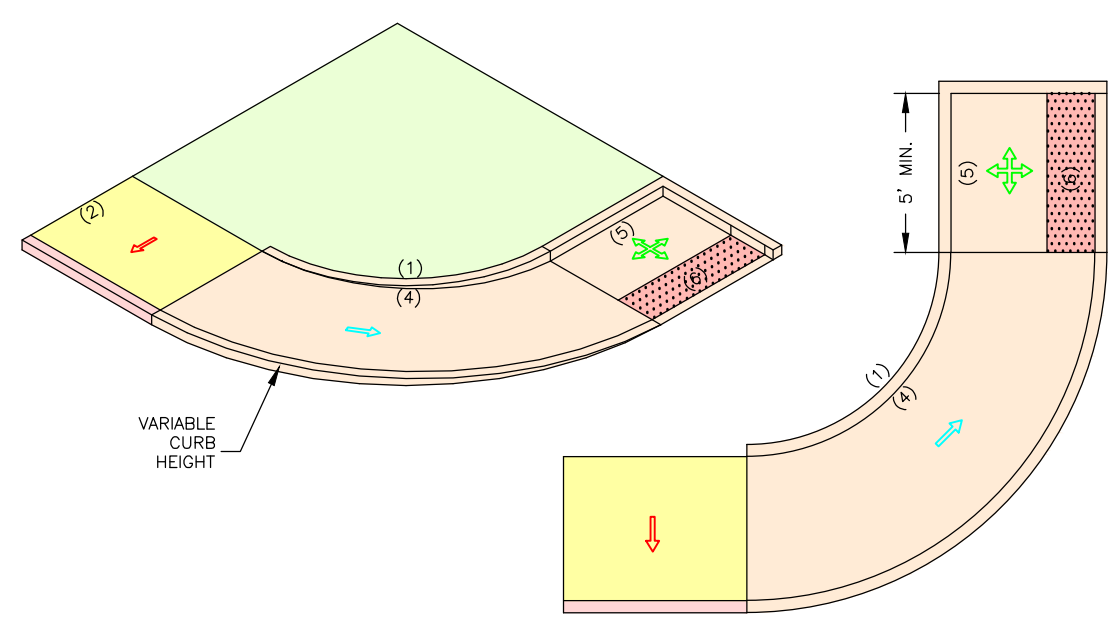
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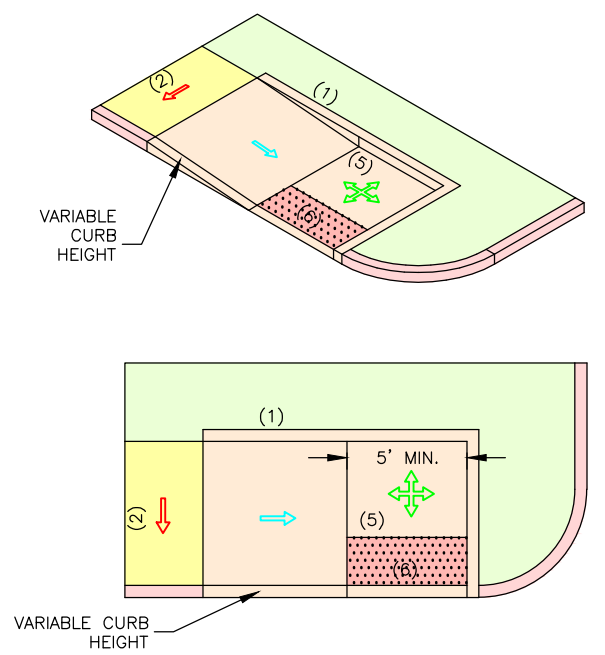
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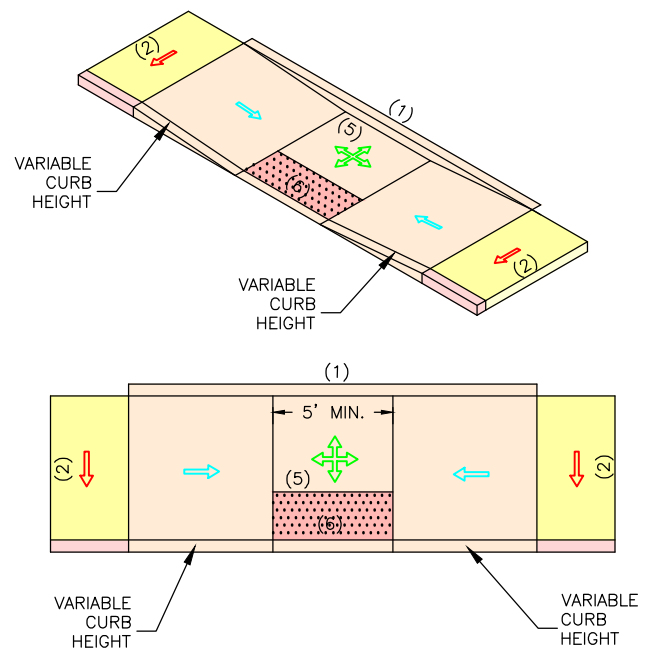
TYPE F2 CURB RAMP
DIAGONAL FOR WIDE SIDEWALKS
NO SCALE



TYPE G1 CURB RAMP
PARALLEL AT INTERSECTION
NO SCALE

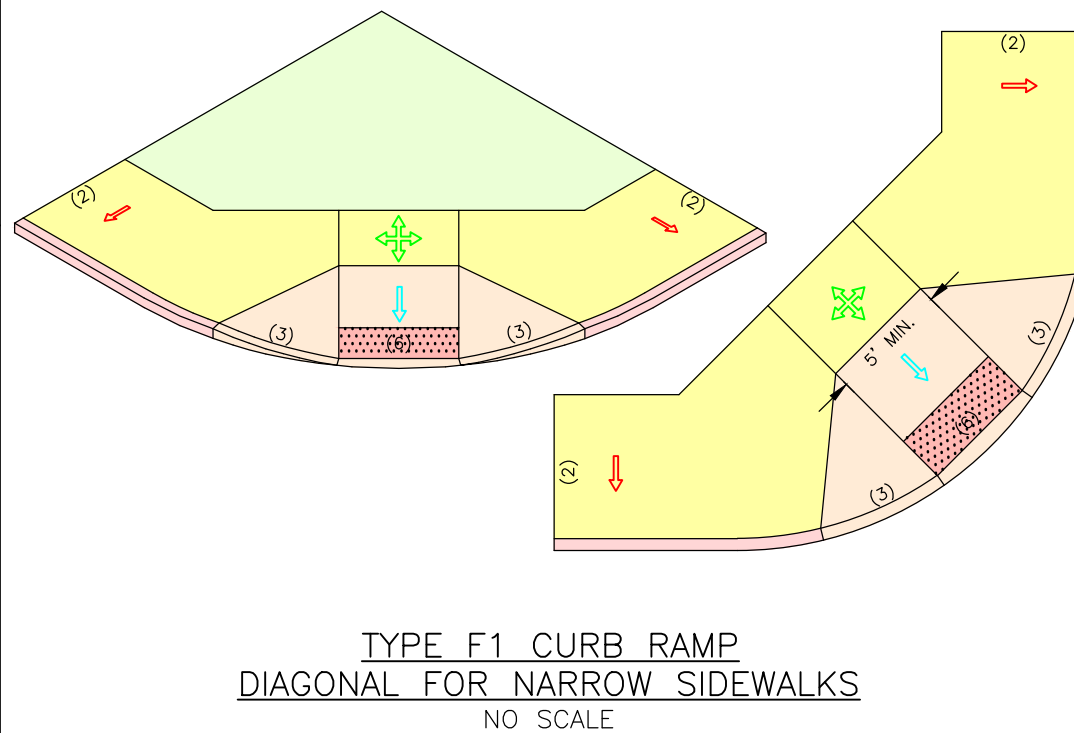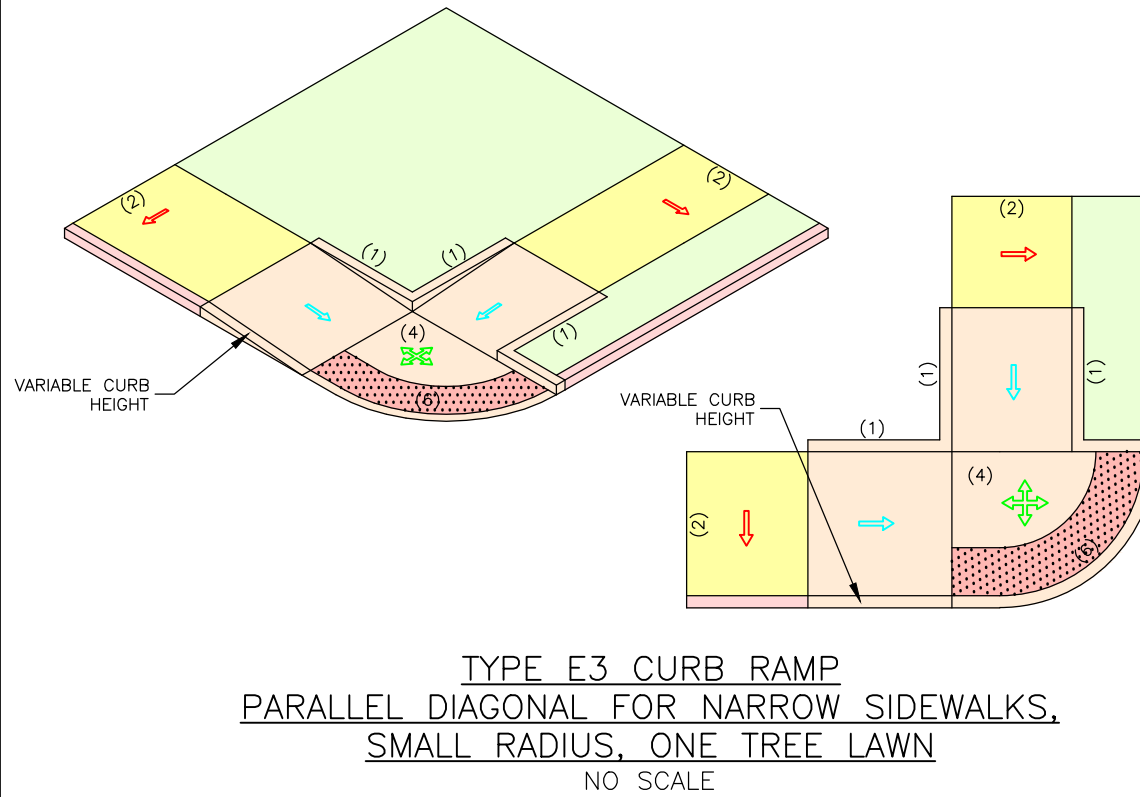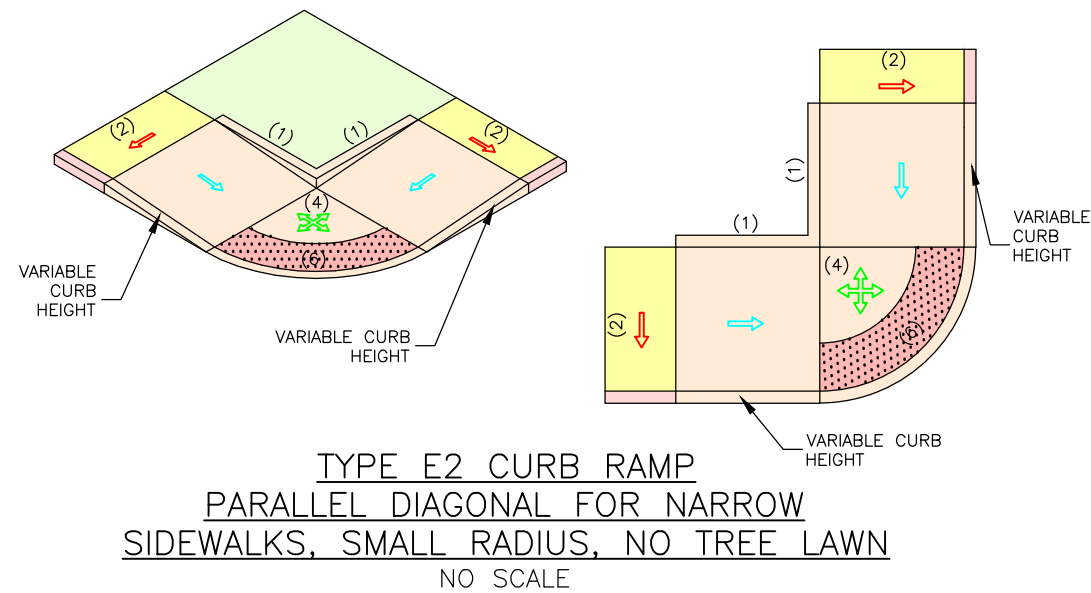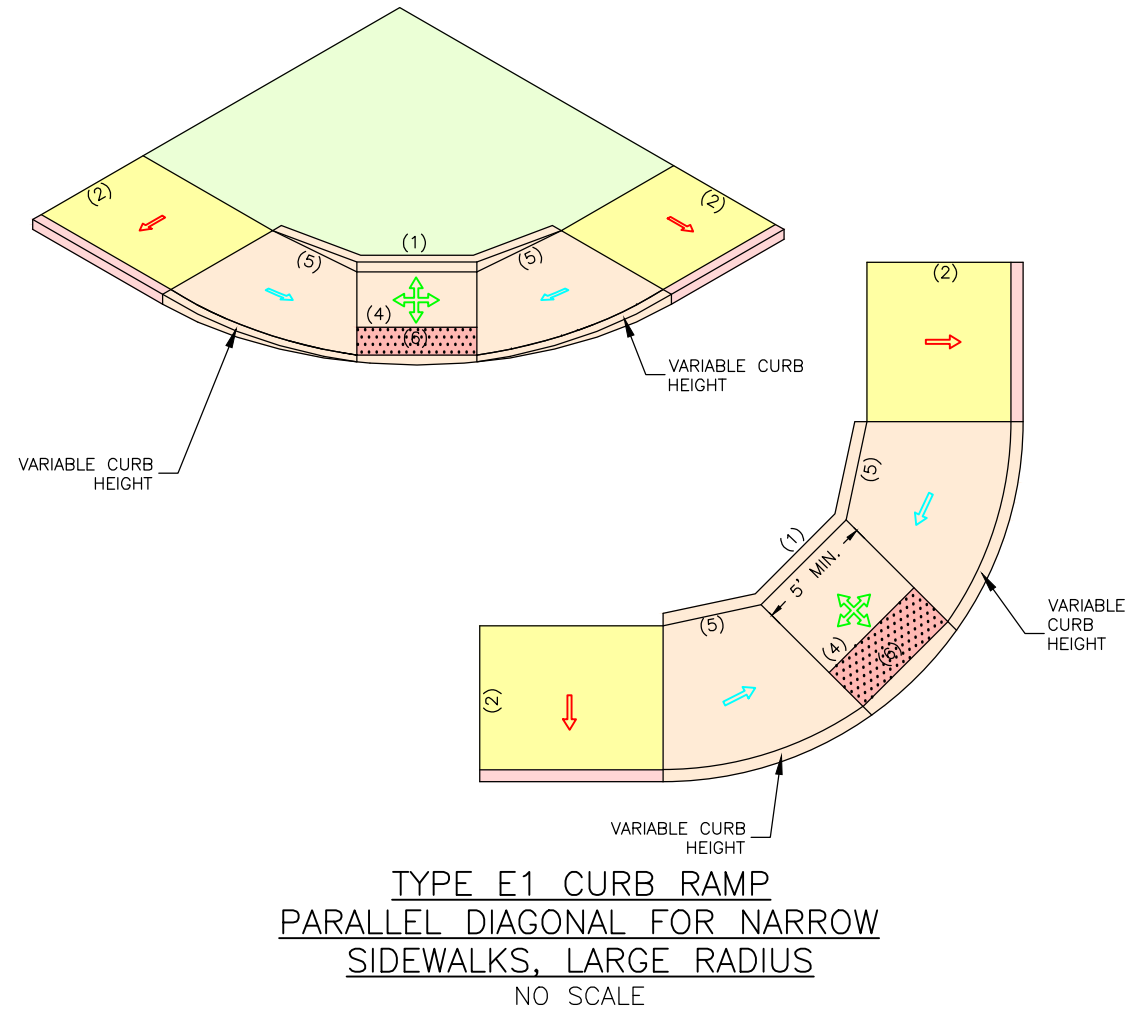

TYPE G2 CURB RAMP
PARALLEL, CHANGING DIRECTION
NO SCALE



TYPE G3 CURB RAMP
PARALLEL, MIDBLOCK
NO SCALE

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



SIDEWALK AND RAMP DETAILS

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PROJ. NO: SC19-981
DWG. NO: DE-7


Drawing name: I:\SC19-981 Holloway Road, Ballwin, MO\AUTOCAD DRAWINGS\SIDEWALK AND RAMP DETAILS.dwg Tab: DE-8 Plotted on: Feb 09, 2021 - 10:33am Plotted by: knloff

LEGEND


-  1.0% MIN., 2.0% MAX. CROSS SLOPE.
-  LANDING AREA. MIN. 5' X 5' WITH 1.0% MIN., 2.0% MAX. SLOPE IN ANY DIRECTION.
-  MAX. RAMP SLOPE IS 1V:12H (8.33%) AND HAVE A CROSS SLOPE OF 1.0% MIN., 2.0% MAX.
-  DETECTABLE WARNING DEVICE. EXTEND 2' IN DIRECTION OF TRAVEL.

KEYED NOTES


- (1) VARIABLE CURB HEIGHT. CURB MAY BE ELIMINATED IF UNNECESSARY AND APPROVED BY THE ENGINEER.
- (2) SEE PLAN SHEETS FOR WIDTH. SIDEWALKS AT CURB SHALL BE A MINIMUM OF 6' WIDE AND SIDEWALKS WITH A TREE LAWN SHALL BE A MINIMUM OF 5', WIDE UNLESS OTHERWISE APPROVED BY THE ENGINEER.
- (3) FLARE MAX. SLOPE IS 1V:10H WHEN MEASURED PARALLEL TO CURB LINE.
- (4) ENSURE ADEQUATE DRAINAGE OF LANDING AREA. SLOPES SHALL NOT CREATE A LANDING AREA THAT HOLDS WATER.
- (5) 1" WIDE FLARE MAY BE SUBSTITUTED FOR VERTICAL CURB AT THE DISCRETION OF THE ENGINEER FOR NO ADDITIONAL COST.
- (6) DETECTABLE WARNING DEVICES ARE NOT USED ON EVERY CURB RAMP INSTALLED. SEE SITE PLAN FOR LOCATIONS WITH DETECTABLE WARNING DEVICES.

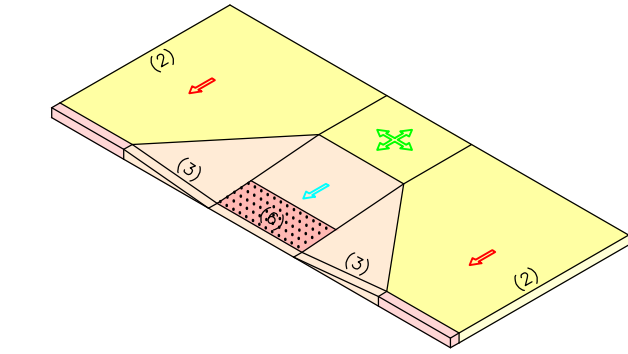


**TYPE H CURB RAMP
PERPENDICULAR FOR WIDE
SIDEWALK, MIDBLOCK**
NO SCALE

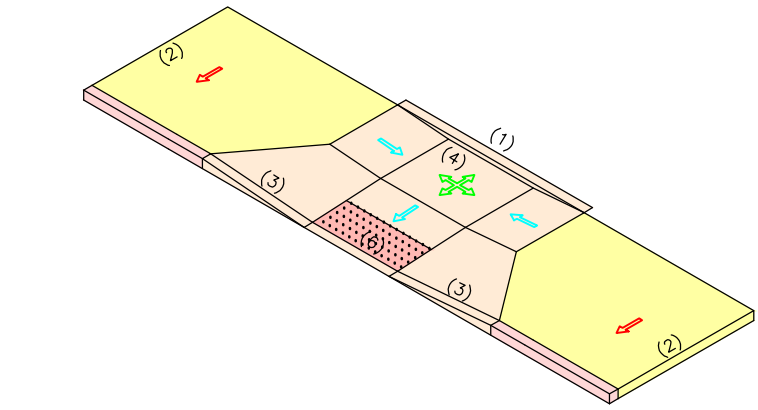


**TYPE I CURB RAMP
COMBINATION (PARALLEL AND PERPENDICULAR),
MIDBLOCK**
NO SCALE

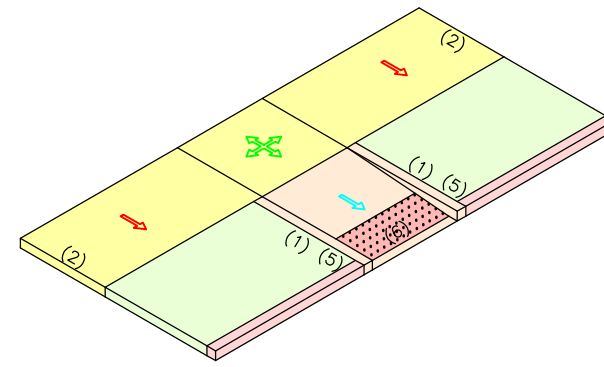

**TYPE J2 CURB RAMP
PERPENDICULAR WITH TREE LAWN
(6' OR GREATER), MIDBLOCK**
NO SCALE

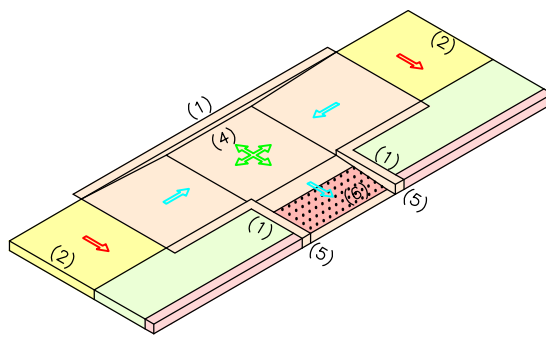

**TYPE J1 CURB RAMP
PERPENDICULAR WITH TREE LAWN
(LESS THAN 6'), MIDBLOCK**
NO SCALE

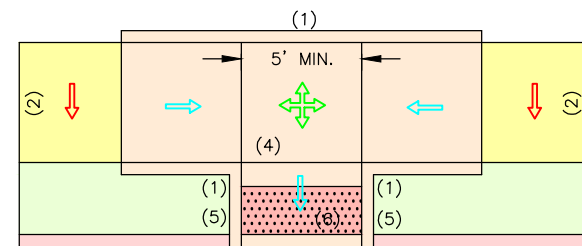

CURB RAMP GENERAL NOTES:

ALL AREAS OF THE PEDESTRIAN ACCESS ROUTE MUST BE COMPLIANT WITH THE "AMERICANS WITH DISABILITIES ACT ACCESSIBILITY GUIDELINES (ADAAG)". EXCEPTIONS MUST BE APPROVED BY THE ENGINEER.

FINISHED SIDEWALK SHALL BE STABLE, SLIP RESISTANT AND SURFACE DOES NOT POND WATER.

SIDEWALK AND RAMP CROSS SLOPES SHALL BE A MINIMUM OF 1.0% TO FACILITATE DRAINAGE AND A MAXIMUM OF 2.0% TO BE USABLE FOR DISABLED INDIVIDUALS.

STORMWATER INLETS, SIGNS, POSTS, MANHOLE COVERS, PULL BOXES AND OTHER ACCESS LIDS SHOULD BE AVOIDED WITHIN THE SIDEWALK. IF SUCH A LOCATION IS NECESSARY, THE FEATURE MUST MEET ADA STANDARDS.

THE RUNNING GRADE OF A SIDEWALK SHALL NOT EXCEED 5.0% UNLESS IT IS MATCHING THE GRADE OF THE ADJACENT ROADWAY.

ALL RAMP SLOPES SHALL NOT HAVE RUNNING SLOPES GREATER THAN 8.33% OR 1V:12H. RAMP LENGTH NOT REQUIRED TO EXCEED 15 FEET.

PEDESTRIAN ACCESS ROUTE SHALL CONTINUE ACROSS DRIVEWAYS.

LANDINGS SHALL BE CONSTRUCTED AT THE TOP AND/OR BOTTOM OF A CURB RAMP WHEREVER A TURNING MOVEMENT OR ACCESS TO PEDESTRIAN PUSH BUTTON IS REQUIRED.

LANDINGS LOCATED IN THE ROADWAY MUST BE COMPLETELY CONTAINED WITHIN THE CROSSWALK.

SIDE FLARES OF CURB RAMPS, IN THE PATH OF PEDESTRIAN TRAVEL (TRAVERSABLE), SHALL NOT EXCEED A SLOPE OF 1V:10H. SIDE FLARES OUTSIDE THE PEDESTRIAN PATH (NONTRAVERSABLE) MAY BE 1V:2H OR VERTICAL.

TRANSITION FROM SIDEWALK TO GUTTER TO ROADWAY MUST BE FLUSH.

DETECTABLE WARNING DEVICE (TRUNCATED DOMES) SHALL BE PRE-FORMED AND INSTALLED AS PER MANUFACTURER'S RECOMMENDATIONS, AT PUBLIC STREET INTERSECTIONS AND ANY SIGNALIZED INTERSECTIONS. STAMPED CONCRETE WILL NOT BE ACCEPTED.

THE DETECTABLE WARNING DEVICE SHALL BE RED. TRUNCATED DOMES SHALL SPAN THE FULL WIDTH (WITHIN 2") OF THE RAMP OR LANDING.

DETECTABLE WARNING DOMES SHALL BE ALIGNED PARALLEL TO THE SLOPE WHEN INSTALLED ON A RAMP. WHEN INSTALLED ON A LANDING OR BLENDED TRANSITION, THEY SHALL BE ALIGNED PERPENDICULAR OR RADIAL TO THE BREAK BETWEEN THE RAMP, LANDING OR BLENDED TRANSITION AND THE STREET.

IF CONSTRUCTION OF 5' X 5' LANDING IS NOT FEASIBLE, 4' X 4' LANDING MAY BE USED WITH APPROVAL FROM THE ENGINEER.

RAMP WIDTH MAY BE REDUCED TO 4' WITH APPROVAL OF THE ENGINEER.

CURB RAMPS AND INTEGRAL CURBS THAT ARE PART OF RAMPS SHALL BE INCLUDED IN THE UNIT BID PRICE FOR CONCRETE SIDEWALK.

THE CONTRACTOR SHALL IDENTIFY THE REMOVAL LIMITS FOR THE SIDEWALK AND CURB. IF THE CONTRACTOR DETERMINES THE REMOVAL LIMITS ARE NOT ADEQUATE TO MEET ADA STANDARDS, THE CONTRACTOR SHALL STOP WORK IMMEDIATELY AND CONSULT THE ENGINEER TO DETERMINE THE BEST SOLUTION.

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LAND SURVEYING CERTIFICATE OF AUTHORITY NUMBER - 2007004529

737 RUDDER ROAD
FENTON, MISSOURI 63026

STATE OF MISSOURI
KEVIN J. WOLFF, P.E.
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

1/28/21
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HOLLOWAY ROAD IMPROVEMENTS
FEDERAL PROJECT NO. STP-4939(608)
CITY OF BALLWIN, MISSOURI

SIDEWALK AND RAMP DETAILS

DATE:	REVISION:
DWN. BY:	APPD. BY:
K.J.W.	M.D.S.
DATE:	
JANUARY 2021	
SCALE:	
AS SHOWN	
PROJ. NO.:	
SC19-981	
DWG. NO.:	
DE-8	

LEGEND


-  1.50% SLOPE ±0.50%
-  MAX. SLOPE 1V:12H (8.33%)

KEYED NOTES


- (1) LENGTH OF RAMP TO BE 5' TO 15', DEPENDENT ON SLOPE.
- (2) MIN. GRADE 1%, MAX. GRADE OF 12%.
- (3) MAX. SLOPE 1:10, MEASURED PARALLEL TO THE CURB LINE.
- (4) MAXIMUM PERCENT CHANGE FOR A SAG GRADE BREAK IS 12%. MAXIMUM PERCENT CHANGE FOR A CREST GRADE BREAK IS 8%.
- (5) MAINTAIN SLOPE FOR A MINIMUM OF 10' BEFORE ANOTHER GRADE CHANGE.
- (6) CONTRACTOR TO MATCH EXISTING ELEVATION OF DRIVEWAY AS CLOSE AS POSSIBLE WHILE PROVIDING AN ADA COMPLIANT SIDEWALK.

NOTES


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- 2. TOOLED JOINTS ARE REQUIRED AT ALL SLOPE BREAK LINES.
- 3. CURB, GUTTER AND SIDEWALK TYPES VARY. SEE SITE PLANS FOR EXACT TYPES.
- 4. SAW CUT LOCATIONS SHOWN ON PLANS ARE APPROXIMATE. CONSULT WITH ENGINEER BEFORE SAW CUT/REMOVALS.
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- 6. AT ENGINEER'S DIRECTION, CROSS SLOPE OF SIDEWALKS AT DRIVEWAY APPROACHES MAY SLOPE AWAY FROM THE STREET.
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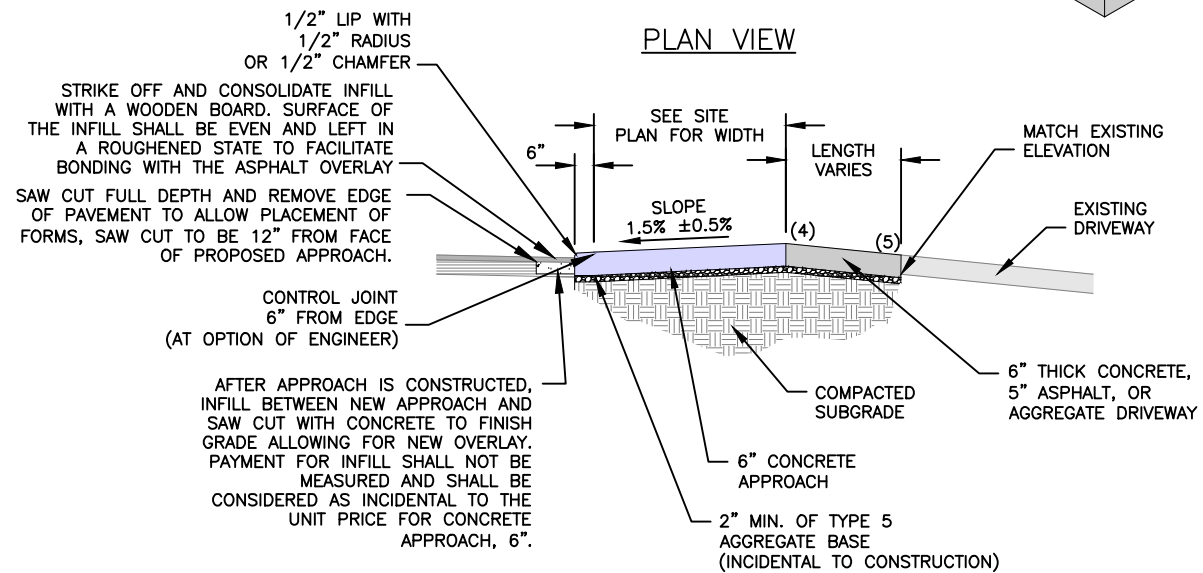
PLAN VIEW

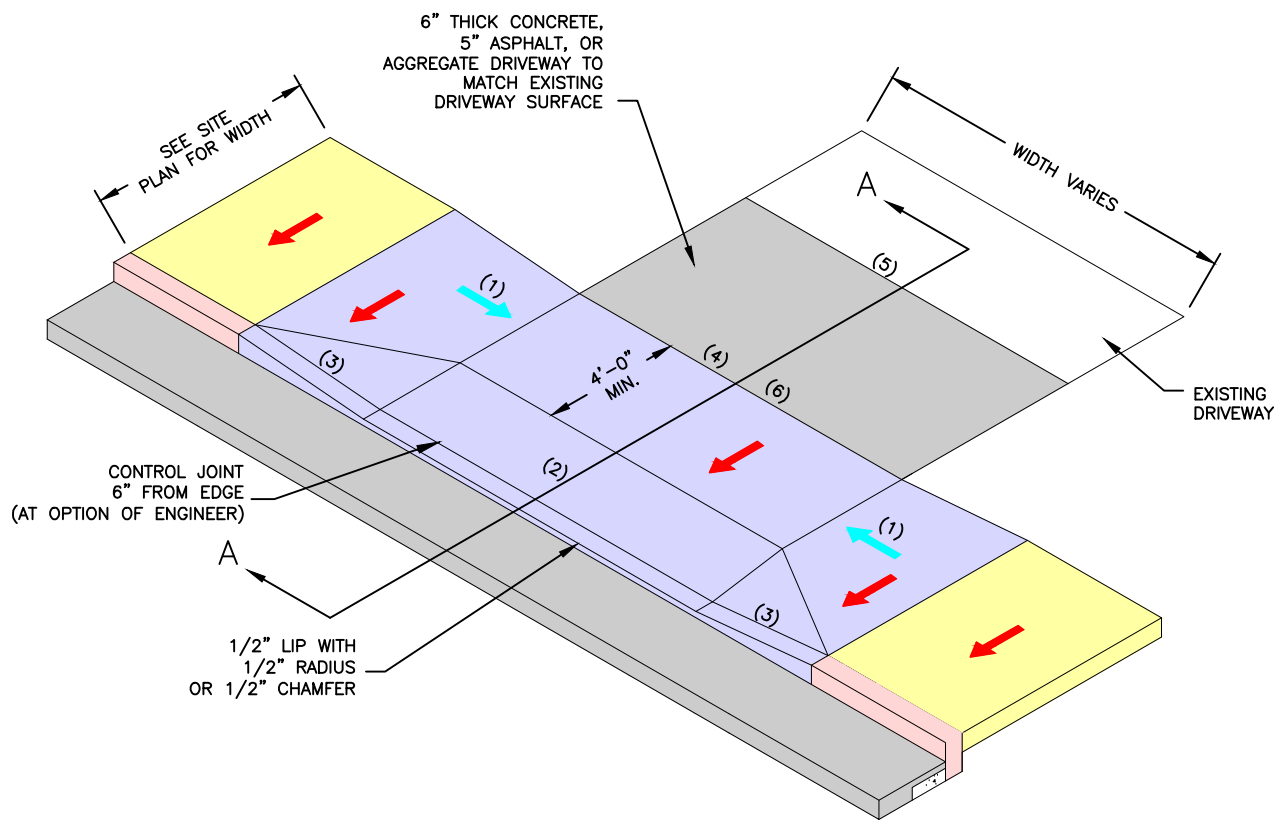

CONCRETE APPROACH (TYPE 1)
NO SCALE

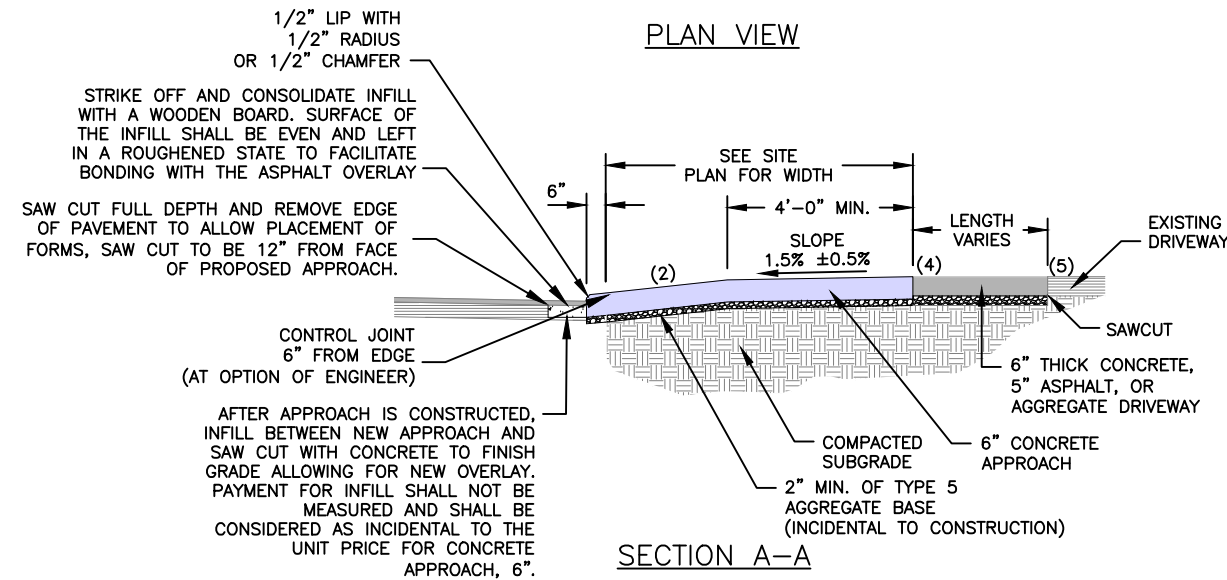

PLAN VIEW

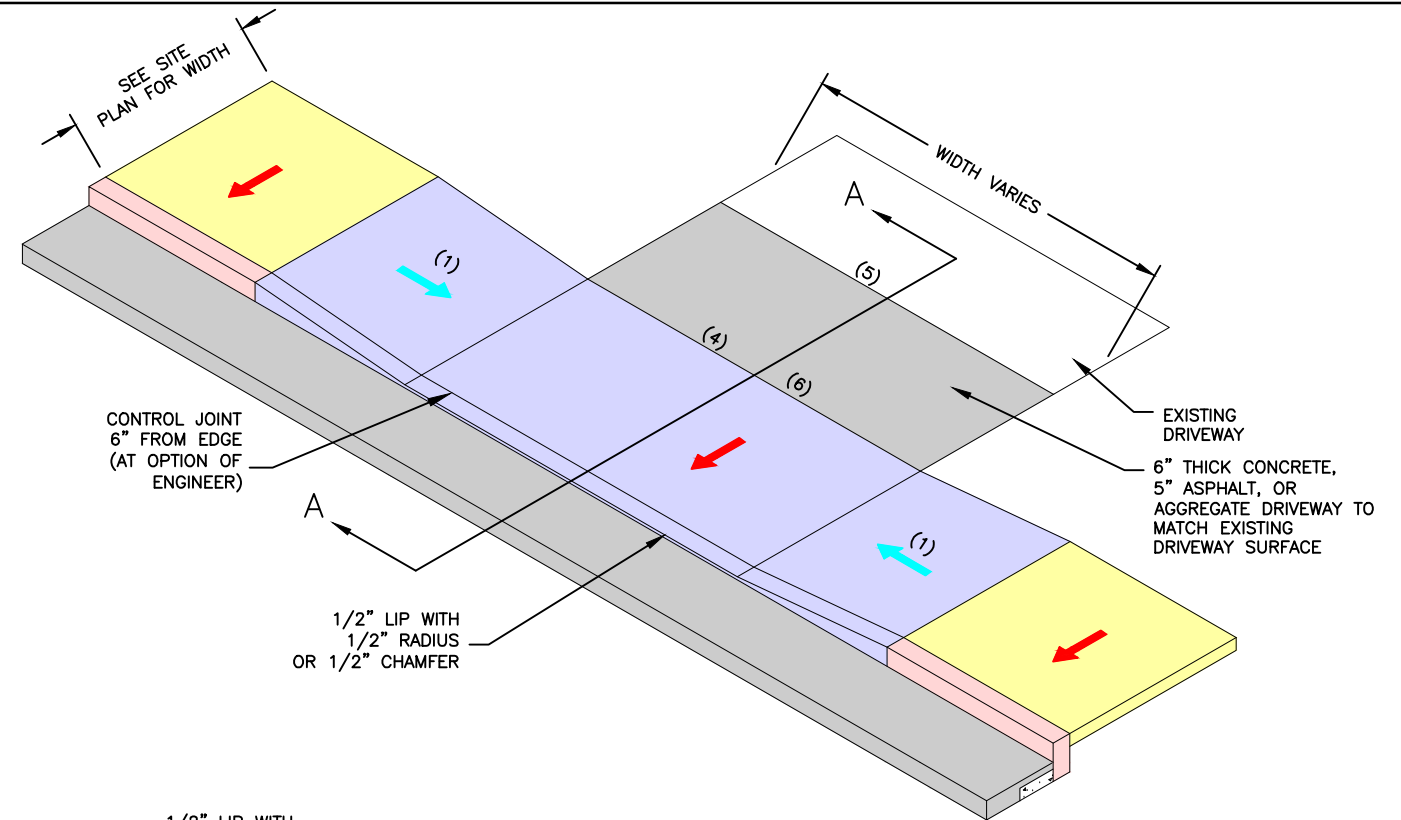

SECTION A-A

CONCRETE APPROACH (TYPE 2)
NO SCALE

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STATE OF MISSOURI

KEVIN J. WOLFF, P.E.
Professional Engineer
No. PE-200400889
STATE OF MISSOURI

1/28/21

REGISTERED PROFESSIONAL ENGINEER
FOR SC ENGINEERING LLC,
DBA COCHRAN

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

HOLLOWAY ROAD IMPROVEMENTS
FEDERAL PROJECT NO. STP-4939(608)
CITY OF BALLWIN, MISSOURI

DRIVEWAY DETAILS

DATE:	REVISION:
DWN BY:	APPD BY:
DATE:	DATE:
SCALE:	AS SHOWN
PROJ. NO.:	SC19-981
DWG. NO.:	DE-9

Drawing name: I:\SC19-981 Holloway Road, Ballwin, MO\AUTOCAD DRAWINGS\DRIVEWAY DETAILS.dwg Tab: DE-9 Plotted on: Feb 09, 2021 - 10:33am Plotted by: knloff

LEGEND


-  1.50% SLOPE ±0.50%
-  MAX. SLOPE 1V:12H (8.33%)

KEYED NOTES


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- (2) MAXIMUM PERCENT CHANGE FOR A SAG GRADE BREAK IS 12%. MAXIMUM PERCENT CHANGE FOR A CREST GRADE BREAK IS 8%.
- (3) MAINTAIN SLOPE FOR A MINIMUM OF 10' BEFORE ANOTHER GRADE CHANGE.

NOTES

- 1. IF TRANSITION OF DRIVEWAY BEYOND APPROACH IS NEEDED, CONTRACTOR SHALL REMOVE AND REPLACE EXISTING DRIVEWAY TO NEAREST JOINT OR AS DIRECTED BY THE ENGINEER, TO BE PAID BY UNIT BID PRICE FOR 6" CONCRETE DRIVEWAY, 5" ASPHALT DRIVEWAY OR AGGREGATE DRIVEWAY AS SHOWN ON THE SITE PLANS.
- 2. TOOLED JOINTS ARE REQUIRED AT ALL SLOPE BREAK LINES.
- 3. CURB, GUTTER AND SIDEWALK TYPES VARY. SEE SITE PLANS FOR EXACT TYPES.
- 4. SAW CUT LOCATIONS SHOWN ON PLANS ARE APPROXIMATE. CONSULT WITH ENGINEER BEFORE SAW CUT/REMOVALS.
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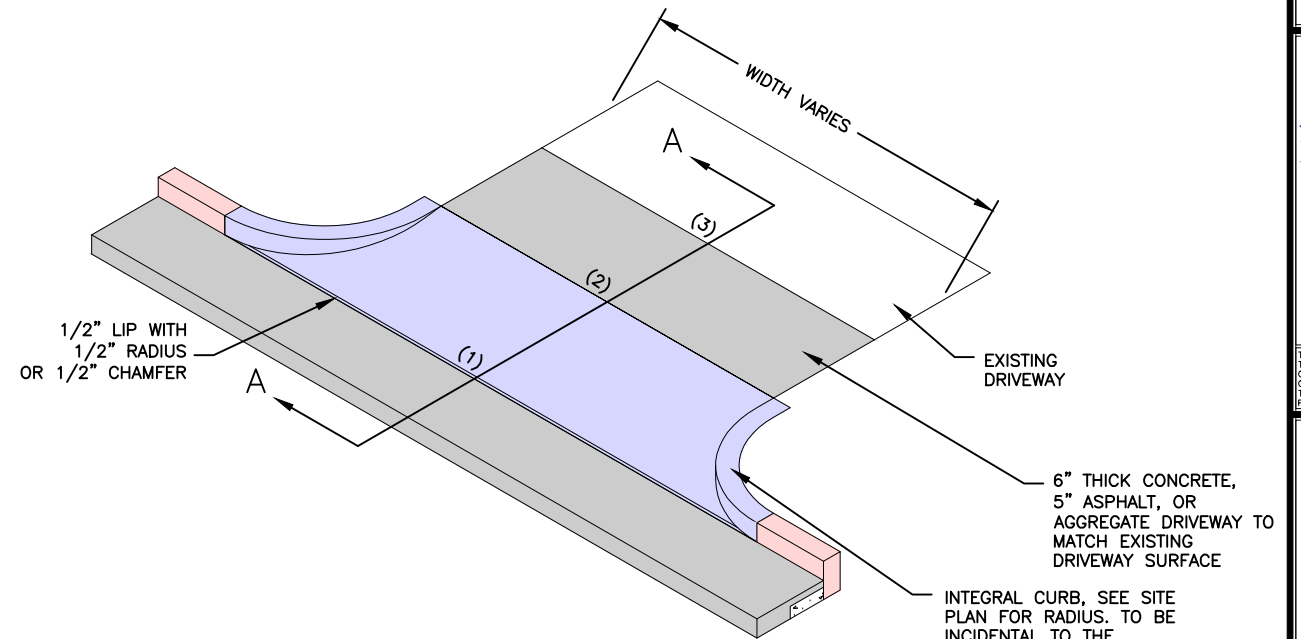


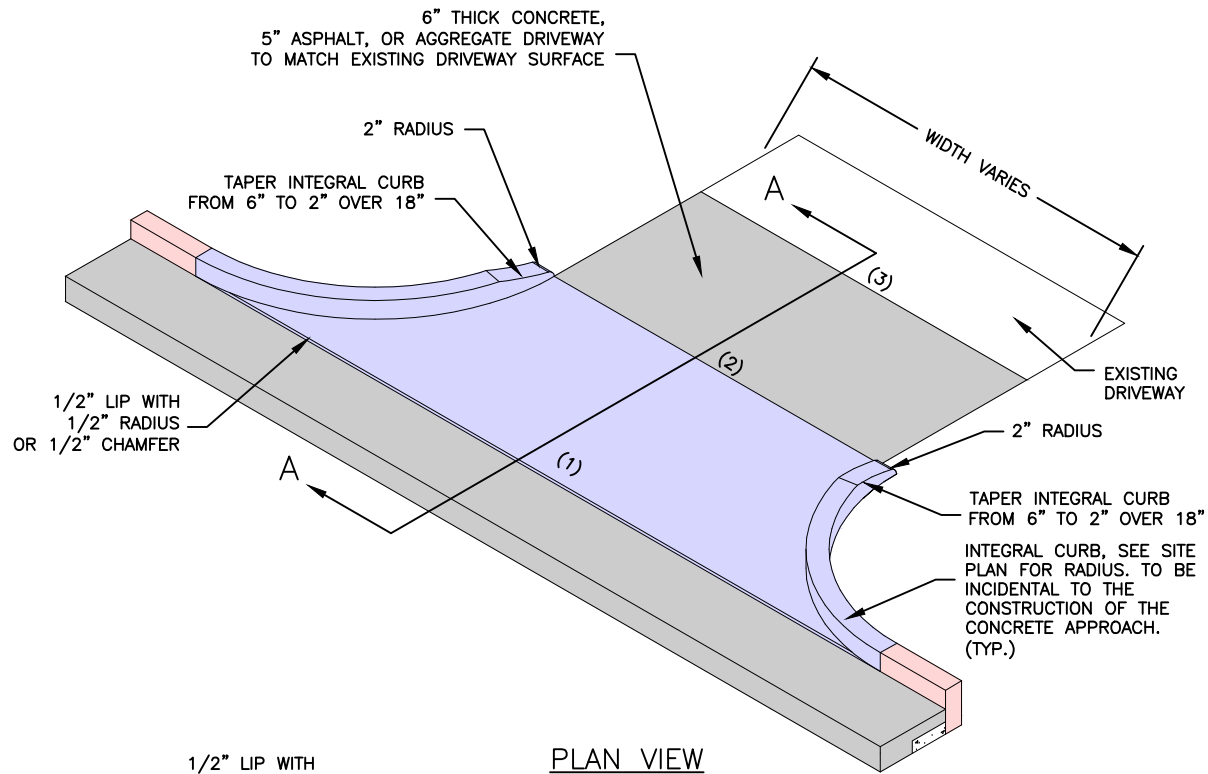PLAN VIEW

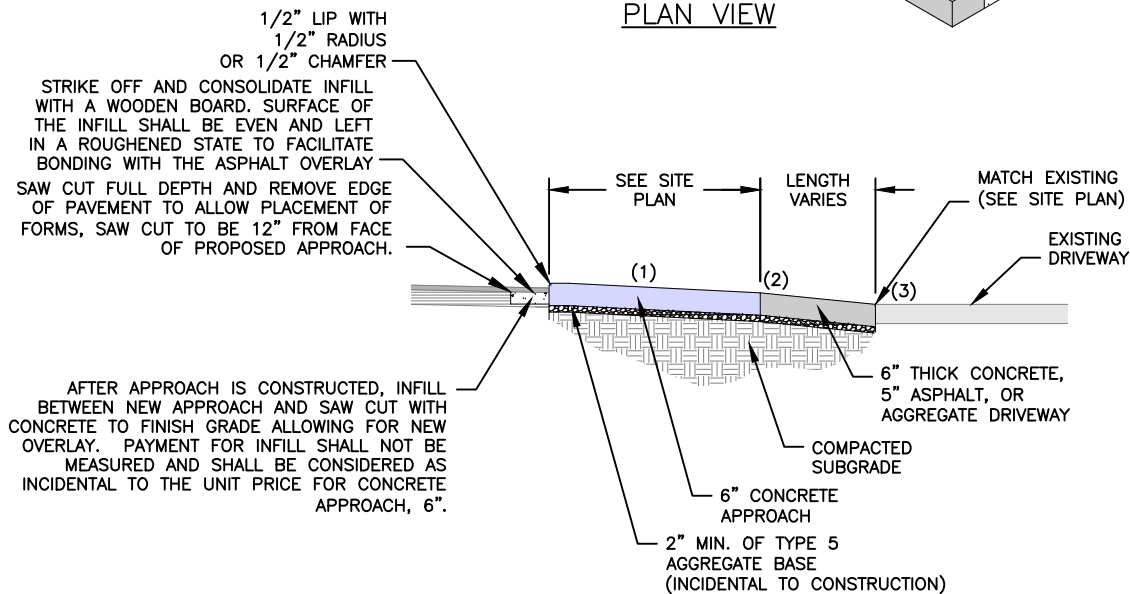


SECTION A-A

CONCRETE APPROACH (TYPE 3)
NO SCALE



PLAN VIEW

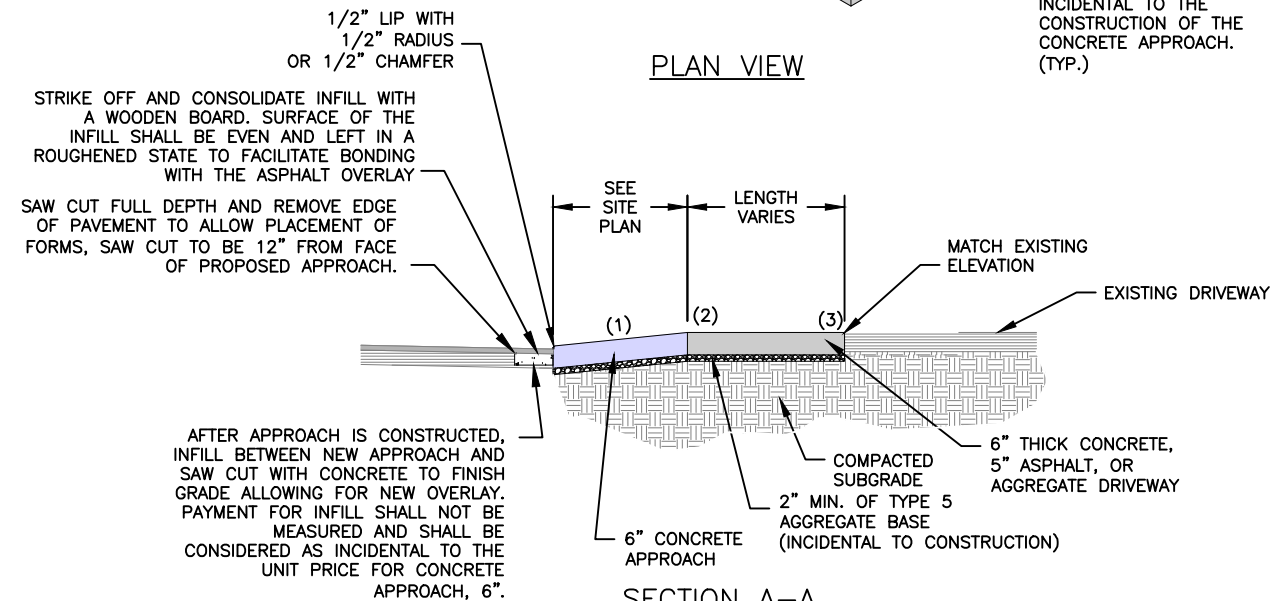

SECTION A-A

CONCRETE APPROACH (TYPE 4)
NO SCALE

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STATE OF MISSOURI

KEVIN J. WOLFF, P.E.

1/28/21

NO. PE-200400889
STATE OF MISSOURI
REGISTERED PROFESSIONAL ENGINEER
FOR SC ENGINEERING LLC, DBA COCHRAN

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HOLLOWAY ROAD IMPROVEMENTS
FEDERAL PROJECT NO. STP-4939(608)
CITY OF BALLWIN, MISSOURI

DATE:	REVISION:
DWN. BY:	APPD. BY:
DATE:	DATE:
SCALE:	SCALE:
PROJ. NO.:	PROJ. NO.:
DWG. NO.:	DWG. NO.:
JANUARY 2021	
AS SHOWN	
SC19-981	
DE-10	

Drawing name: U:\SC19-981 Holloway Road, Ballwin, MO\AUTOCAD DRAWINGS\DRIVEWAY DETAILS.dwg Tab: DE-10 Plotted on: Feb 09, 2021 - 10:33am Plotted by: kwcliff

LEGEND

- 1.50% SLOPE ±0.50%
- MAX. SLOPE 1V:12H (8.33%)



KEYED NOTES

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- (5) CONTRACTOR TO MATCH EXISTING ELEVATION OF DRIVEWAY AS CLOSE AS POSSIBLE WHILE PROVIDING AN ADA COMPLIANT SIDEWALK.
- (6) VARIABLE HEIGHT CURB. CURB MAY BE ELIMINATED IF UNNECESSARY AND APPROVED BY THE ENGINEER. IF ELIMINATED, RADIAL CURB SHALL TAPER FLUSH WITH SIDEWALK.



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FLARED APPROACH AND INTEGRAL CURB WITH RADIUS SHOWN IS FOR REFERENCE PURPOSES ONLY. DO NOT CONSTRUCT BOTH TYPES FOR ONE APPROACH UNLESS INSTRUCTED TO DO SO BY THE ENGINEER. SEE SITE PLANS FOR EXACT METHOD OF CONSTRUCTING APPROACH CONCRETE



CONCRETE APPROACH (TYPE 5)
NO SCALE

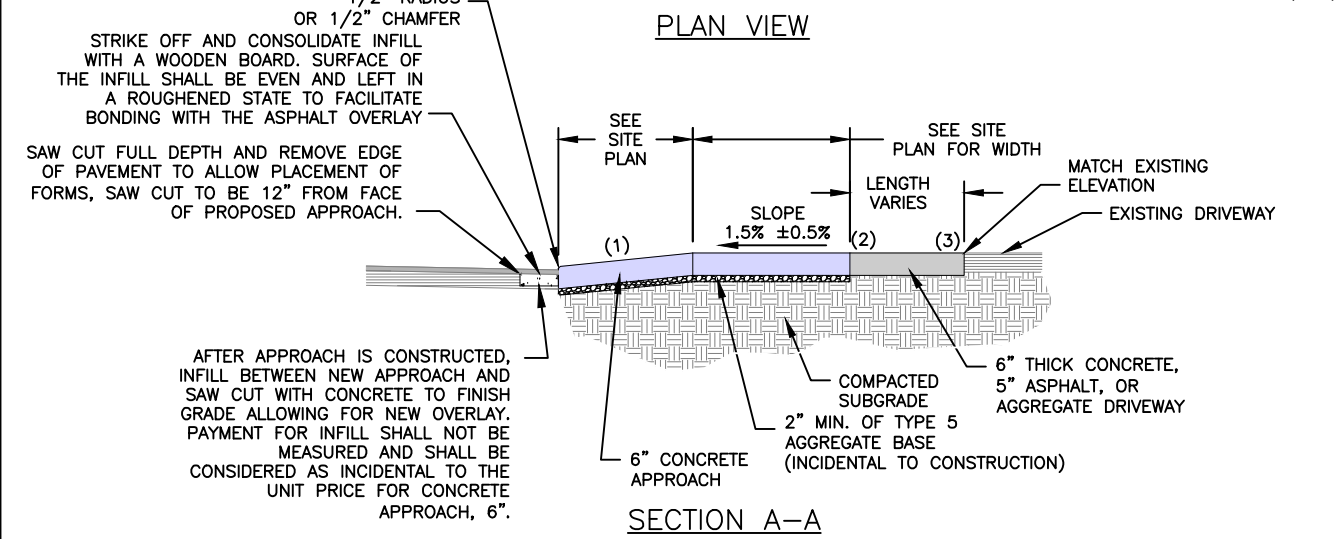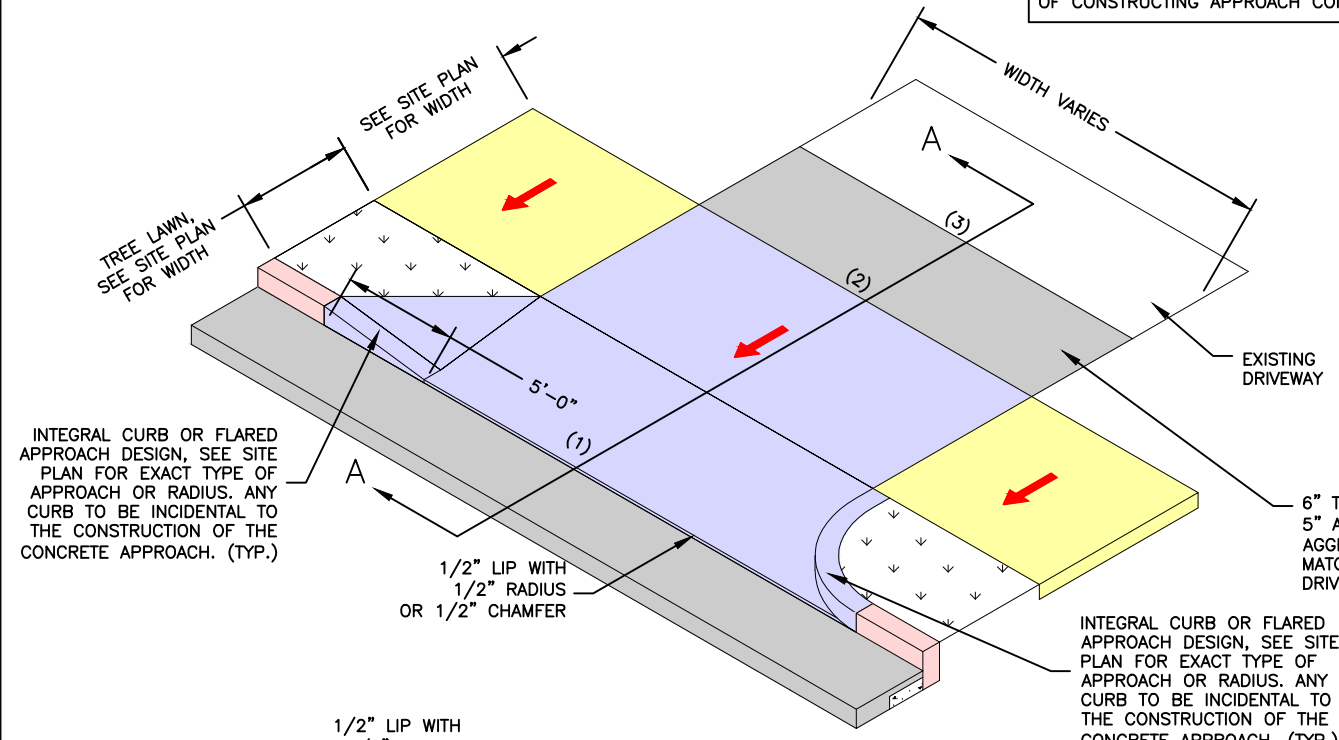

CONCRETE APPROACH (TYPE 6)
NO SCALE
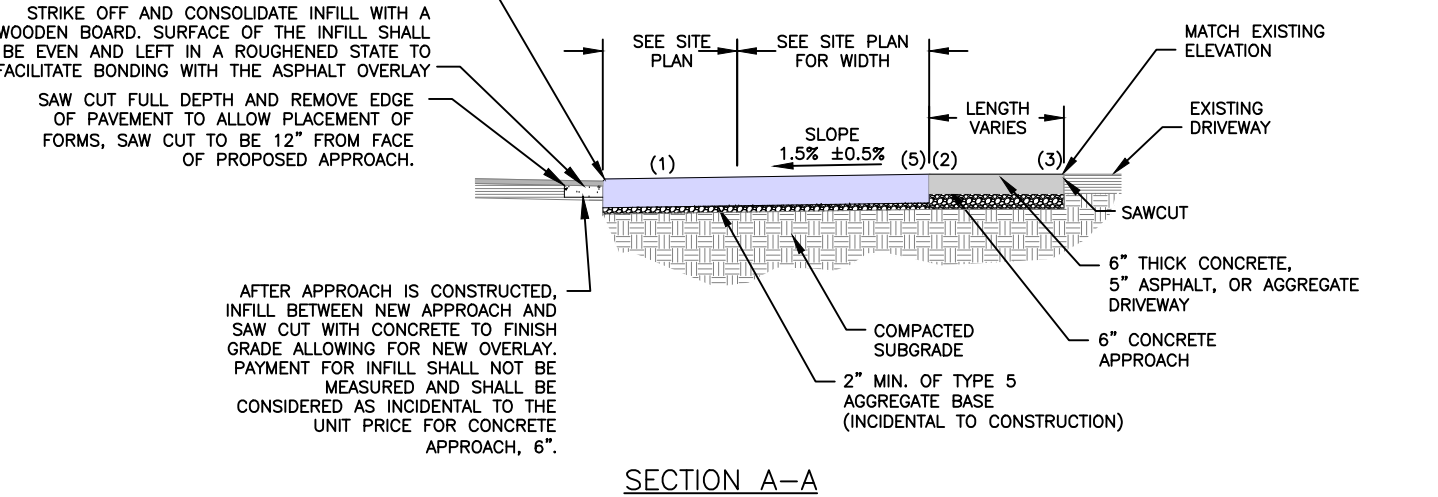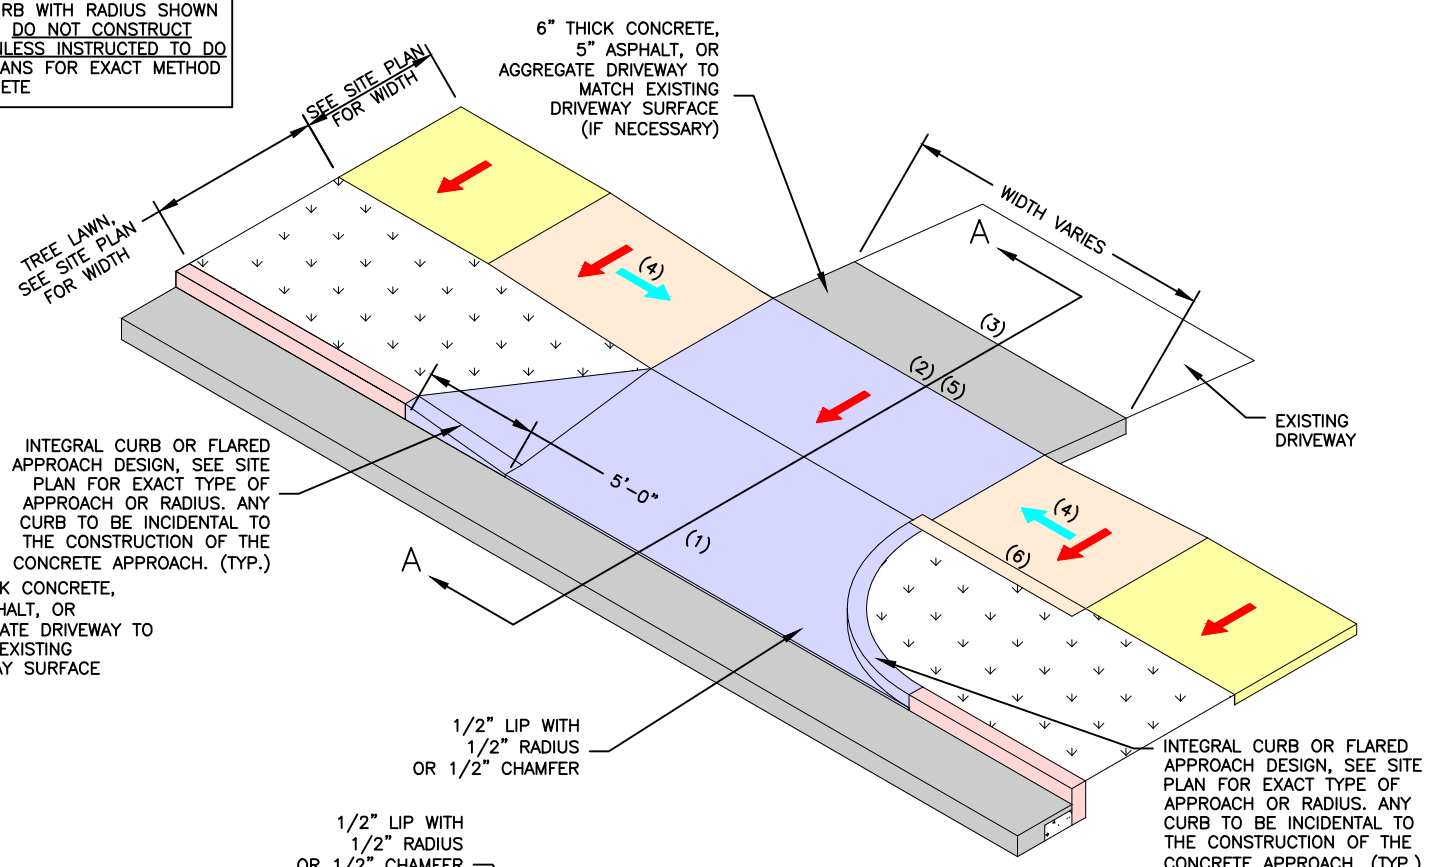
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

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HOLLOWAY ROAD IMPROVEMENTS
FEDERAL PROJECT NO. STP-4939(608)
CITY OF BALLWIN, MISSOURI

DATE	REVISION

DWN BY: K.J.W. APPD BY: M.D.S.
DATE: JANUARY 2021
SCALE: AS SHOWN
PROJ. NO: SC19-981
DWG. NO: DE-11

LEGEND

-  1.50% SLOPE ±0.50%
-  MAX. SLOPE 1V:12H (8.33%)

KEYED NOTES


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NOTES


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- 6. AT ENGINEERS DIRECTION, CROSS SLOPE OF SIDEWALKS AT DRIVEWAY APPROACHES MAY SLOPE AWAY FROM THE STREET.
- 7. IF EXISTING DRIVEWAY IS ASPHALT, CONTRACTOR SHALL NOT USE ASPHALT EDGE AS FORM FOR CONCRETE APPROACH UNLESS APPROVED BY ENGINEER. ANY ASPHALT PATCH NECESSARY DUE TO FORMING FOR CONCRETE APPROACH IS INCIDENTAL TO THE CONSTRUCTION.

CONSTRUCTION OF CURBS, GUTTERS, SIDEWALKS AND DRIVEWAYS REGARDLESS OF SEQUENCING OF CONSTRUCTION. CONTRACTOR IS SPECIFICALLY CAUTIONED NOT TO POUR CURBS, GUTTERS, AND SIDEWALKS PRIOR TO LAYOUT OF DRIVEWAYS AS APPROACH TYPES ARE SUBJECT TO CHANGE.

APPROACHES MAY SLOPE AWAY FROM THE STREET.
 7. IF EXISTING DRIVEWAY IS ASPHALT, CONTRACTOR SHALL NOT USE ASPHALT EDGE AS FORM FOR CONCRETE APPROACH UNLESS APPROVED BY ENGINEER. ANY ASPHALT PATCH NECESSARY DUE TO FORMING FOR CONCRETE APPROACH IS INCIDENTAL TO THE CONSTRUCTION.

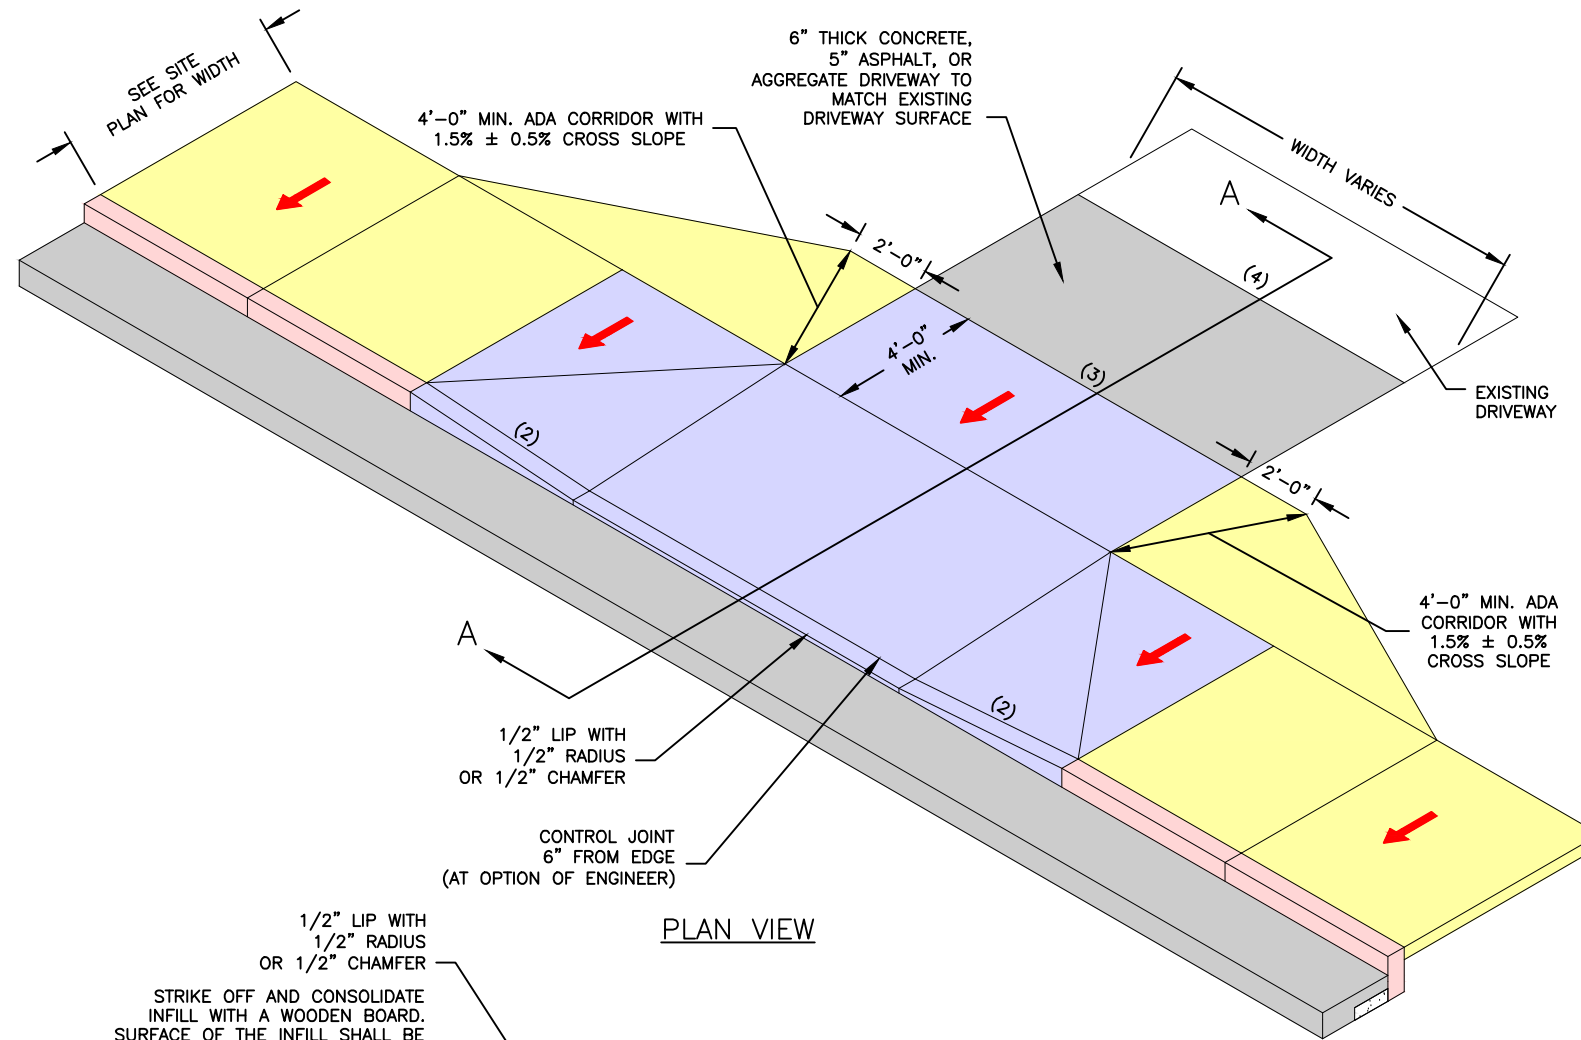

PLAN VIEW

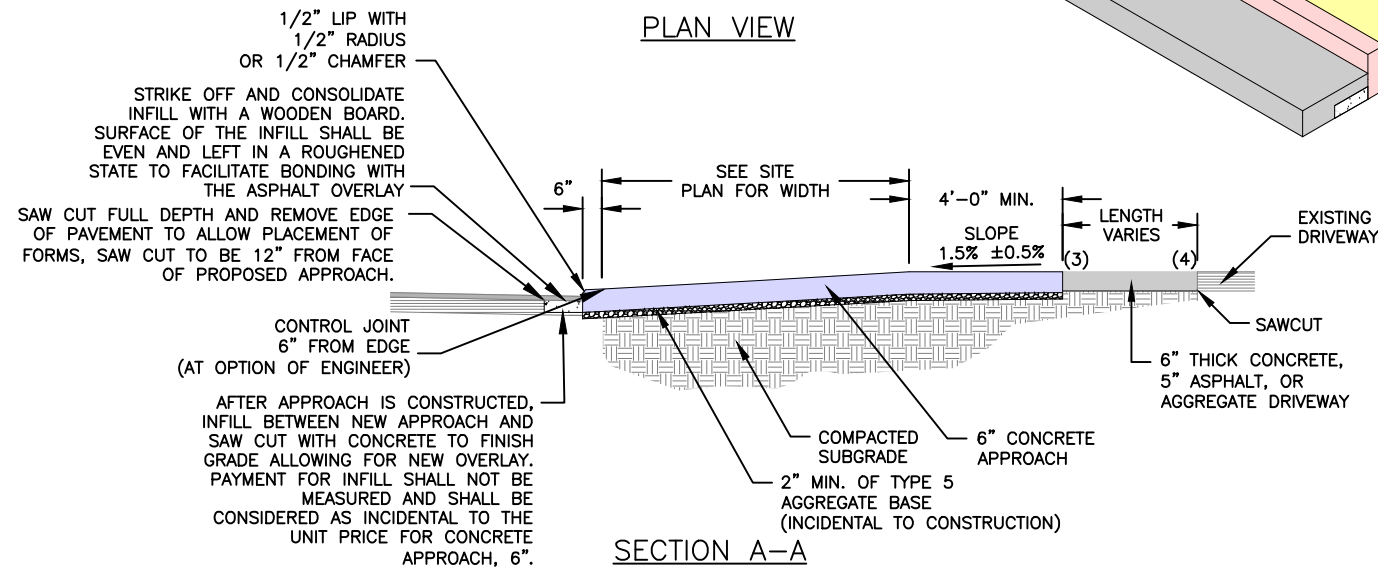

SECTION A-A

CONCRETE APPROACH (TYPE 7)

NO SCALE

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STATE OF MISSOURI

KEVIN J. WOLFF, P.E.
 PE 2011

1/28/21
 KEVIN J. WOLFF
 NO. PE-200400859
 STATE OF MISSOURI
 REGISTERED PROFESSIONAL ENGINEER
 FOR SC ENGINEERING LLC,
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

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HOLLOWAY ROAD IMPROVEMENTS
 FEDERAL PROJECT NO. STP-4939(608)
 CITY OF BALLWIN, MISSOURI

DATE	REVISION

DWN. BY: K.J.W. APPD. BY: M.D.S.
 DATE: JANUARY 2021
 SCALE: AS SHOWN
 PROJ. NO: SC19-981
 DWG. NO: DE-12

LEGEND


-  1.50% SLOPE ±0.50%
-  MAX. SLOPE 1V:12H (8.33%)

KEYED NOTES


- (1) MAX. SLOPE 1:10, MEASURED PARALLEL TO THE CURB LINE.
- (2) MAXIMUM PERCENT CHANGE FOR A SAG GRADE BREAK IS 12%. MAXIMUM PERCENT CHANGE FOR A CREST GRADE BREAK IS 8%.
- (3) MAINTAIN SLOPE FOR A MINIMUM OF 10' BEFORE ANOTHER GRADE CHANGE.
- (4) CONTRACTOR TO MATCH EXISTING ELEVATION OF DRIVEWAY AS CLOSE AS POSSIBLE WHILE PROVIDING AN ADA COMPLIANT SIDEWALK.

NOTES

- 1. IF TRANSITION OF DRIVEWAY BEYOND APPROACH IS NEEDED, CONTRACTOR SHALL REMOVE AND REPLACE EXISTING DRIVEWAY TO NEAREST JOINT OR AS DIRECTED BY THE ENGINEER, TO BE PAID BY UNIT BID PRICE FOR 6" CONCRETE DRIVEWAY, 5" ASPHALT DRIVEWAY OR AGGREGATE DRIVEWAY AS SHOWN ON THE SITE PLANS.
- 2. TOOLED JOINTS ARE REQUIRED AT ALL SLOPE BREAK LINES.
- 3. CURB, GUTTER AND SIDEWALK TYPES VARY. SEE SITE PLANS FOR EXACT TYPES.
- 4. SAW CUT LOCATIONS SHOWN ON PLANS ARE APPROXIMATE. CONSULT WITH ENGINEER BEFORE SAW CUT/REMOVALS.
- 5. CONTRACTOR SHALL COORDINATE CONSTRUCTION OF CURBS, GUTTERS, SIDEWALKS AND DRIVEWAYS REGARDLESS OF SEQUENCING OF CONSTRUCTION. CONTRACTOR IS SPECIFICALLY CAUTIONED NOT TO POUR CURBS, GUTTERS, AND SIDEWALKS PRIOR TO LAYOUT OF DRIVEWAYS AS APPROACH TYPES ARE SUBJECT TO CHANGE.
- 6. AT ENGINEERS DIRECTION, CROSS SLOPE OF SIDEWALKS AT DRIVEWAY APPROACHES MAY SLOPE AWAY FROM THE STREET.
- 7. IF EXISTING DRIVEWAY IS ASPHALT, CONTRACTOR SHALL NOT USE ASPHALT EDGE AS FORM FOR CONCRETE APPROACH UNLESS APPROVED BY ENGINEER. ANY ASPHALT PATCH NECESSARY DUE TO FORMING FOR CONCRETE APPROACH IS INCIDENTAL TO THE CONSTRUCTION.

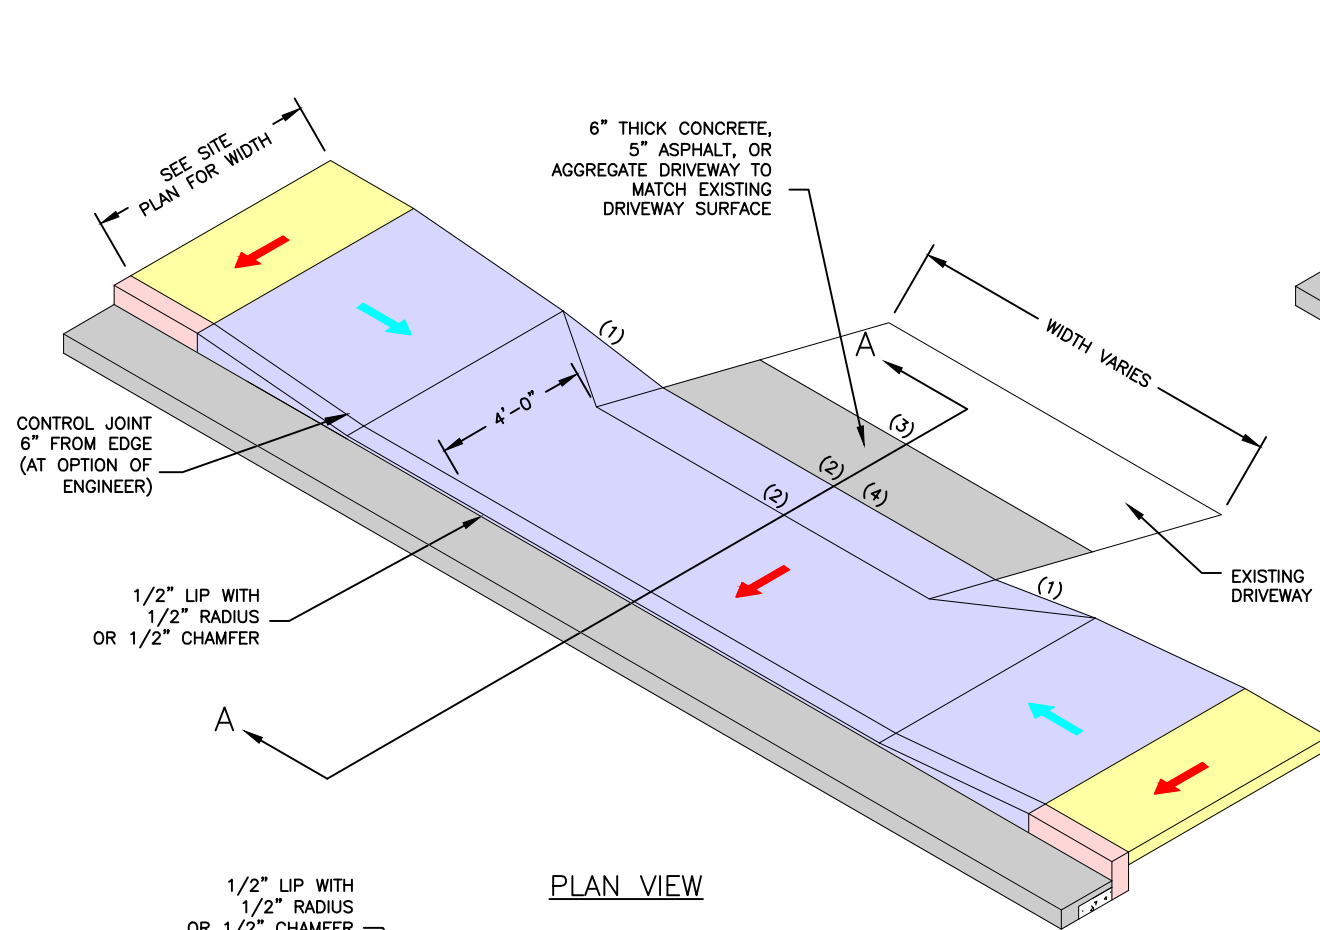


PLAN VIEW

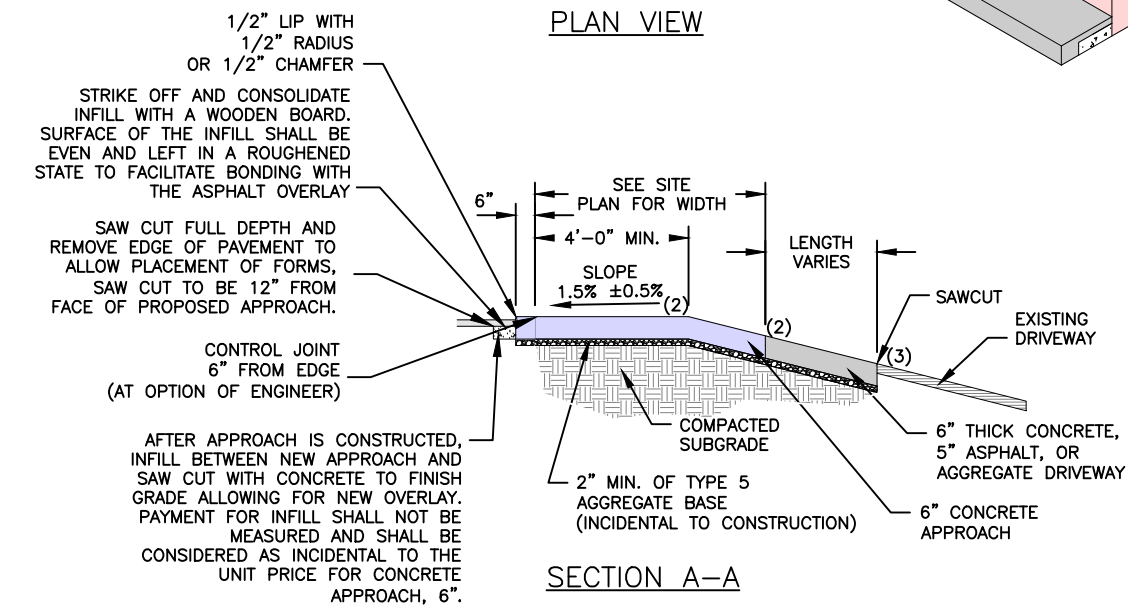


SECTION A-A

CONCRETE APPROACH (TYPE 8)
NO SCALE

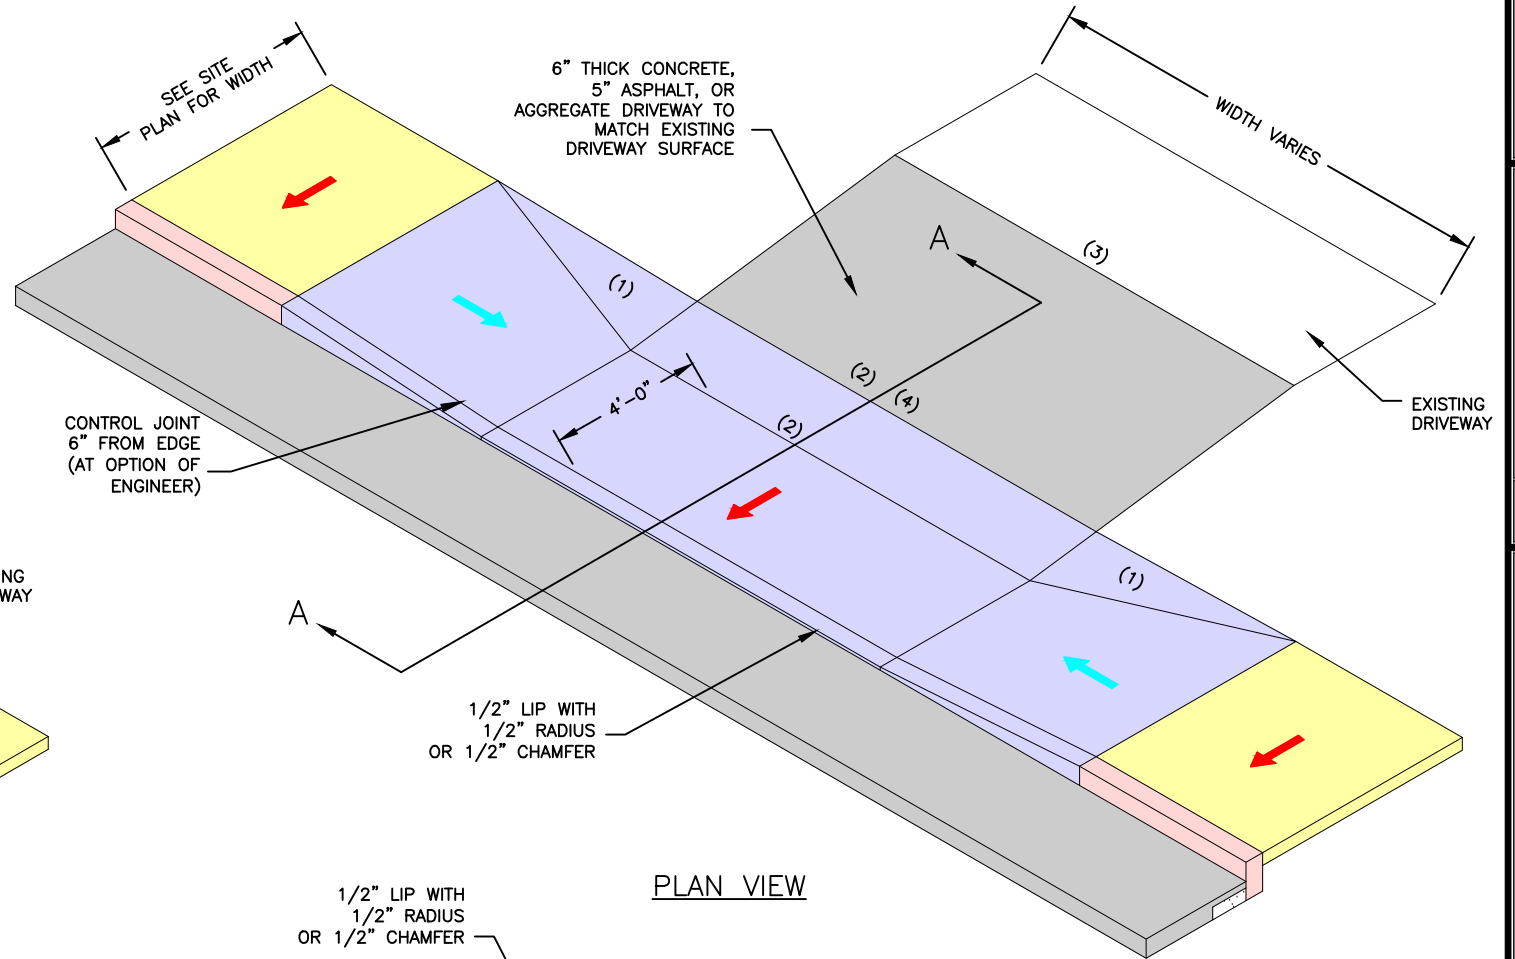

PLAN VIEW

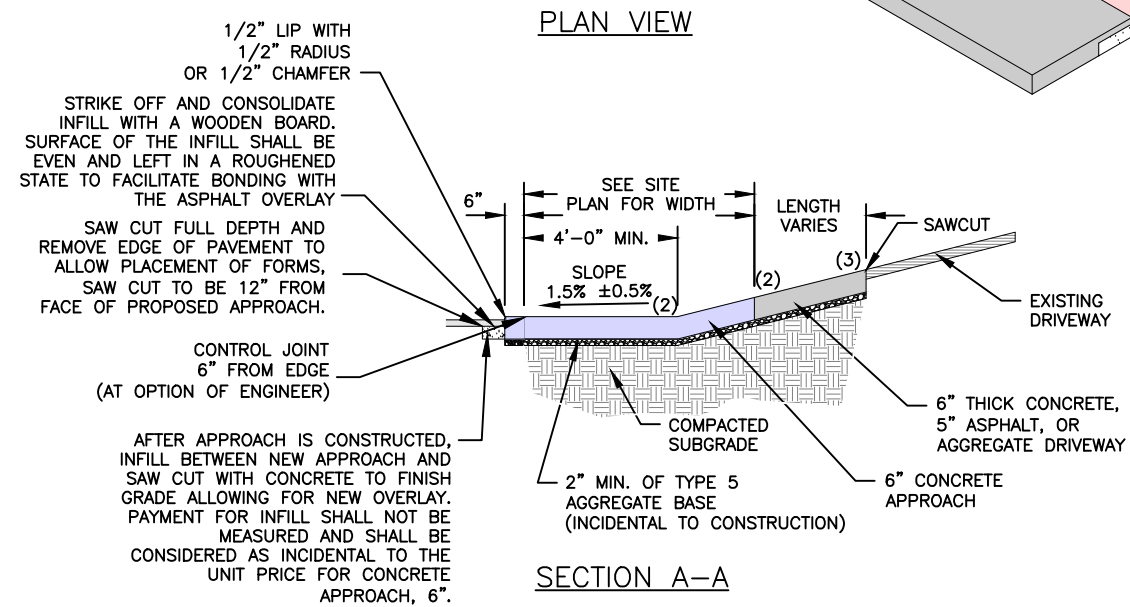

SECTION A-A

CONCRETE APPROACH (TYPE 9)
NO SCALE

Drawing name: U:\SC19-981 Holloway Road, Ballwin, MO\AUTOCAD DRAWINGS\DRIVEWAY DETAILS.dwg Tab: DE-13 Plotted on: Feb 09, 2021 - 10:34am Plotted by: kwcliff

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FOR SC ENGINEERING LLC,
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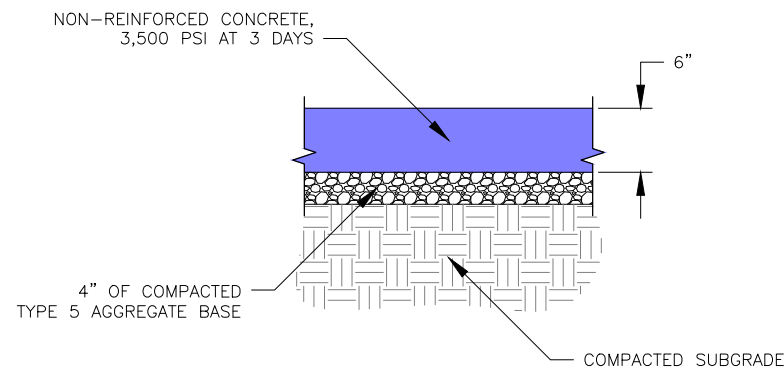
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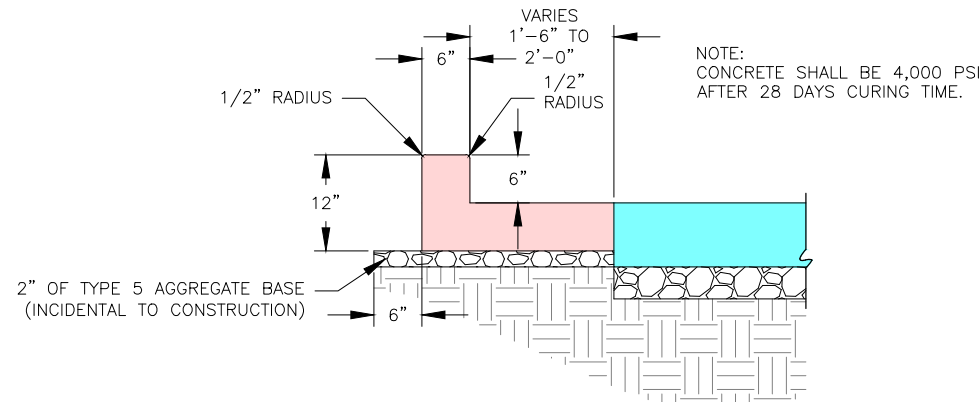
HOLLOWAY ROAD IMPROVEMENTS
FEDERAL PROJECT NO. STP-4939(608)
CITY OF BALLWIN, MISSOURI

DATE	REVISION	DWN. BY	APPD. BY
		K.J.W.	M.D.S.
DATE: JANUARY 2021			
SCALE: AS SHOWN			
PROJ. NO: SC19-981			
DWG. NO: DE-13			

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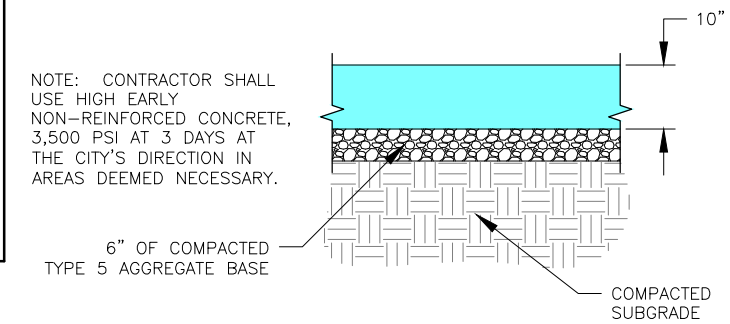


CONCRETE APPROACH (6")
NO SCALE




CONCRETE CURB AND GUTTER (WITHOUT SIDEWALK)
NO SCALE

ALL JOINTS SHALL CONFORM TO THE CURRENT MISSOURI DEPARTMENT OF TRANSPORTATION STANDARD PLANS FOR HIGHWAY CONSTRUCTION, SECTION 500, INCLUDING ALL JOINT SPACING, DOWELS AND SUPPORTING UNITS, EXPANSION MATERIAL AND SEALING. FINAL JOINT SPACING PATTERN SHALL BE APPROVED BY THE CITY.




CONCRETE PAVEMENT (10")
NO SCALE


ALL JOINTS SHALL CONFORM TO THE CURRENT MISSOURI DEPARTMENT OF TRANSPORTATION STANDARD PLANS FOR HIGHWAY CONSTRUCTION, SECTION 500, INCLUDING ALL JOINT SPACING, DOWELS AND SUPPORTING UNITS, EXPANSION MATERIAL AND SEALING. FINAL JOINT SPACING PATTERN SHALL BE APPROVED BY THE CITY.

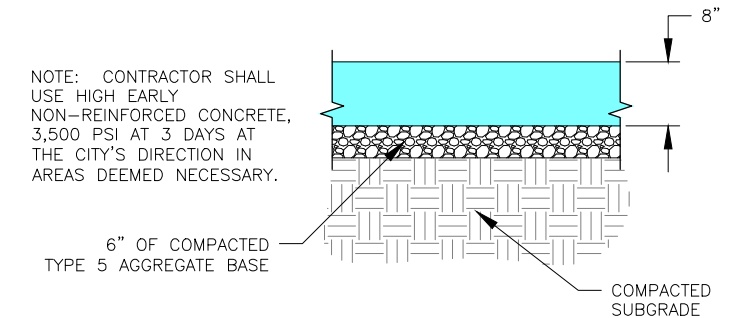


CONCRETE PAVEMENT (8")
NO SCALE

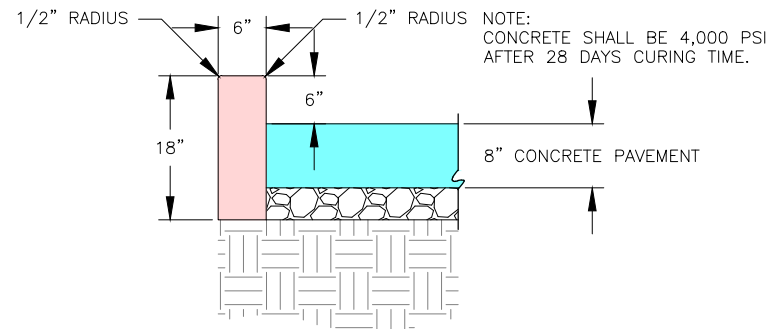

CONCRETE VERTICAL CURB (WITHOUT SIDEWALK)
NO SCALE

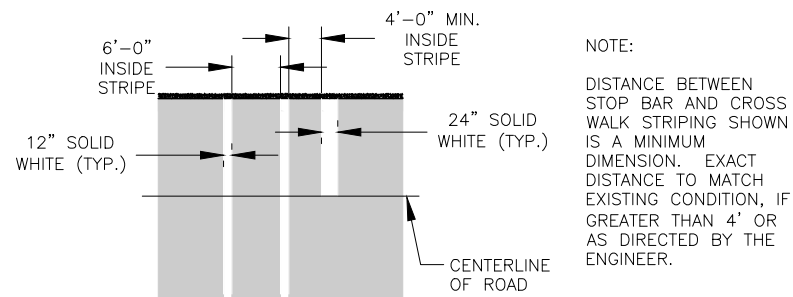

PAVEMENT MARKING (CROSSWALK AND STOP BAR DETAIL)
NO SCALE

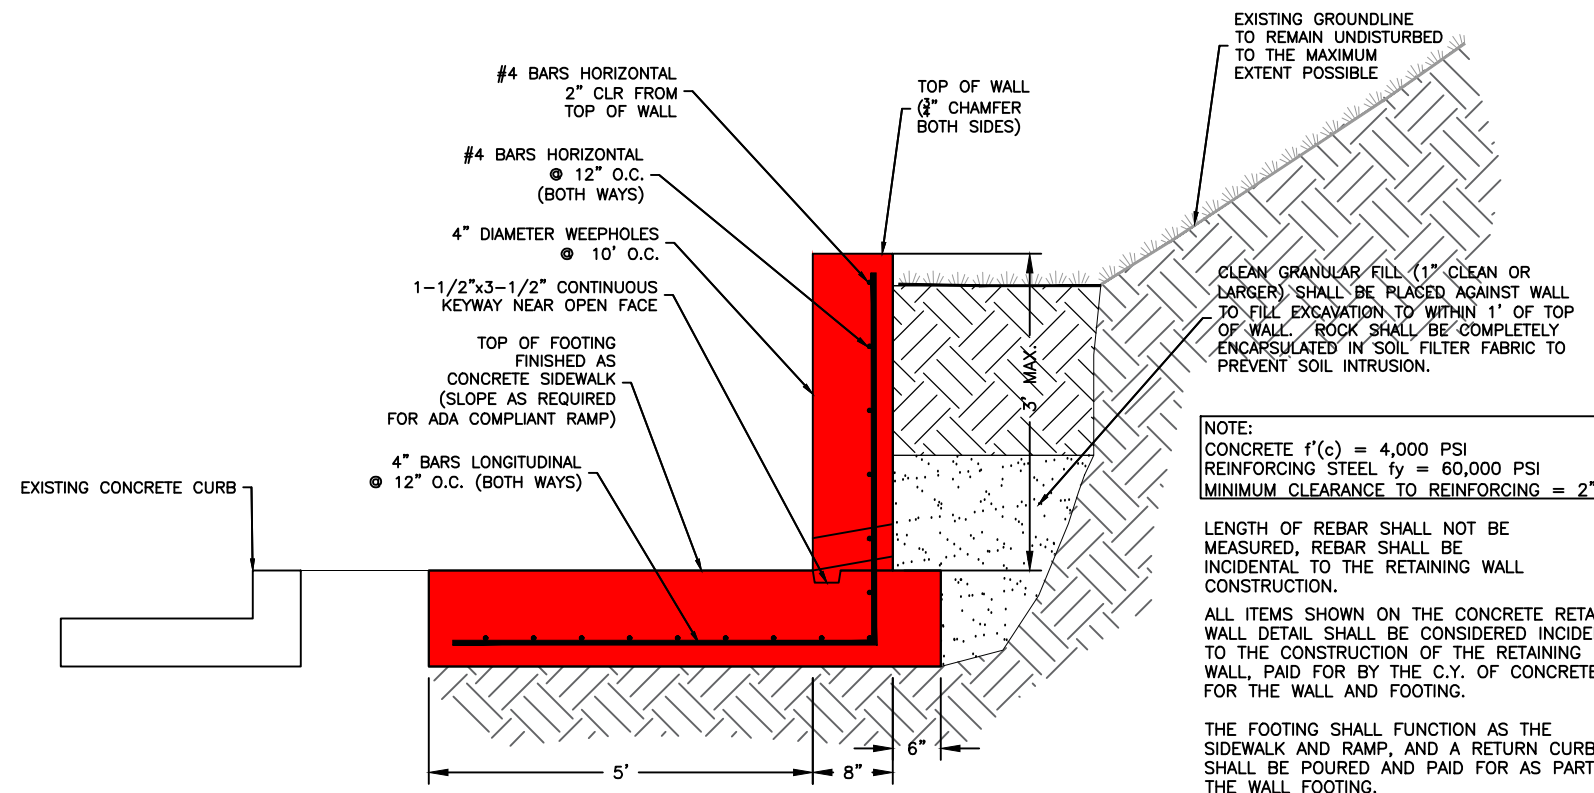

CONCRETE RETAINING WALL
NO SCALE

NOTE:
CONCRETE $f'(c) = 4,000$ PSI
REINFORCING STEEL $f_y = 60,000$ PSI
MINIMUM CLEARANCE TO REINFORCING = 2"

LENGTH OF REBAR SHALL NOT BE MEASURED, REBAR SHALL BE INCIDENTAL TO THE RETAINING WALL CONSTRUCTION.

ALL ITEMS SHOWN ON THE CONCRETE RETAINING WALL DETAIL SHALL BE CONSIDERED INCIDENTAL TO THE CONSTRUCTION OF THE RETAINING WALL, PAID FOR BY THE C.Y. OF CONCRETE FOR THE WALL AND FOOTING.

THE FOOTING SHALL FUNCTION AS THE SIDEWALK AND RAMP, AND A RETURN CURB SHALL BE POURED AND PAID FOR AS PART OF THE WALL FOOTING.

DETECTABLE WARNINGS SHALL BE IMBEDDED INTO THE FOOTING PER ADA RAMP REQUIREMENTS AND PAID FOR AS DETECTABLE WARNING DEVICE.

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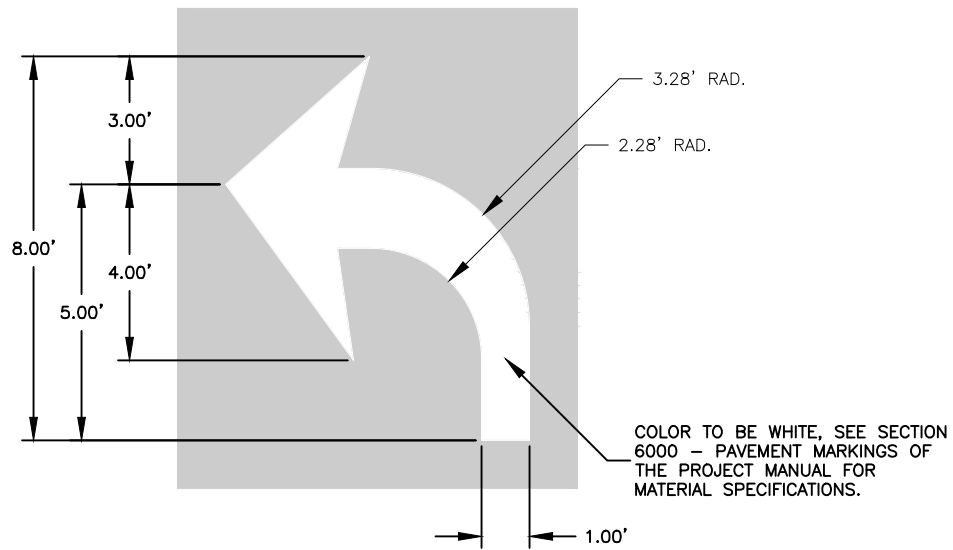
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Professional Engineer
1/28/21
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REGISTERED PROFESSIONAL ENGINEER
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CITY OF BALLWIN, MISSOURI

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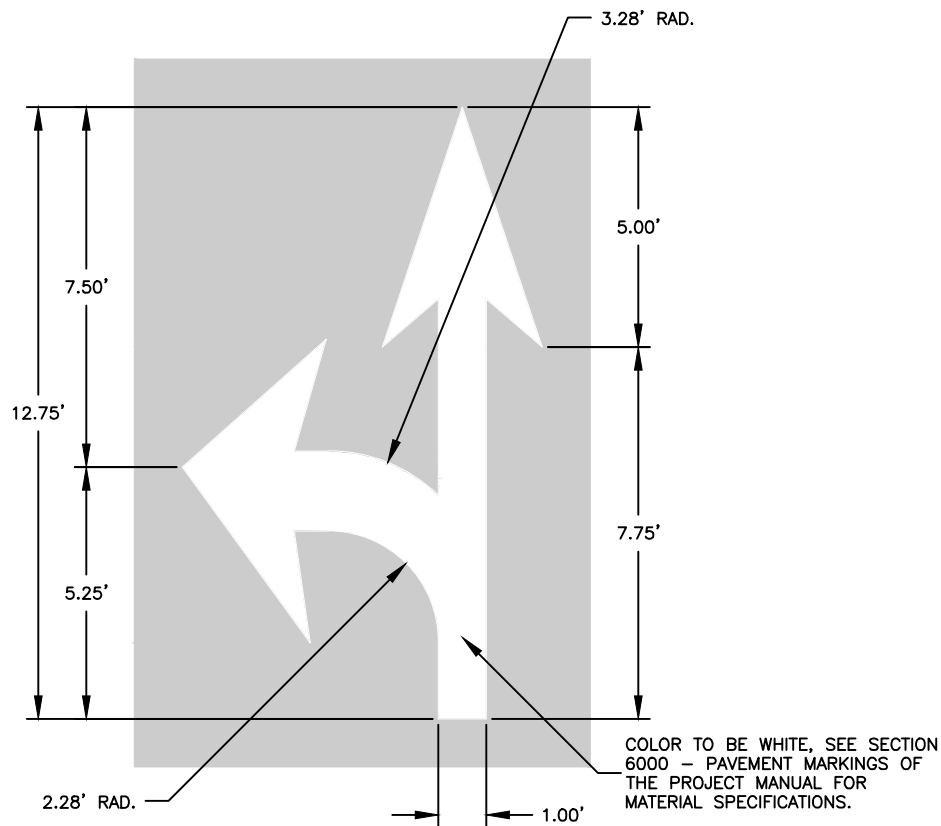
DWN BY: K.J.W. APPD BY: M.D.S.
DATE: JANUARY 2021
SCALE: AS SHOWN
PROJ. NO: SC19-981
DWG. NO: DE-14



COLOR TO BE WHITE, SEE SECTION 6000 - PAVEMENT MARKINGS OF THE PROJECT MANUAL FOR MATERIAL SPECIFICATIONS.

- NOTE:
- SEE PAVEMENT MARKING AND SIGNAGE PLANS FOR LOCATIONS
 - TYPICAL SIZES FOR NORMAL INSTALLATION; SIZES MAY BE REDUCED BY ONE-THIRD FOR LOW-SPEED URBAN CONDITIONS; LARGER SIZES MAY BE NEEDED FOR FREEWAYS, ABOVE AVERAGE SPEEDS AND OTHER CRITICAL LOCATIONS. CHANGES IN SIZE UNLESS NOTED IN PAVEMENT MARKING AND SIGNAGE PLANS MUST BE APPROVED BY THE ENGINEER.


TURN ARROW
NO SCALE



COLOR TO BE WHITE, SEE SECTION 6000 - PAVEMENT MARKINGS OF THE PROJECT MANUAL FOR MATERIAL SPECIFICATIONS.

- NOTE:
- SEE PAVEMENT MARKING AND SIGNAGE PLANS FOR LOCATIONS
 - TYPICAL SIZES FOR NORMAL INSTALLATION; SIZES MAY BE REDUCED BY ONE-THIRD FOR LOW-SPEED URBAN CONDITIONS; LARGER SIZES MAY BE NEEDED FOR FREEWAYS, ABOVE AVERAGE SPEEDS AND OTHER CRITICAL LOCATIONS. CHANGES IN SIZE UNLESS NOTED IN PAVEMENT MARKING AND SIGNAGE PLANS MUST BE APPROVED BY THE ENGINEER.


TURN AND THROUGH ARROW
NO SCALE

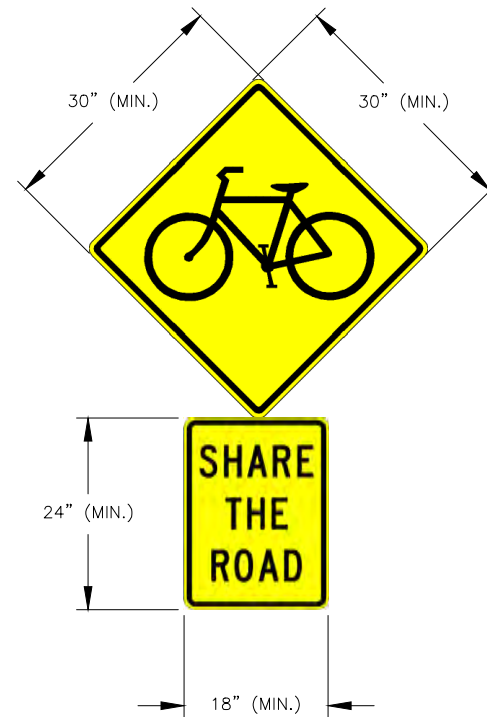

NOTE:
LETTERING SHALL BE SERIES 2000 STANDARD ALPHABETS

COLORS:
LEGEND - BLACK
BACKGROUND - YELLOW (RETROREFLECTIVE)


**"BIKE" (W11-1) SIGN WITH
"SHARE THE ROAD" (W16-1) SIGN**
NO SCALE

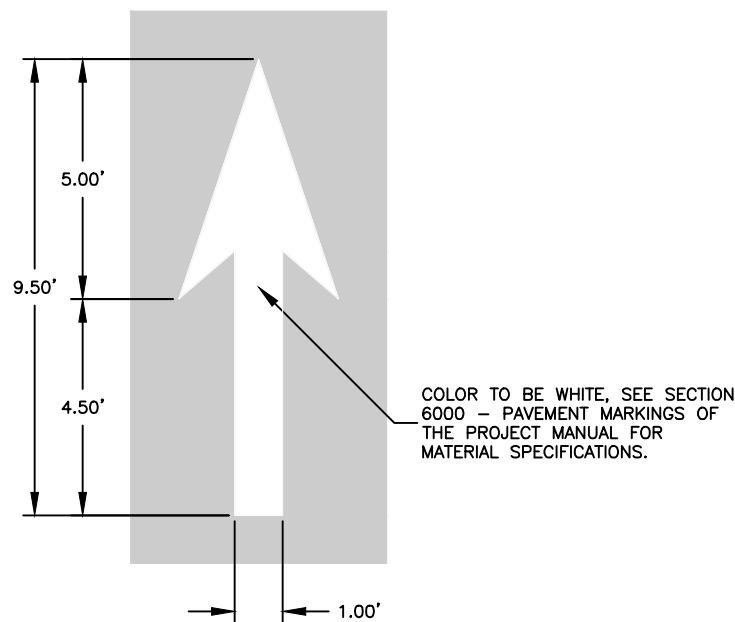


COLOR TO BE WHITE, SEE SECTION 6000 - PAVEMENT MARKINGS OF THE PROJECT MANUAL FOR MATERIAL SPECIFICATIONS.

- NOTE:
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THROUGH ARROW
NO SCALE

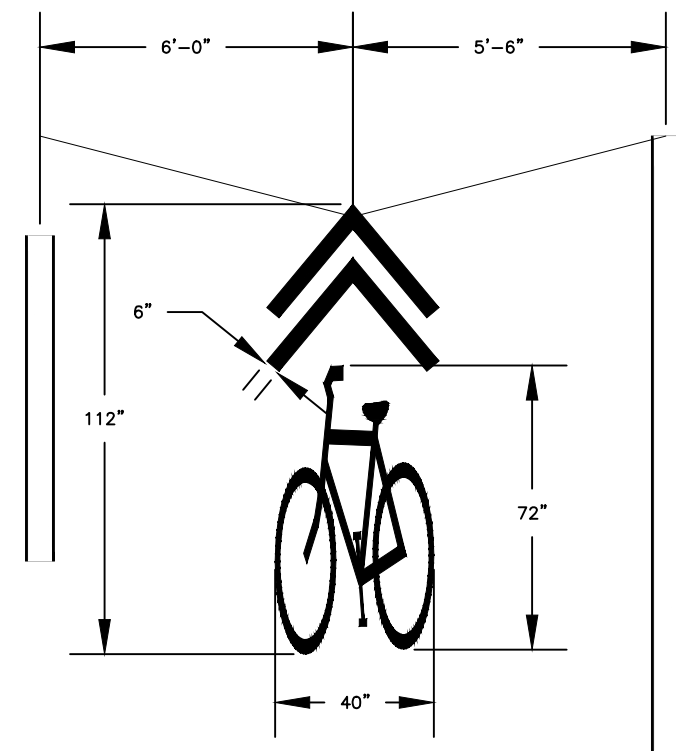


SHARED LANE SYMBOL DETAIL
NO SCALE

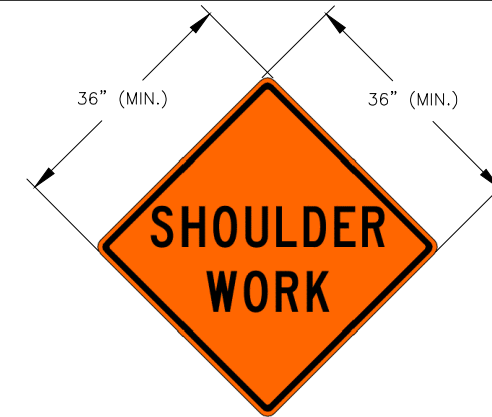

NOTE:
LETTERING SHALL BE SERIES 2000 STANDARD ALPHABETS

COLORS:
LEGEND - BLACK
BACKGROUND - ORANGE (RETROREFLECTIVE)

"SHOULDER WORK" (W21-5) SIGN
NO SCALE

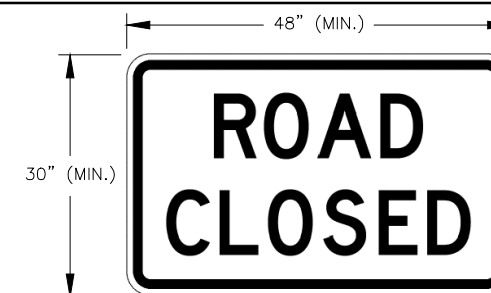

NOTE:
LETTERING SHALL BE SERIES 2000 STANDARD ALPHABETS

COLORS:
LEGEND - BLACK
BACKGROUND - WHITE (RETROREFLECTIVE)

"ROAD CLOSED" (R11-2) SIGN
NO SCALE

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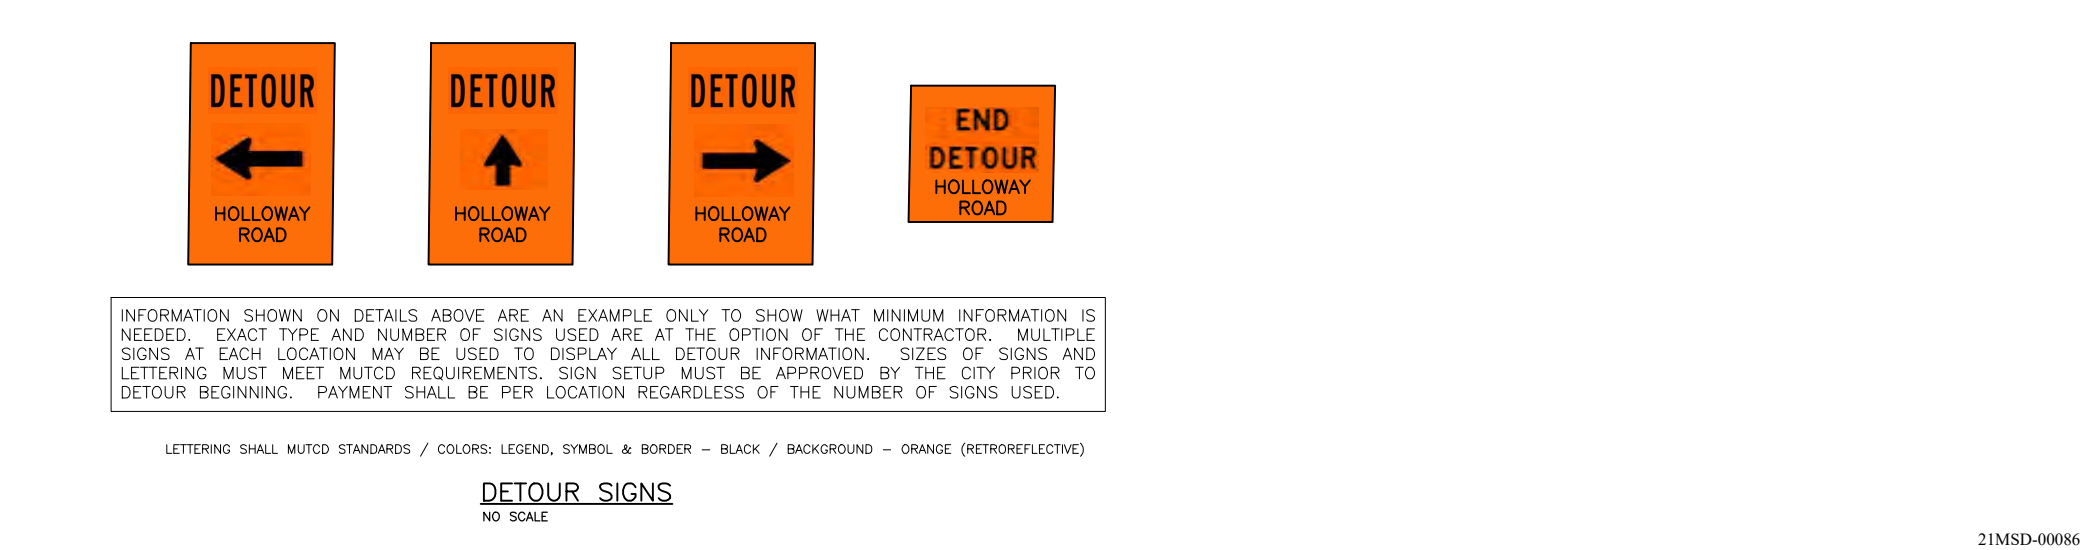
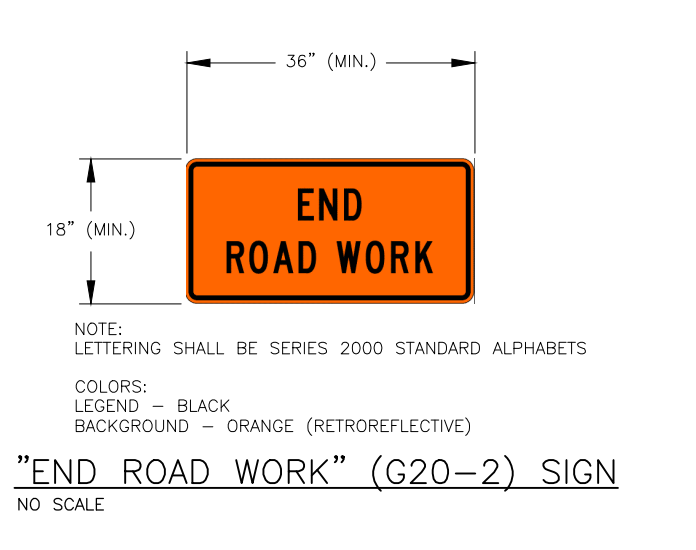
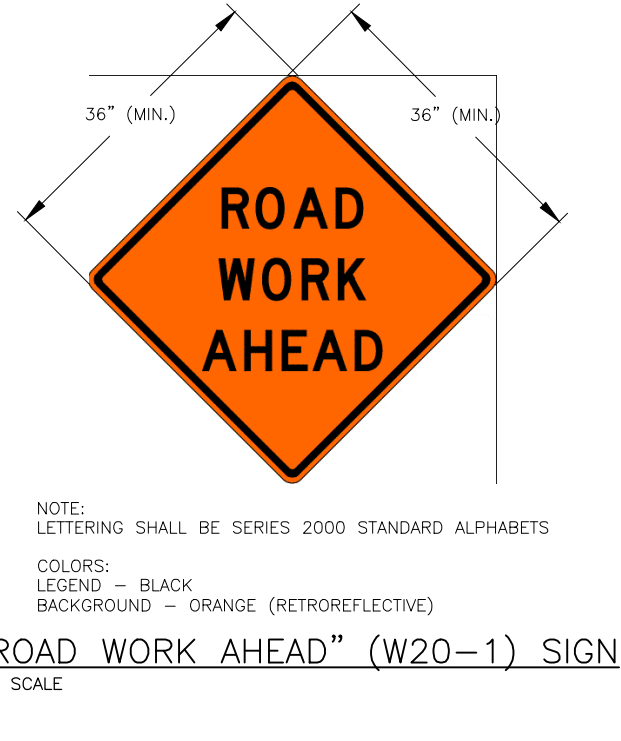
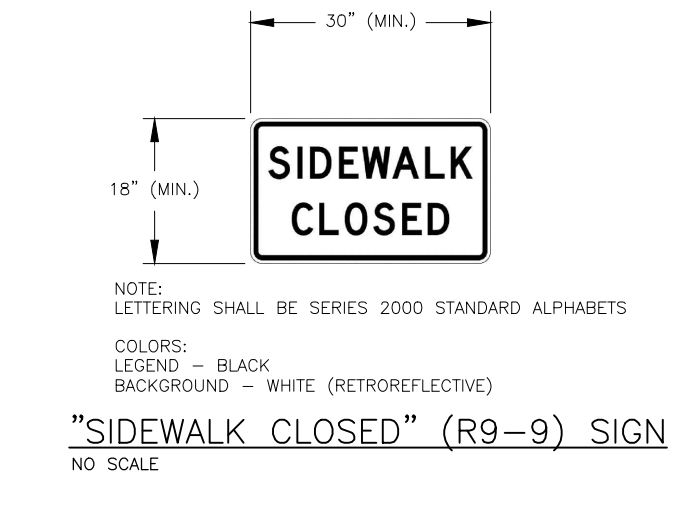
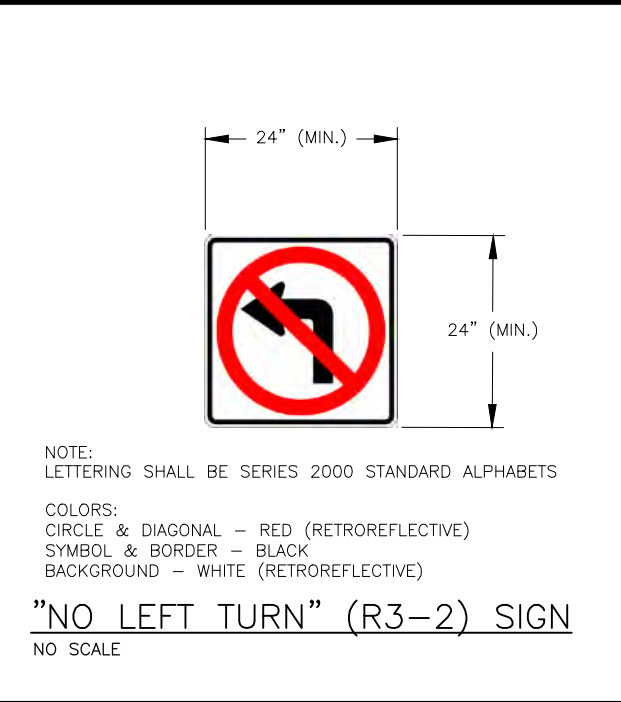
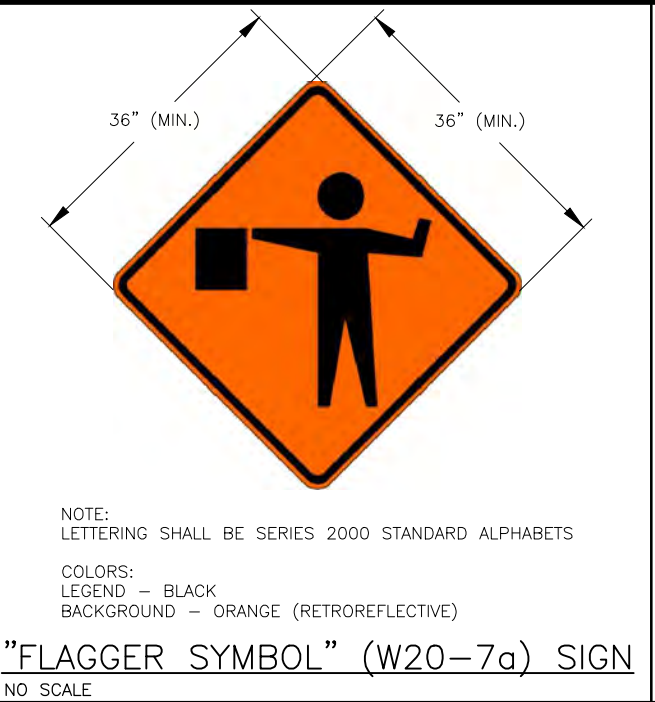
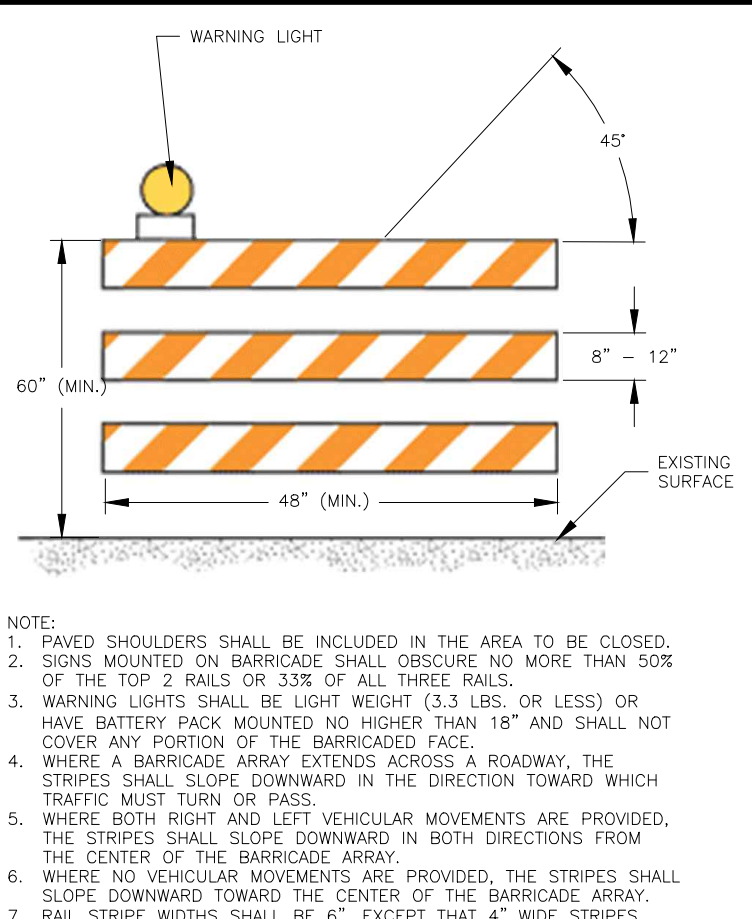
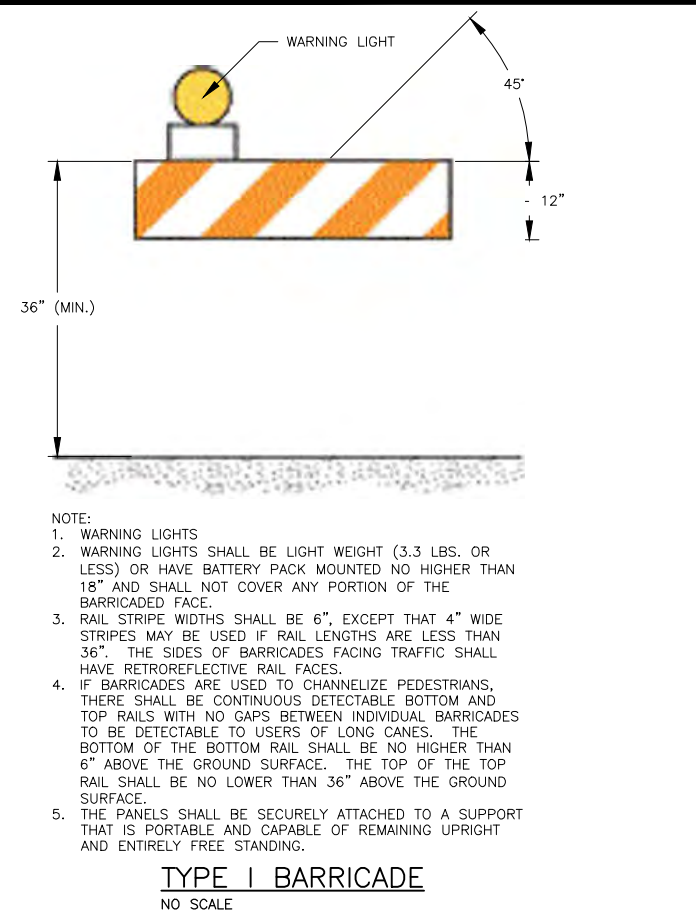
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CITY OF BALLWIN, MISSOURI

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REVISION:	REVISION:
DWN. BY:	APPD. BY:
K.J.W.	M.D.S.
DATE:	DATE:
JANUARY 2021	JANUARY 2021
SCALE:	SCALE:
AS SHOWN	AS SHOWN
PROJ. NO.:	PROJ. NO.:
SC19-981	SC19-981
DWG. NO.:	DWG. NO.:
DE-15	DE-15



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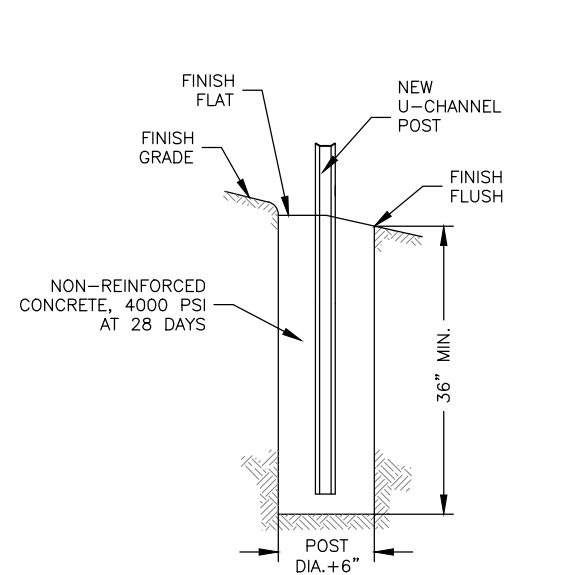
DATE	REVISION

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APPD BY: M.D.S.
DATE: JANUARY 2021
SCALE: AS SHOWN
PROJ. NO: SC19-981
DWG. NO: DE-16


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TYPICAL NEW SIGN INSTALLATION IN SOIL DETAIL
NO SCALE



TYPICAL NEW SIGN INSTALLATION IN SIDEWALK DETAIL
NO SCALE

NOTES:

ALL POSTS SHALL BE CENTERED IN CONCRETE FOOTING. CONTRACTOR SHALL EXCAVATE FOR SIGN FOOTING WITH AN AUGER.

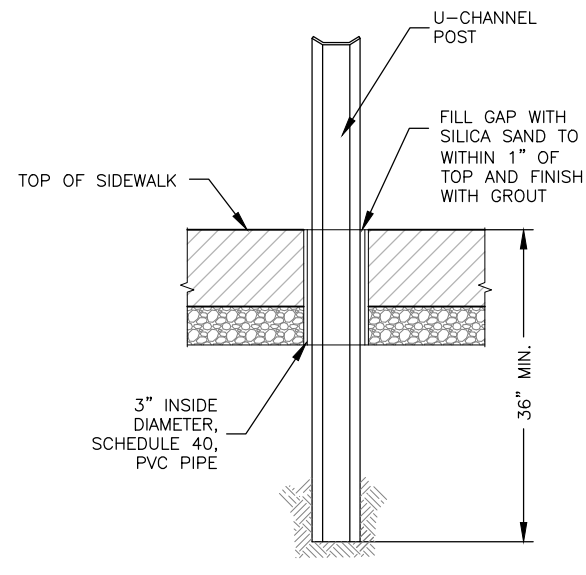LENGTH OF POST SHALL BE AS REQUIRED TO MEET MINIMUM ADA REQUIREMENTS FOR SIGN HEIGHT CLEARANCE. SEE PROJECT MANUAL FOR GUIDANCE.

WHEN INSTALLING SIGNS IN NEW SIDEWALKS, PVC SLEEVES SHALL BE INSTALLED PRIOR TO PLACEMENT OF ANY NEW CONCRETE. PVC SLEEVE SHALL BE SCHEDULE 40 PVC. THE LENGTH OF THE SLEEVE SHALL BE THE SAME AS THE THICKNESS OF THE SIDEWALK AND AGGREGATE BASE. THE PVC SLEEVE SHALL BE INSTALLED FLUSH WITH THE FINISH GRADE OF THE SURROUNDING SIDEWALK. BACK FILL THE VOID BETWEEN THE SLEEVE AND SIGN POST WITH SAND TO WITHIN 1\"/>

ALL PAYMENT FOR CONCRETE FOOTINGS FOR NEW SIGN INSTALLATIONS SHALL BE INCLUDED IN THE UNIT PRICE LINE ITEM PER EACH NEW SIGN TYPE.

NOTES:

1. DELINEATORS SHALL BE PLACED AT THE RADIUS POINTS OF ALL CONCRETE ISLANDS.


2. MINIMUM SPACING FOR DELINEATORS SHALL BE 20'. LOCATION OF DELINEATORS TO BE APPROVED BY THE ENGINEER.

3. RETROREFLECTIVE YELLOW, WHITE OR RED SHEETING IN ACCORDANCE WITH ASTM D4956 TYPE 5 OR 8 SHALL BE APPLIED TO ONLY ONE SIDE OF THE DELINEATOR REFLECTOR BODY.


4. COLOR OF DELINEATOR POST AND REFLECTIVE SHEETING SHALL MATCH THE COLOR OF THE CLOSEST PAVEMENT MARKING OR CURB MARKING.

5. 3" X 6" DELINEATOR BODY SHALL BE MADE FROM 0.080 INCH ALUMINUM.

6. DELINEATOR POST SHAPE MAY BE ROUND OR T-SHAPED. DELINEATOR POST SHALL BE PERMANENTLY MOUNTED TO THE PAVEMENT SURFACE IN ACCORDANCE WITH THE MANUFACTURER'S RECOMMENDATIONS

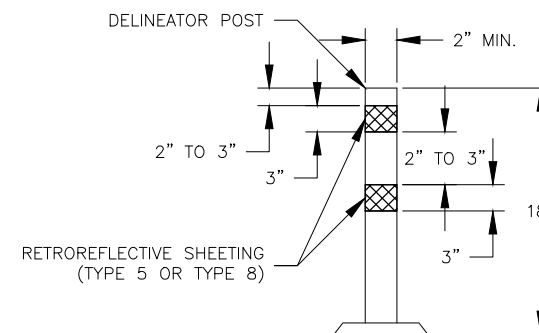

18" SURFACE-MOUNT DELINEATOR POST DETAIL
NO SCALE

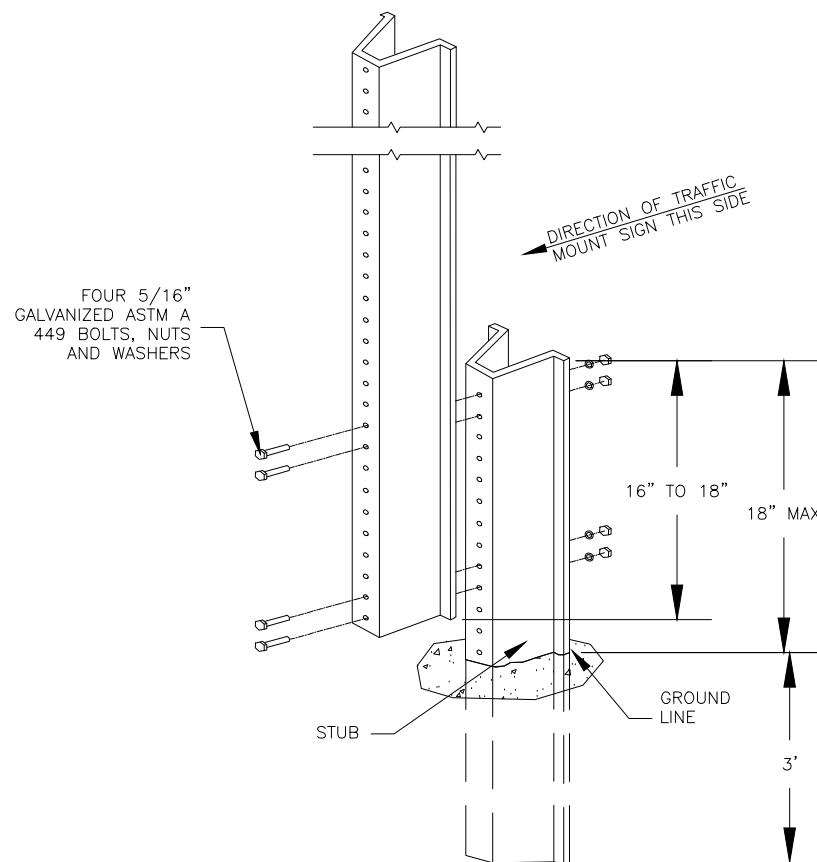

U-CHANNEL POST DETAIL
NO SCALE

SIGN AREA (SQ. FT.)	POST TYPE
	U-CHANNEL
≤ 10	1 - 3.0 LB/FT*
> 10 ≤ 16	2 - 3.0 LB/FT
> 16 ≤ 24	3 - 3.0 LB/FT
> 24 ≤ 30	4 - 3.0 LB/FT
> 30 ≤ 50	N/A

* SIGNS GREATER THAN 4 FT. IN WIDTH, EXCEPT DIAMOND SHAPE SIGNS, REQUIRE 2 POSTS.

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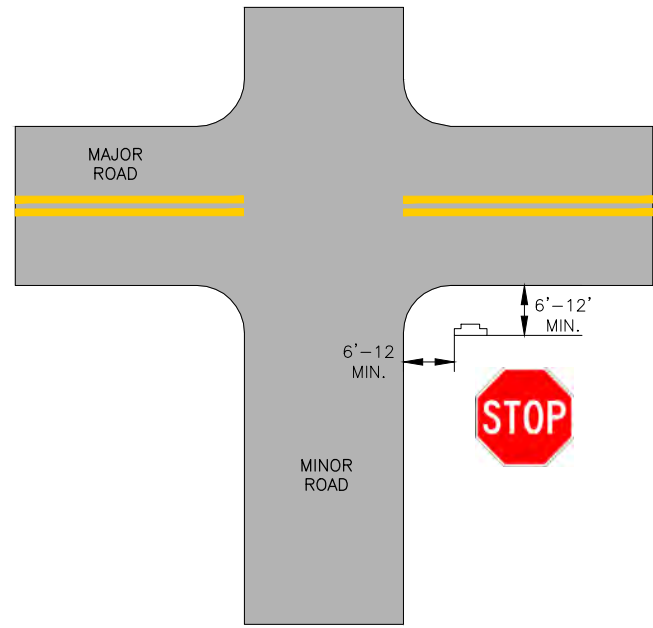
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FEDERAL PROJECT NO. STP-4939(608)
CITY OF BALLWIN, MISSOURI


REVISION:

DATE:	DATE:
DWN. BY: K.J.W.	APPD. BY: M.D.S.
DATE: JANUARY 2021	
SCALE: AS SHOWN	
PROJ. NO: SC19-981	
DWG. NO: DE-17	


SIGN PLACEMENT DETAILS




TYPICAL SIGN LOCATION AT MINOR CROSSROAD
NO SCALE

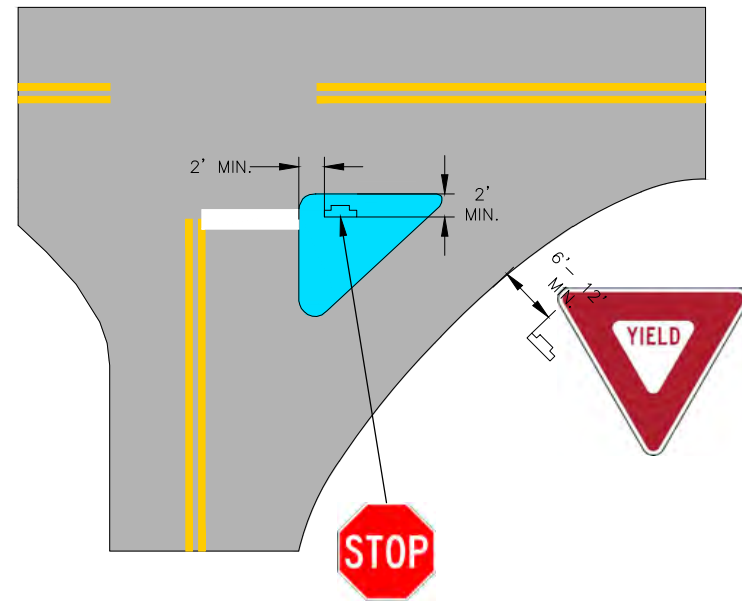


TYPICAL SIGN LOCATION AT INTERSECTION WITH ISLAND
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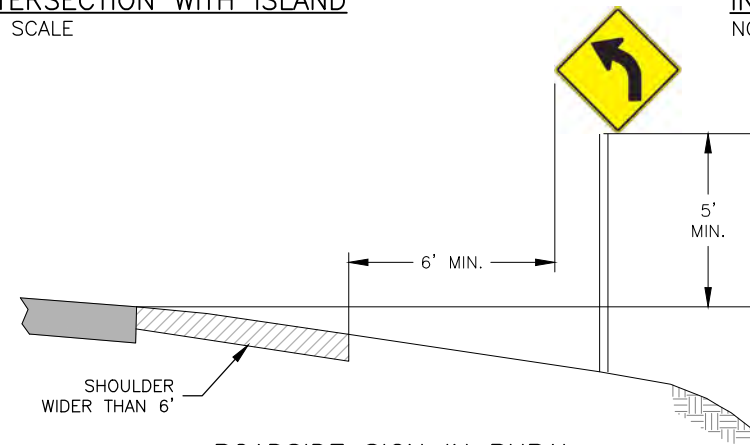
TYPICAL SIGN LOCATION AT INTERSECTION WITH CROSSWALK
NO SCALE

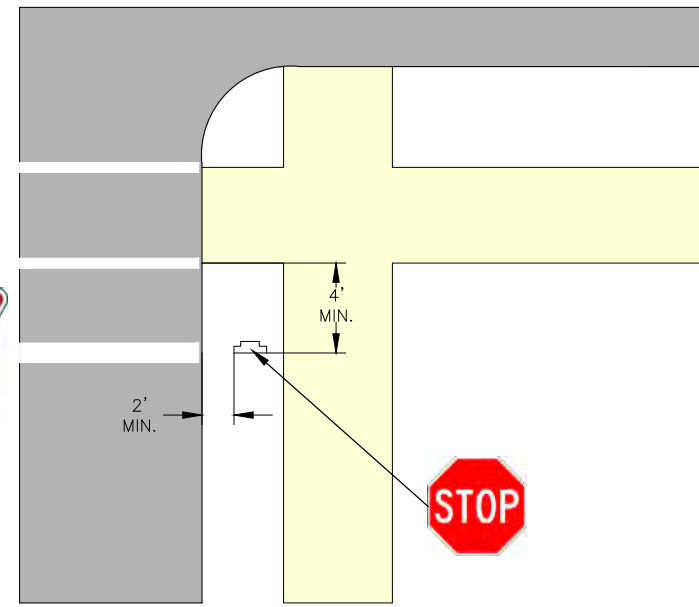


TYPICAL SIGN LOCATION AT INTERSECTION WITH WIDE THROAT
NO SCALE

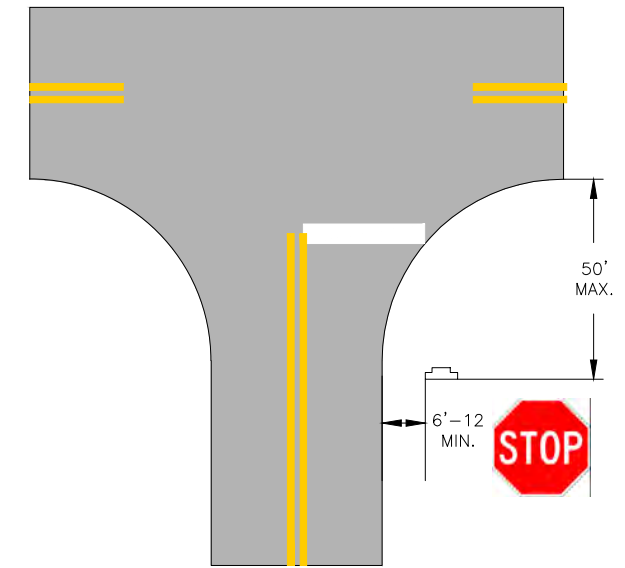


ROADSIDE SIGN IN RURAL AREA
NO SCALE

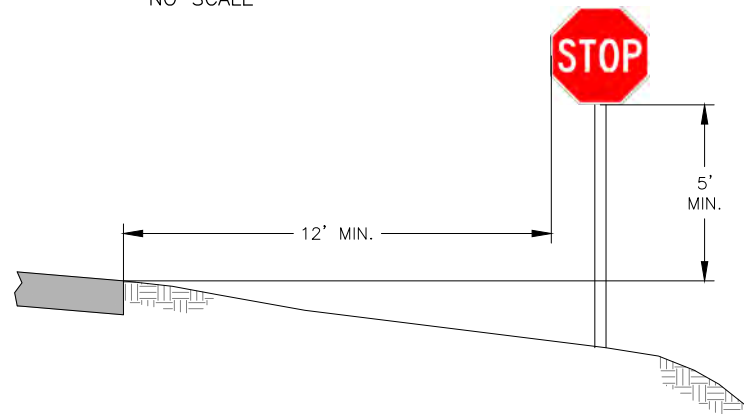


ROADSIDE SIGN IN RURAL AREA WITH SHOULDER
NO SCALE

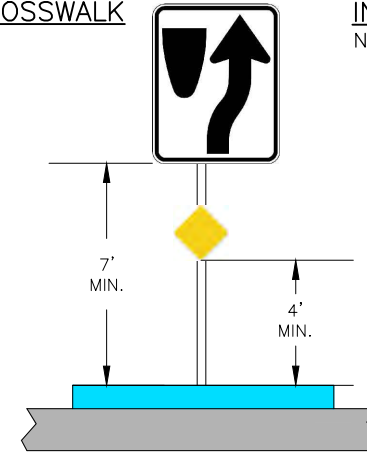

SIGN IN MEDIAN
NO SCALE

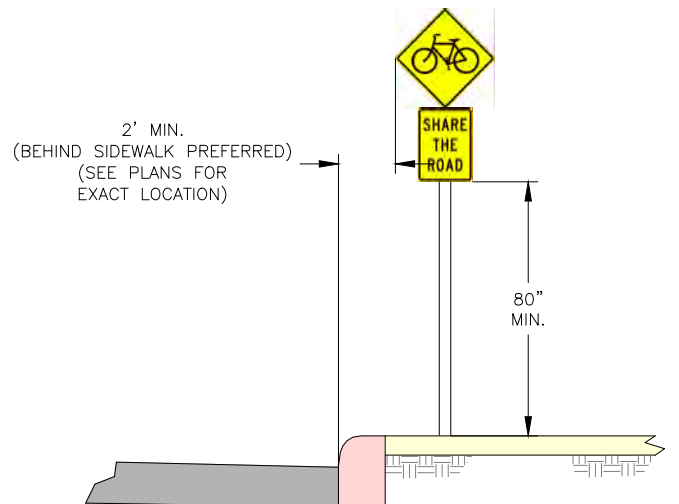

ROADSIDE SIGN IN BUSINESS, COMMERCIAL OR RESIDENTIAL AREA WITH SIDEWALK AT CURB
NO SCALE

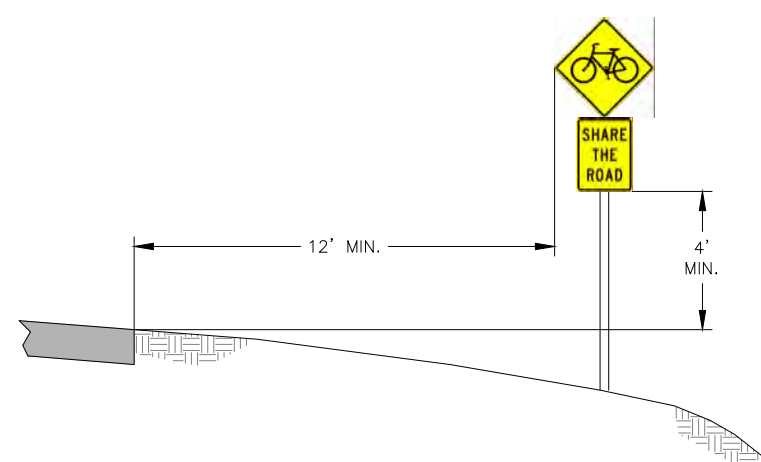

ROADSIDE SIGN WITH SECONDARY PLAQUE IN RURAL AREA
NO SCALE

SIGN GENERAL NOTES:

CONTRACTOR SHALL RELOCATE ALL EXISTING SIGNS AS NECESSARY FOR THE CONSTRUCTION OF THE IMPROVEMENTS. NEW LOCATIONS SHALL BE AS SHOWN IN THESE DETAILS OR AS DIRECTED BY THE ENGINEER.

SIGNS SHALL BE REMOVED IN SUCH A MANNER AS TO PROTECT THE EXISTING SIGN AND POST TO THE EXTENT THAT IT CAN BE REUSED IN THE NEW LOCATION. IF THE SIGN OR POST IS DAMAGED DURING THE RELOCATION DUE TO CONTRACTOR NEGLIGENCE, THE CONTRACTOR SHALL REPLACE ALL DAMAGED ITEMS AT NO COST TO THE OWNER.

THE CONTRACTOR SHALL STORE THE SIGNS IN A SAFE LOCATION UNTIL THEY ARE READY TO REINSTALL THE SIGN.

IF NO LINE ITEM IS PROVIDED IN THE BID FORM FOR RELOCATION OF SIGNS, THIS WORK SHALL BE CONSIDERED INCIDENTAL TO THE CONSTRUCTION.

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STATE OF MISSOURI
KEVIN J. WOLFF, P.E.
Nathan Wolff
PROFESSIONAL ENGINEERING
1/28/21
KEVIN J. WOLFF
NO. FE-200400859
STATE OF MISSOURI
REGISTERED PROFESSIONAL ENGINEER
FOR SC ENGINEERING LLC
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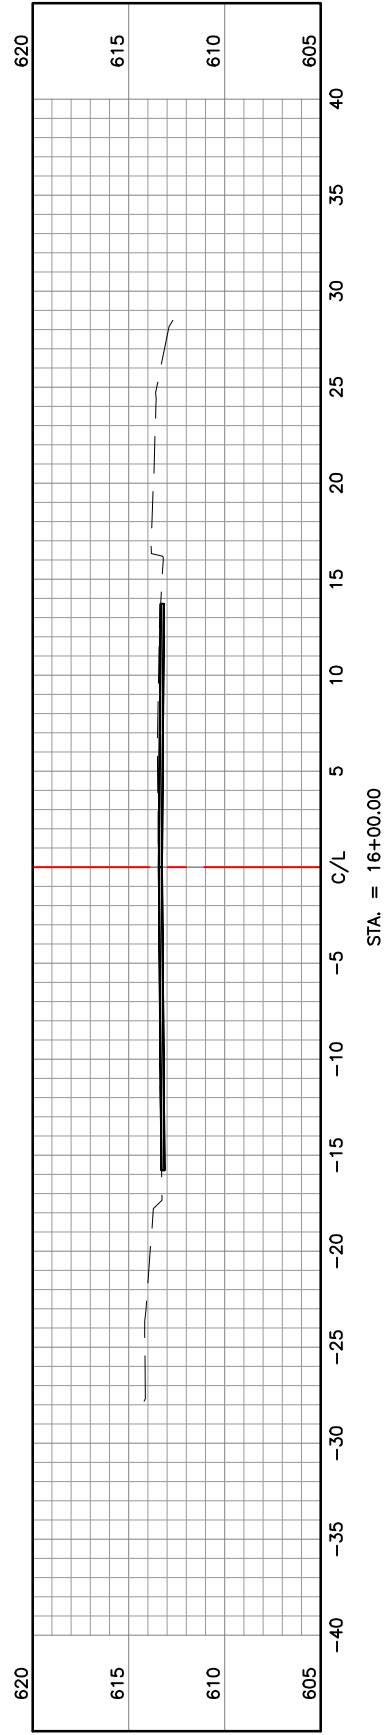
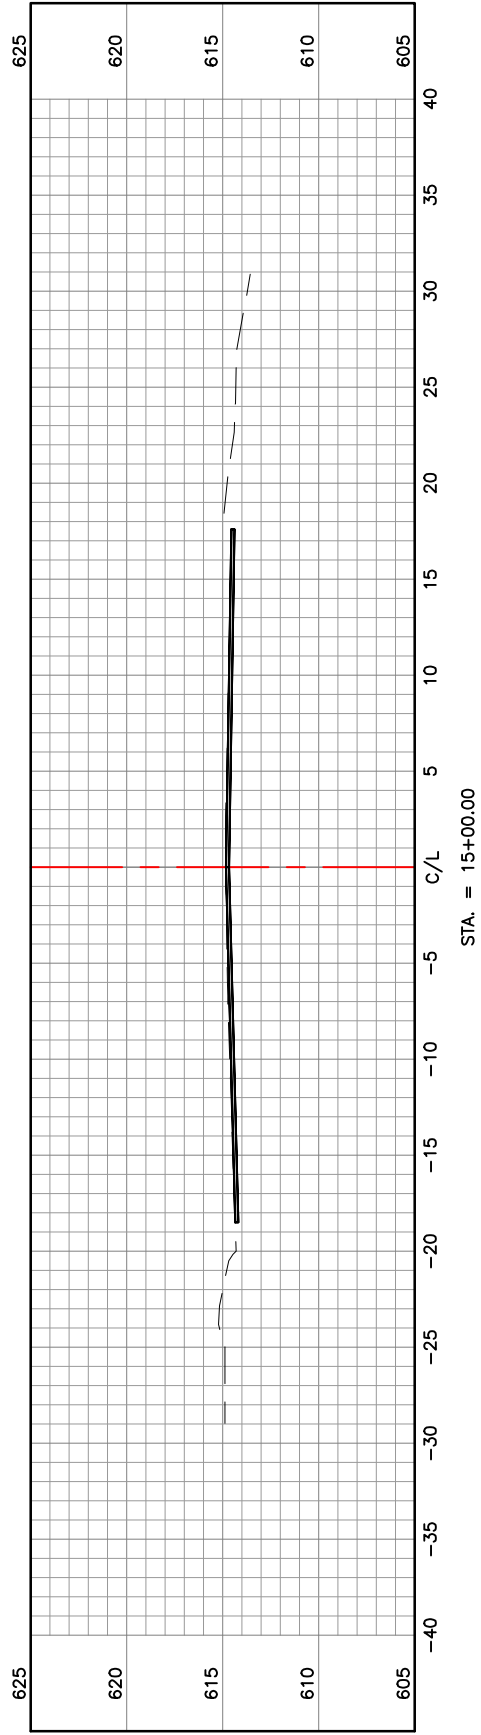
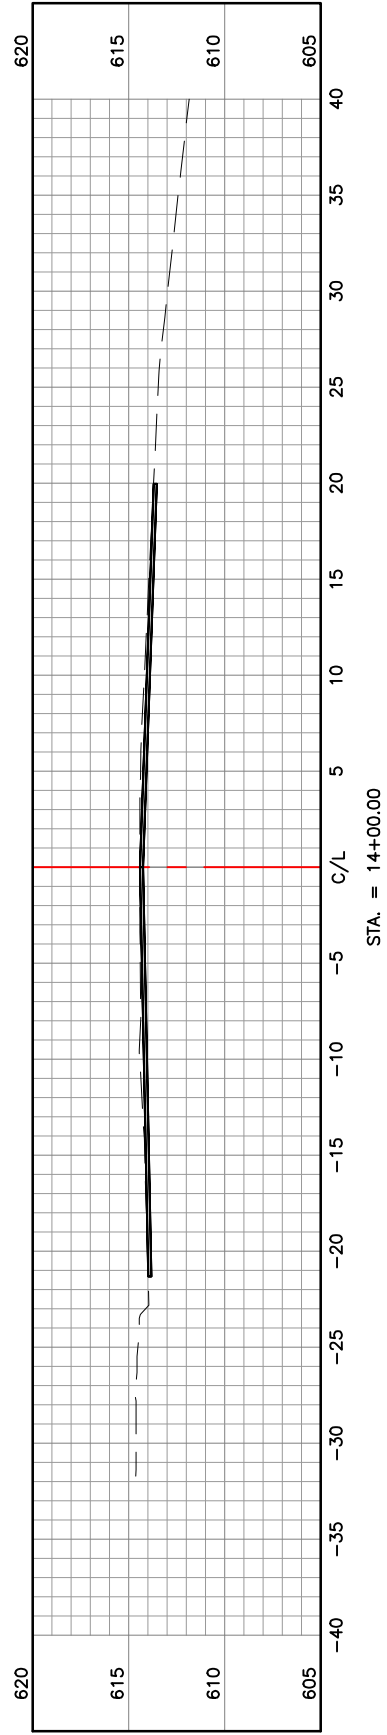
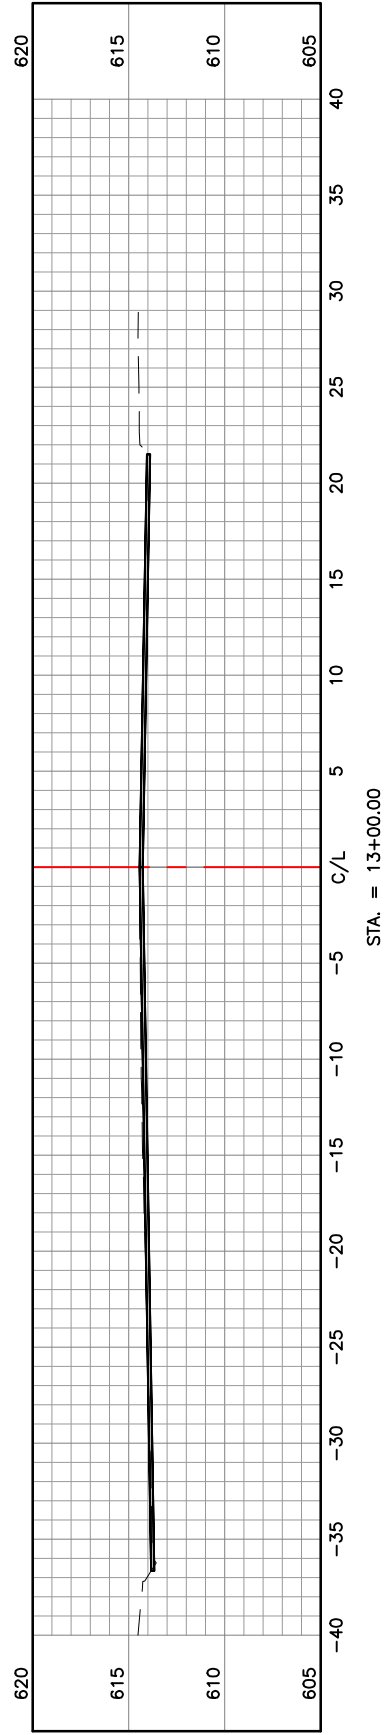
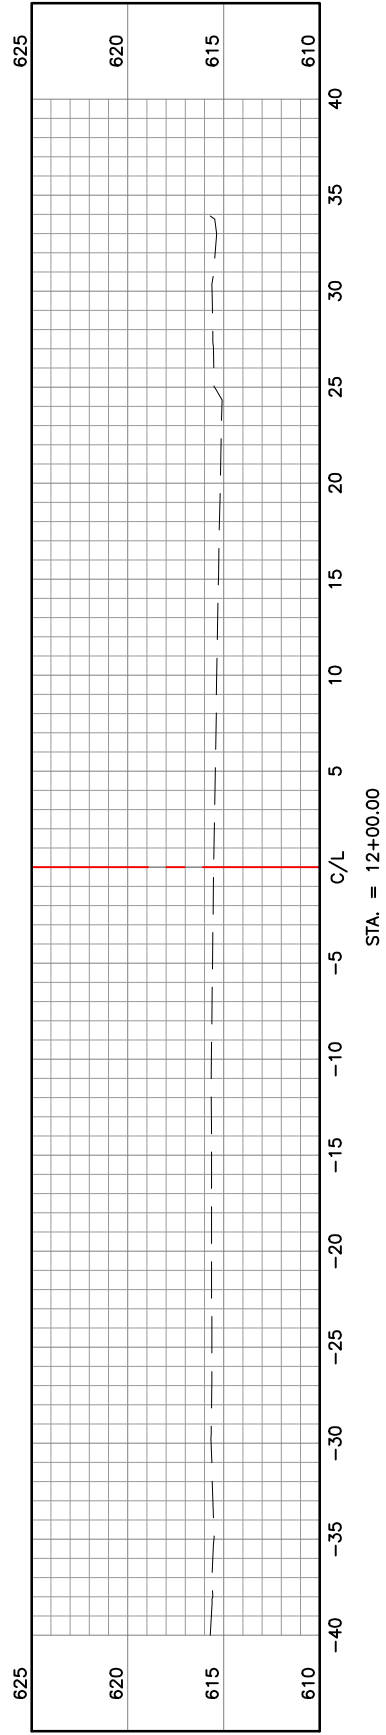
HOLLOWAY ROAD IMPROVEMENTS
FEDERAL PROJECT NO. STP-4939(608)
CITY OF BALLWIN, MISSOURI

DETAILS

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DWN. BY:	K.J.W.	APPD. BY:	M.D.S.
DATE:	JANUARY 2021	SCALE:	AS SHOWN
PROJ. NO.:	SC19-981	DWG. NO.:	DE-18

Drawing name: U:\SC19-981 Holloway Road, Ballwin, MO\AUTOCAD DRAWINGS\DETAILS.dwg Tab: DE-18 Plotted on: Feb 09, 2021 10:34am Plotted by: kwloff

CROSS SECTIONS



CROSS SECTIONS	
DATE:	REVISION:
DWN. BY:	APPD. BY:
K.J.W.	M.D.S.
DATE:	
JANUARY 2021	
SCALE:	
1" = 10'	
PROJ. NO.:	
SC19-981	
DWG. NO.:	
XS-1	

HOLLOWAY ROAD IMPROVEMENTS
FEDERAL PROJECT NO. STP-4939(608)
CITY OF BALLWIN, MISSOURI

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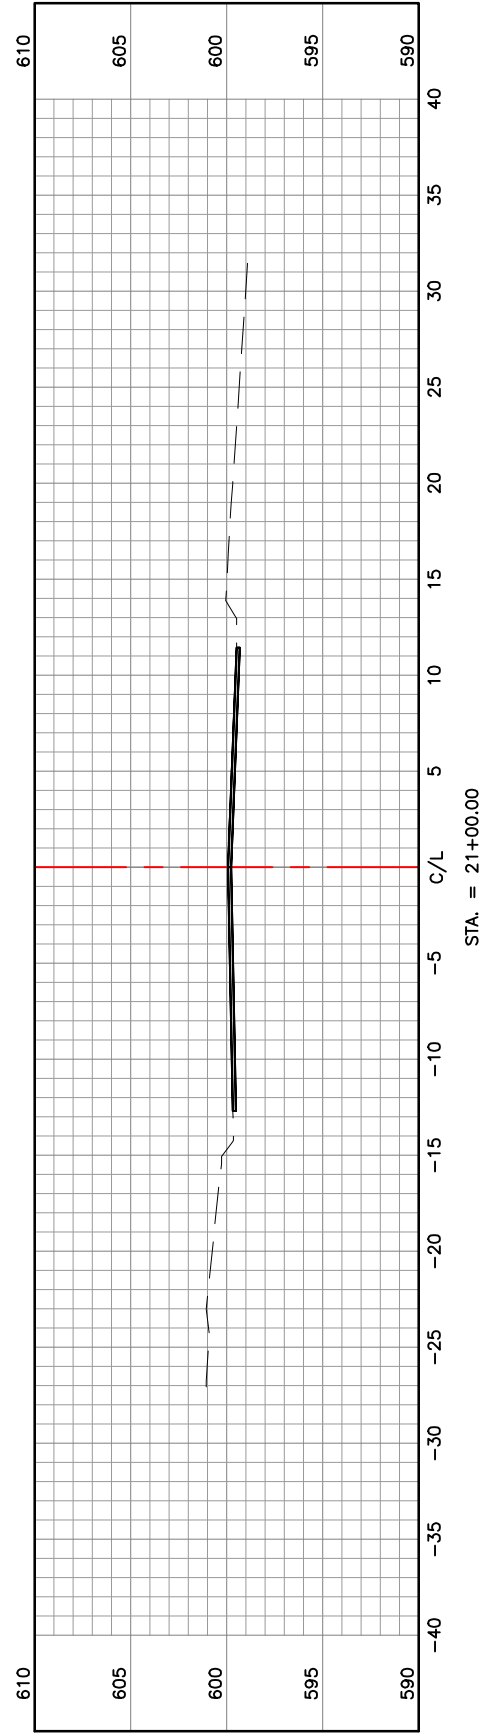
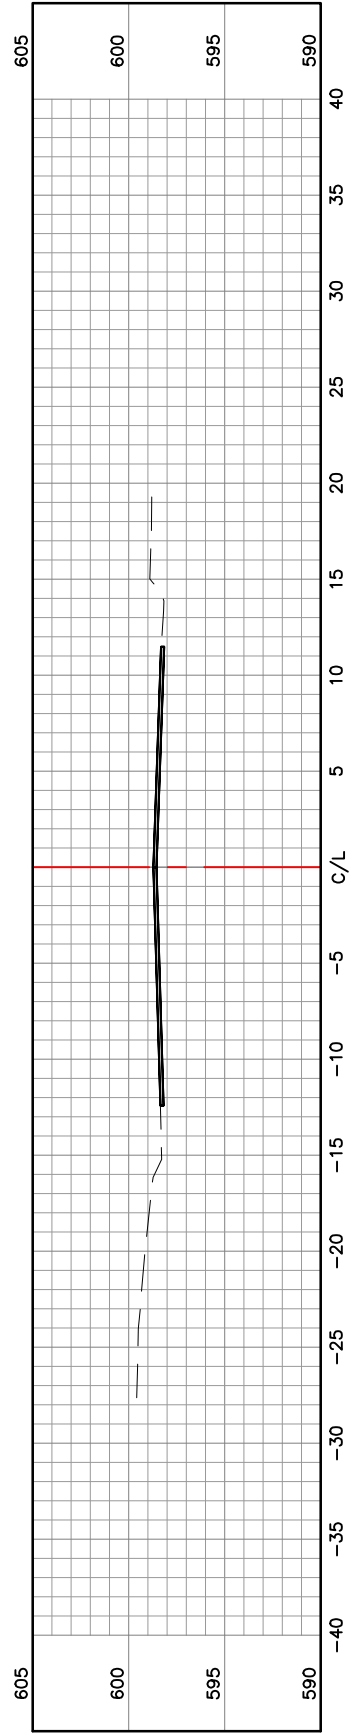
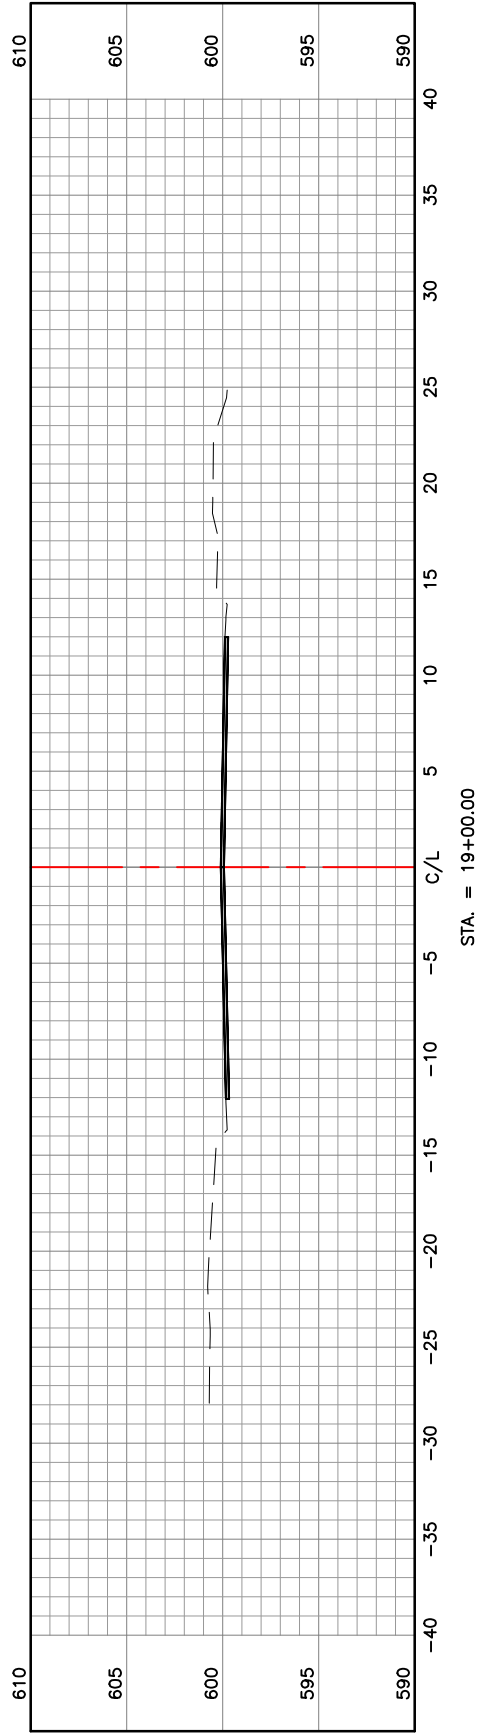
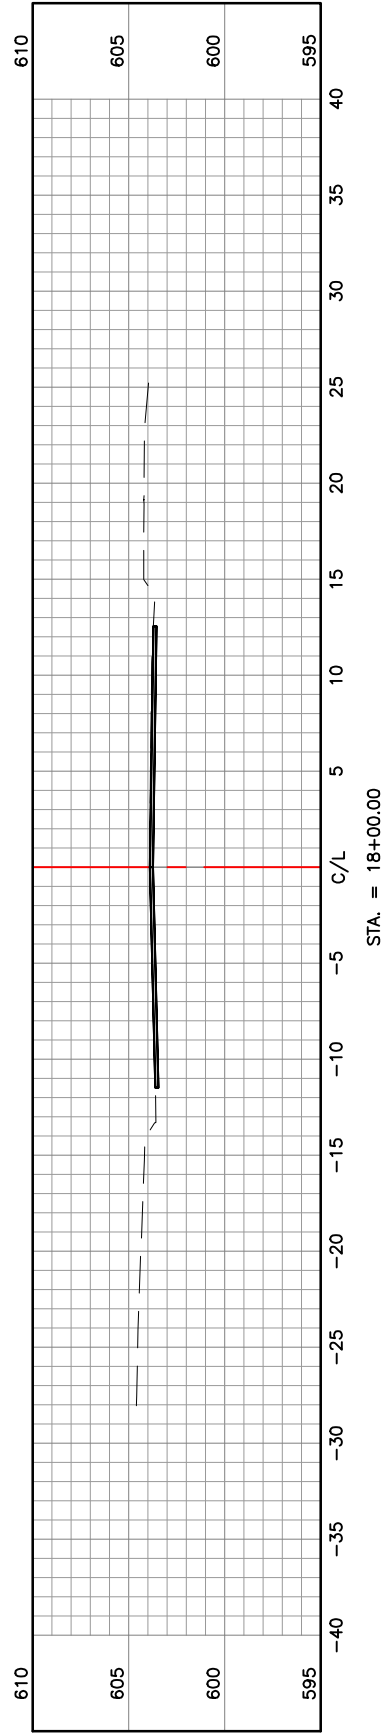
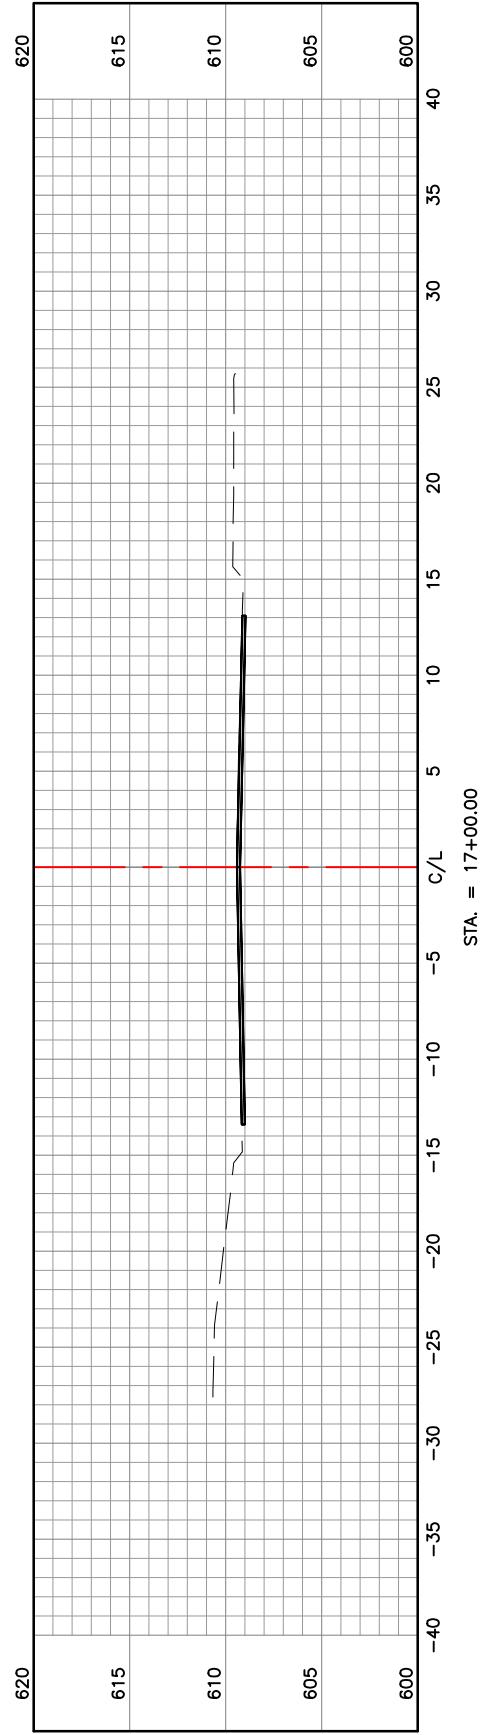
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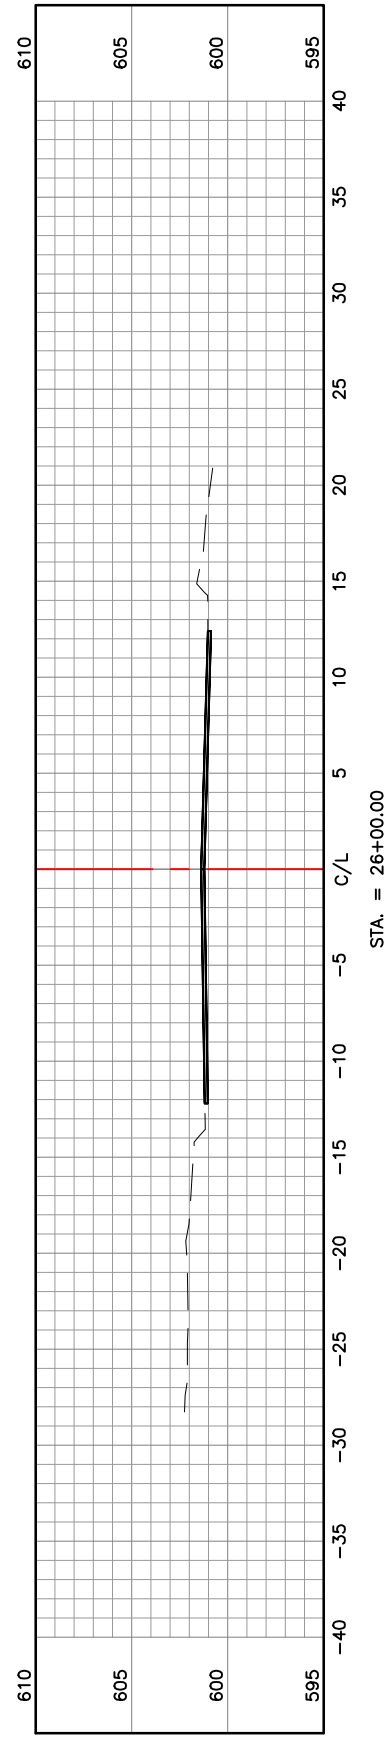
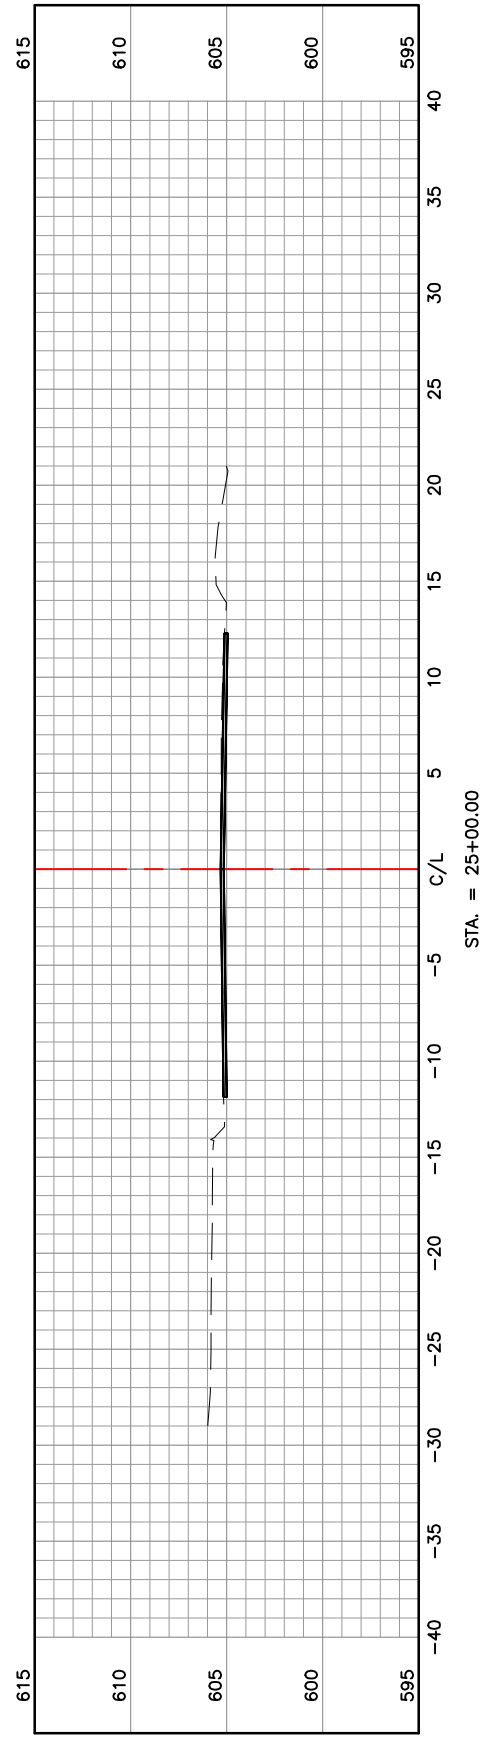
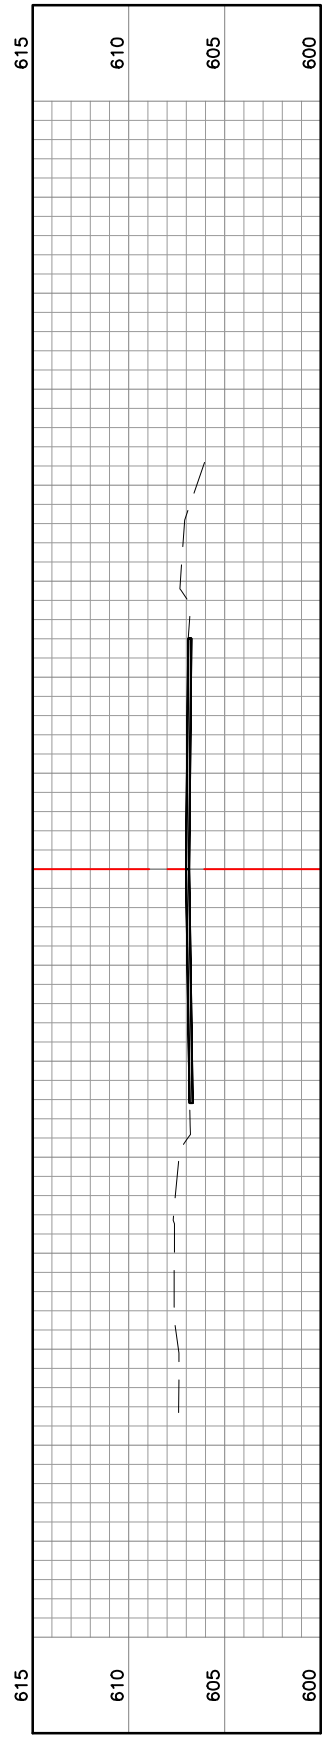
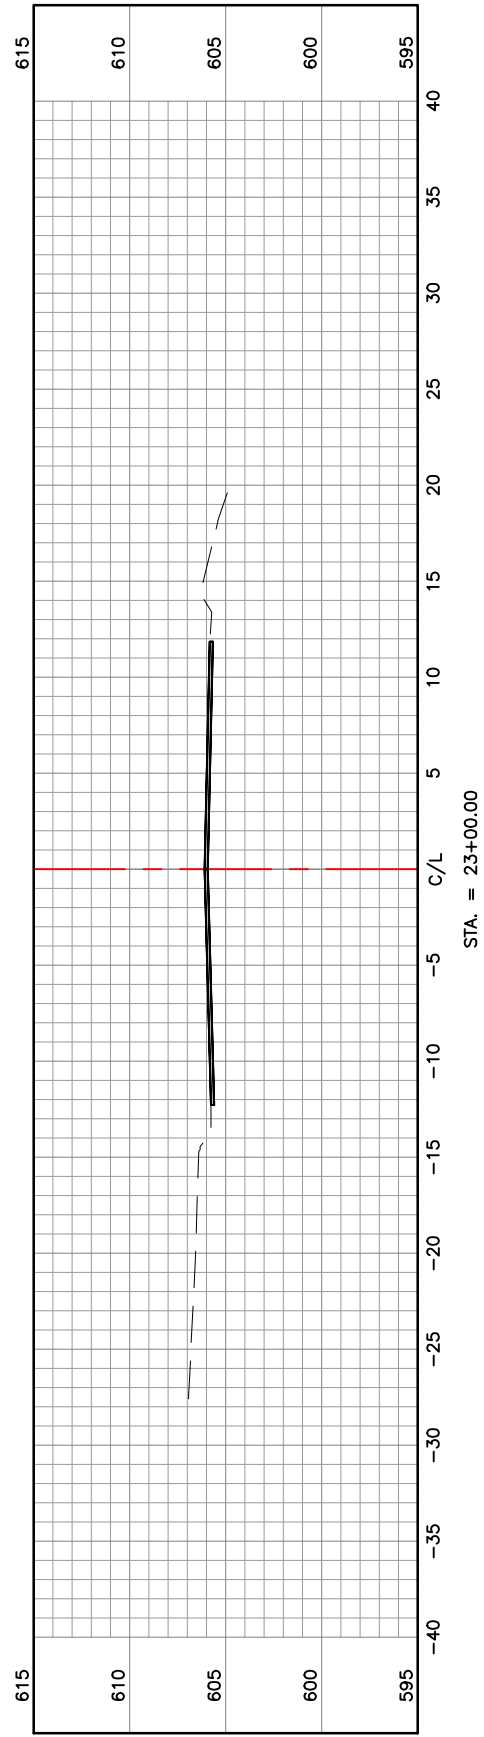
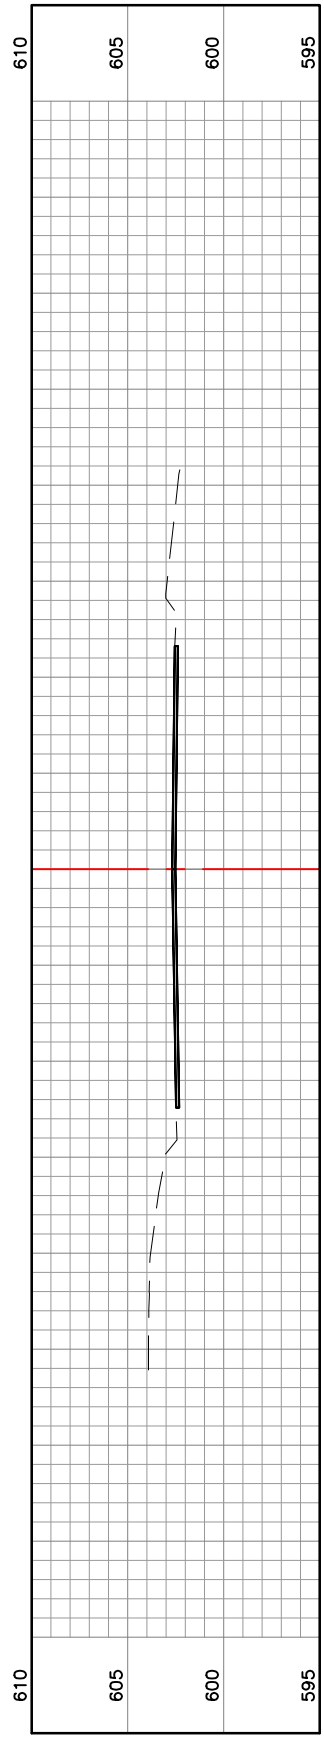
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 APPD. BY: M.D.S.
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 SCALE: 1" = 10'
 PROJ. NO: SC19-981
 DWG. NO:

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SCALE: 1" = 10'	
PROJ. NO: SC19-981	
DWG. NO: XS-3	

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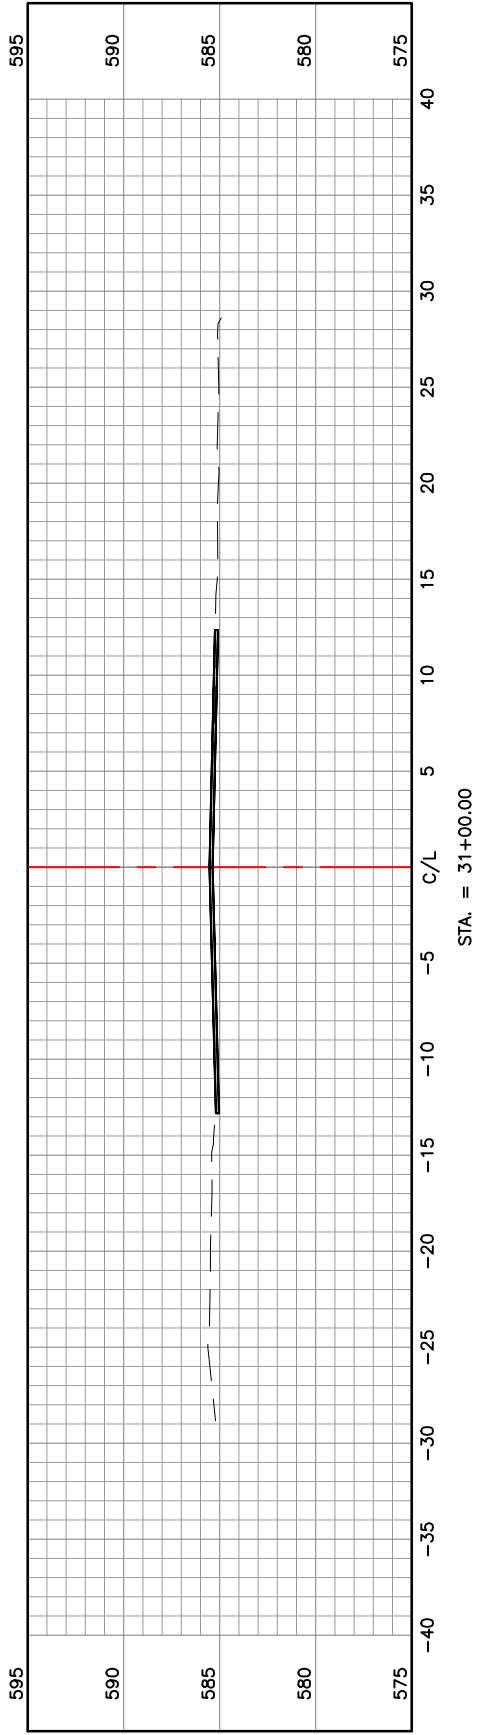
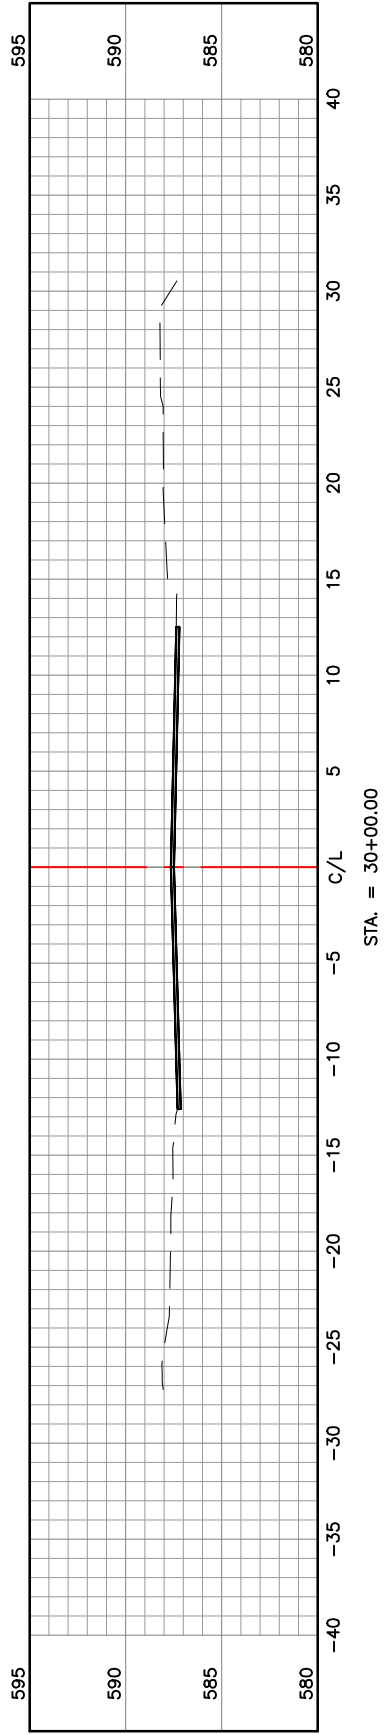
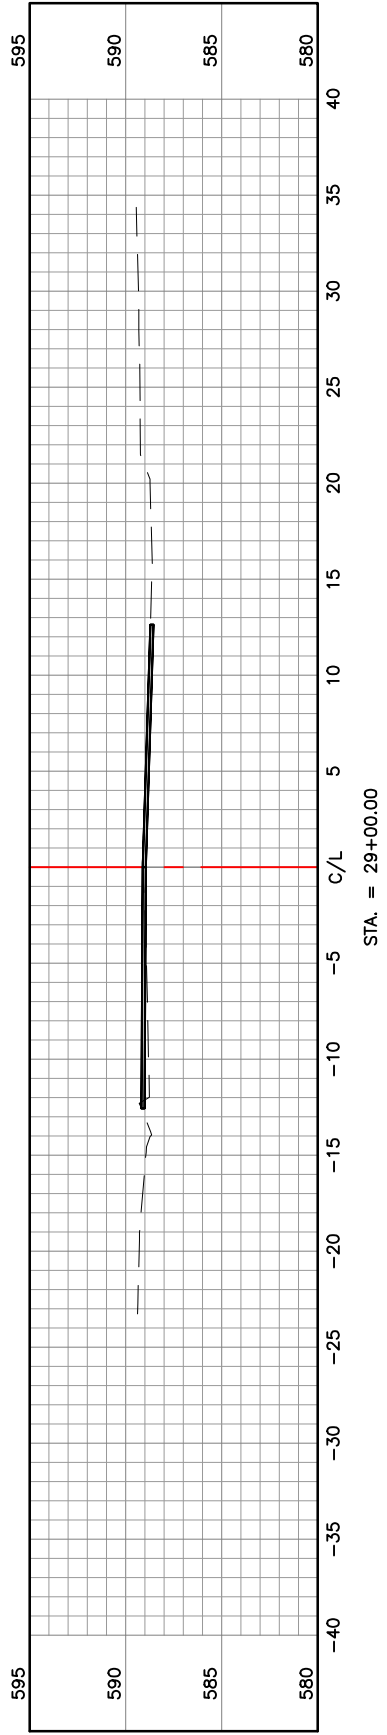
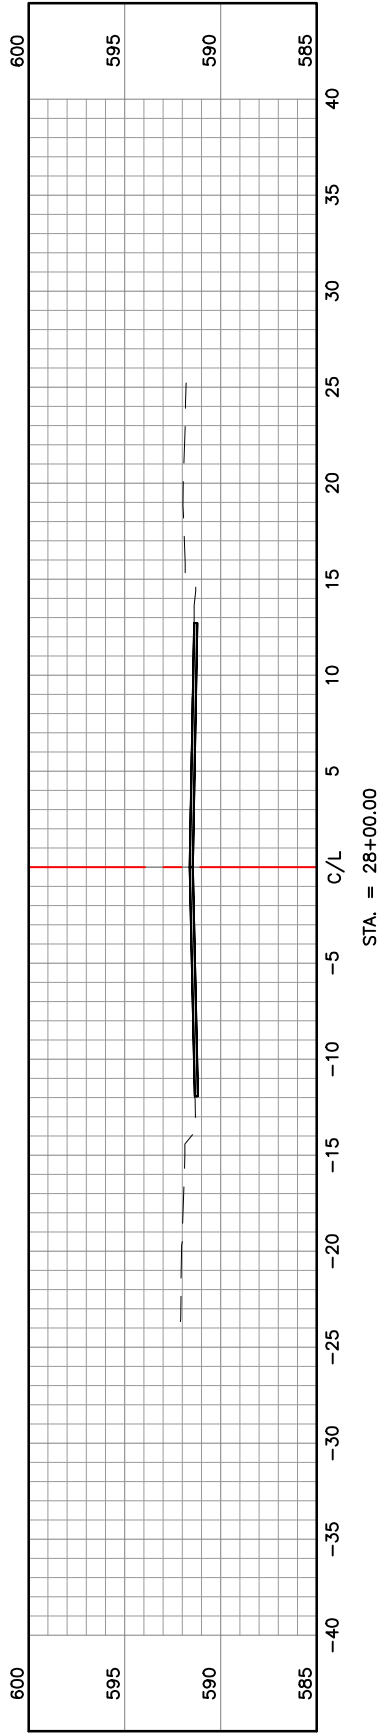
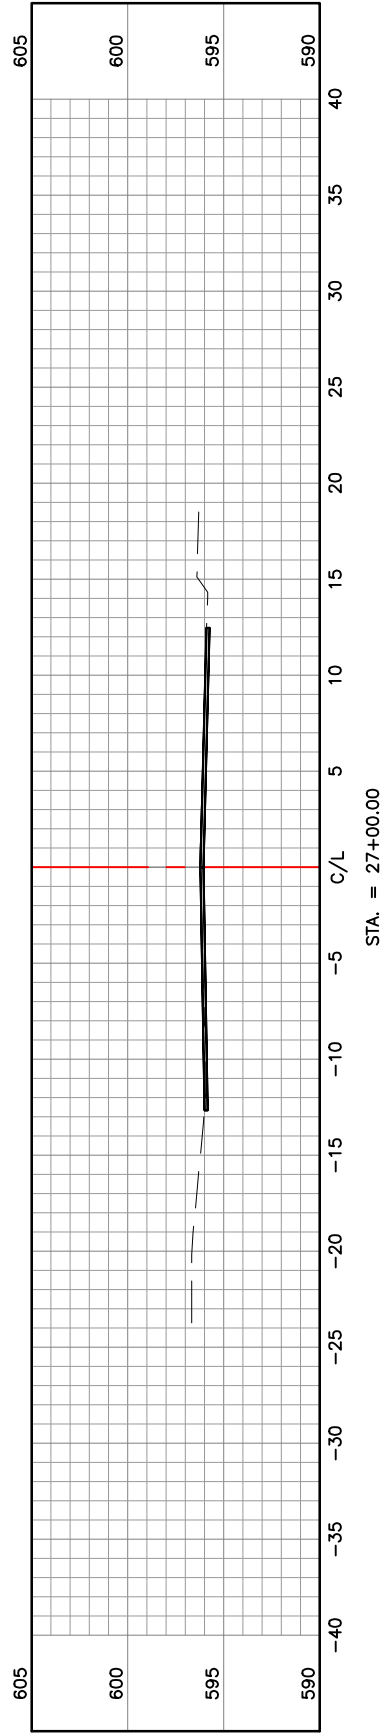


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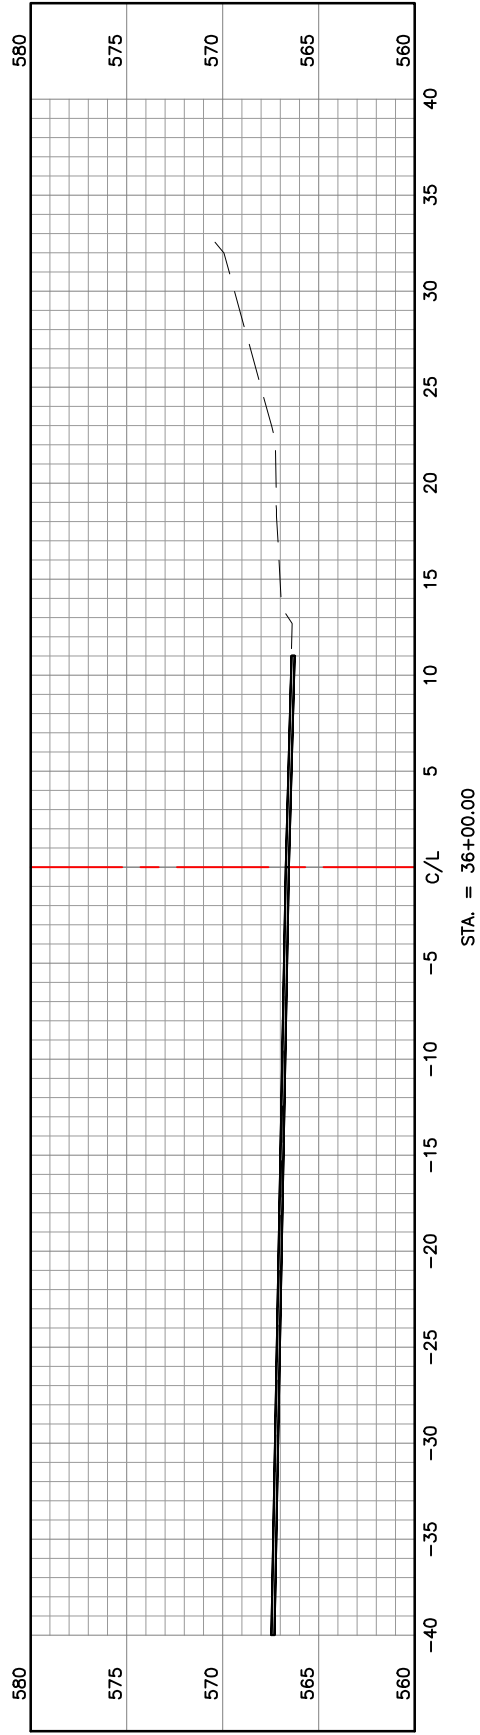
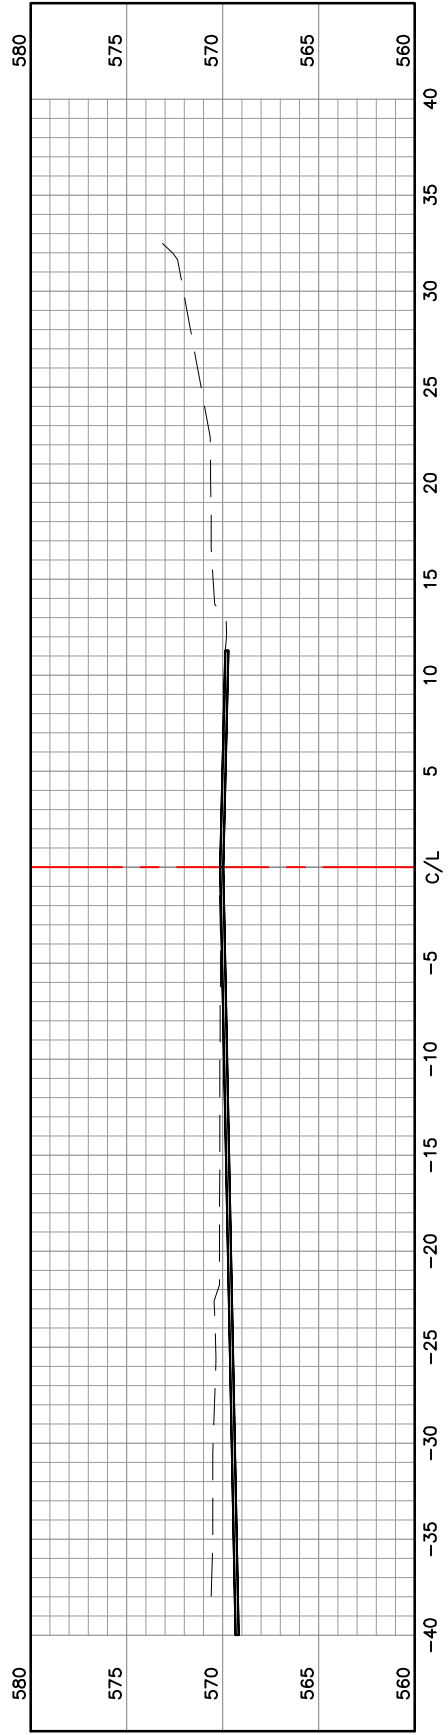
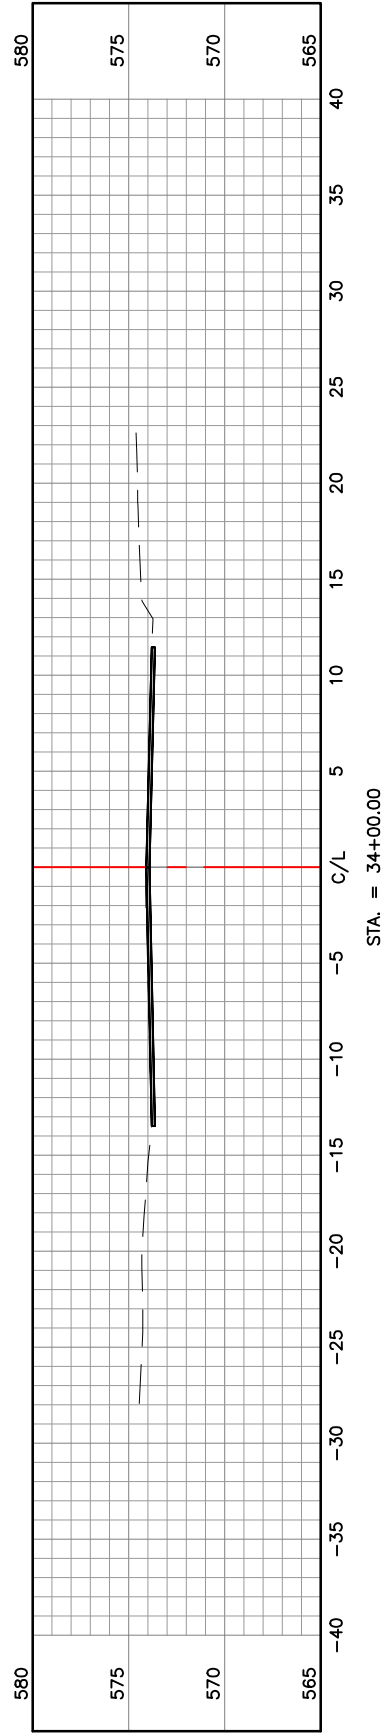
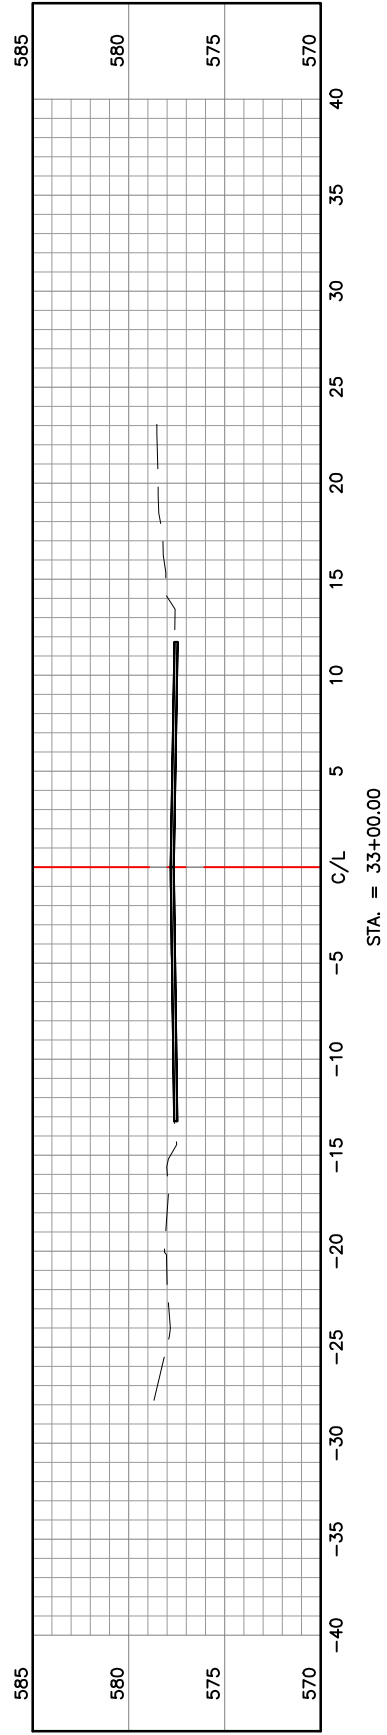
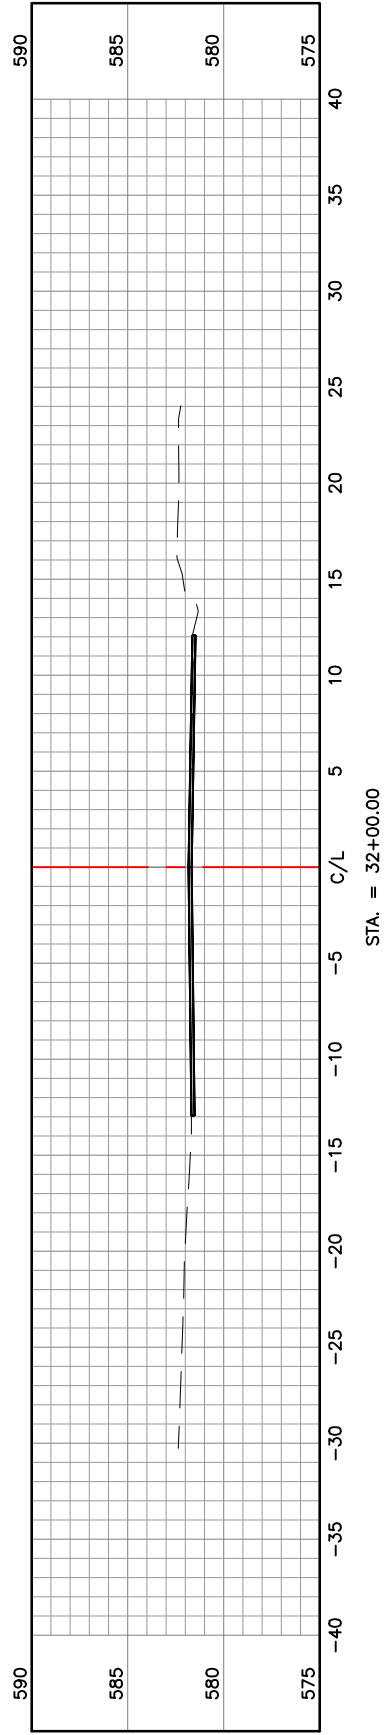
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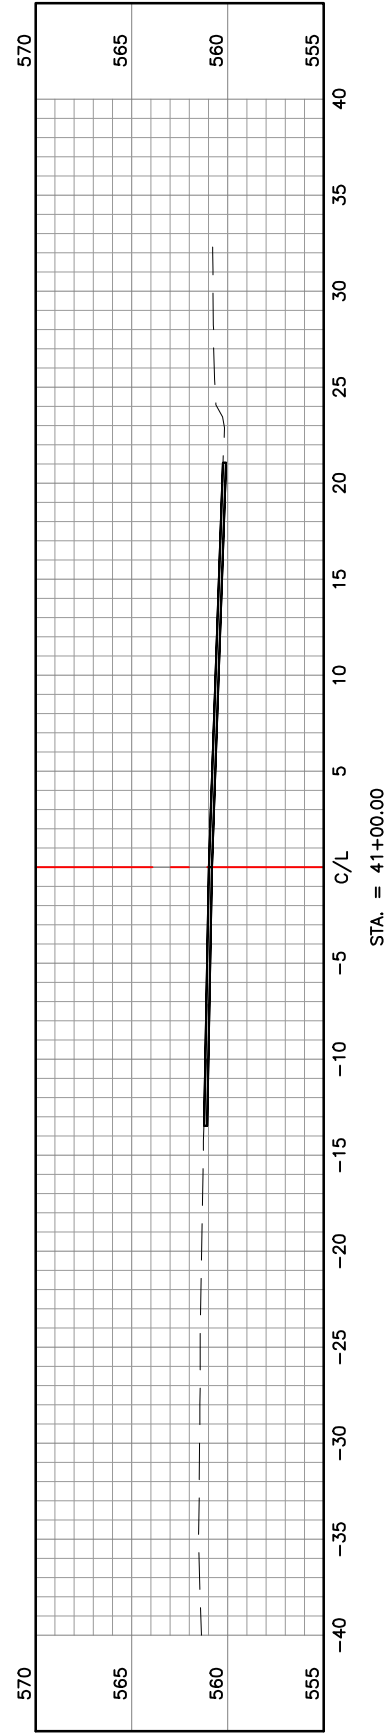
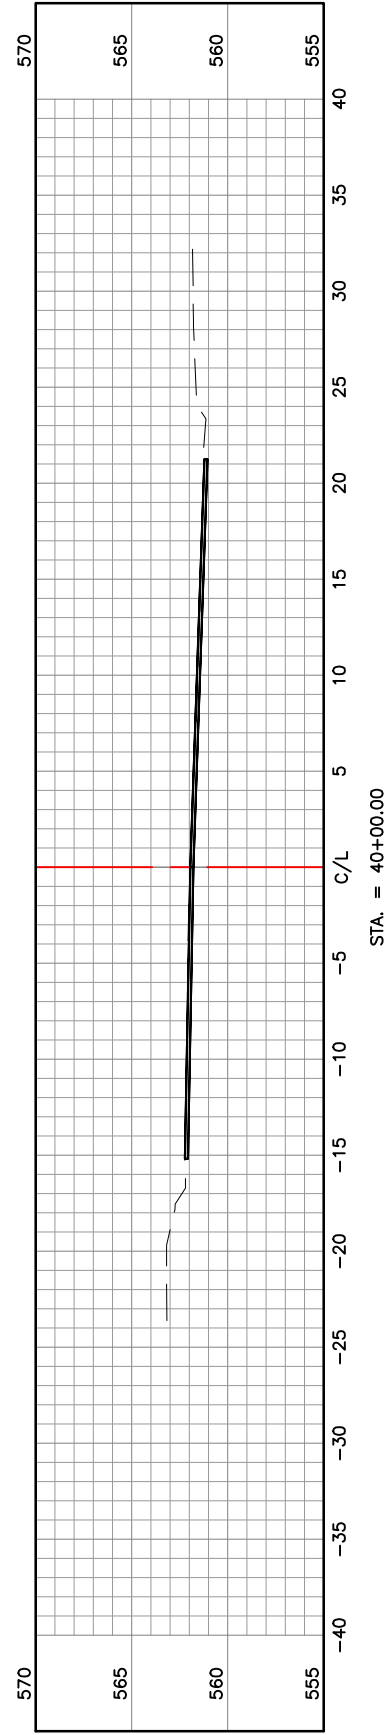
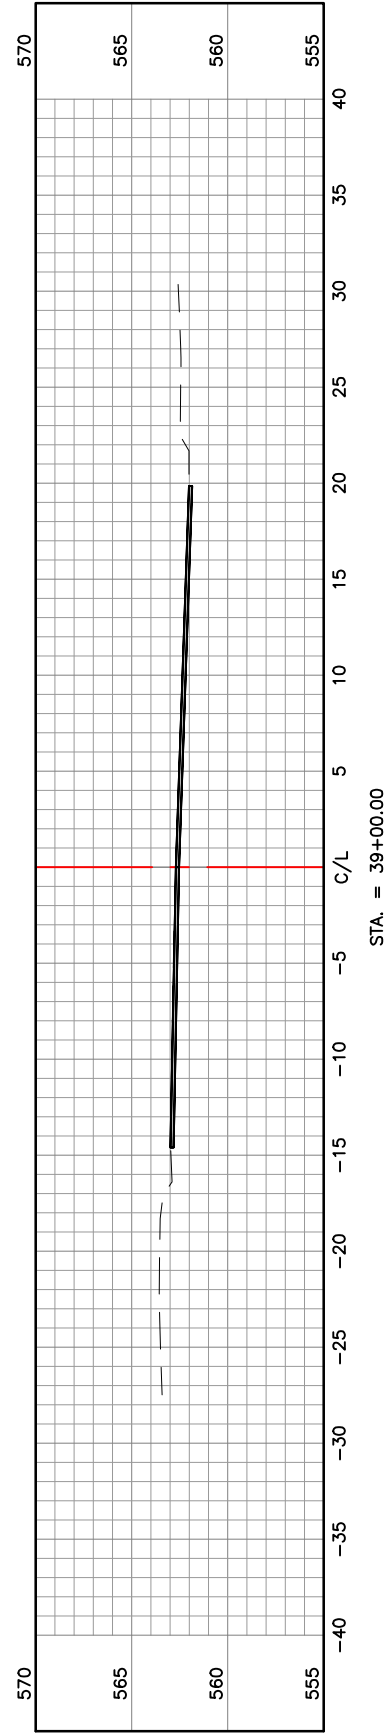
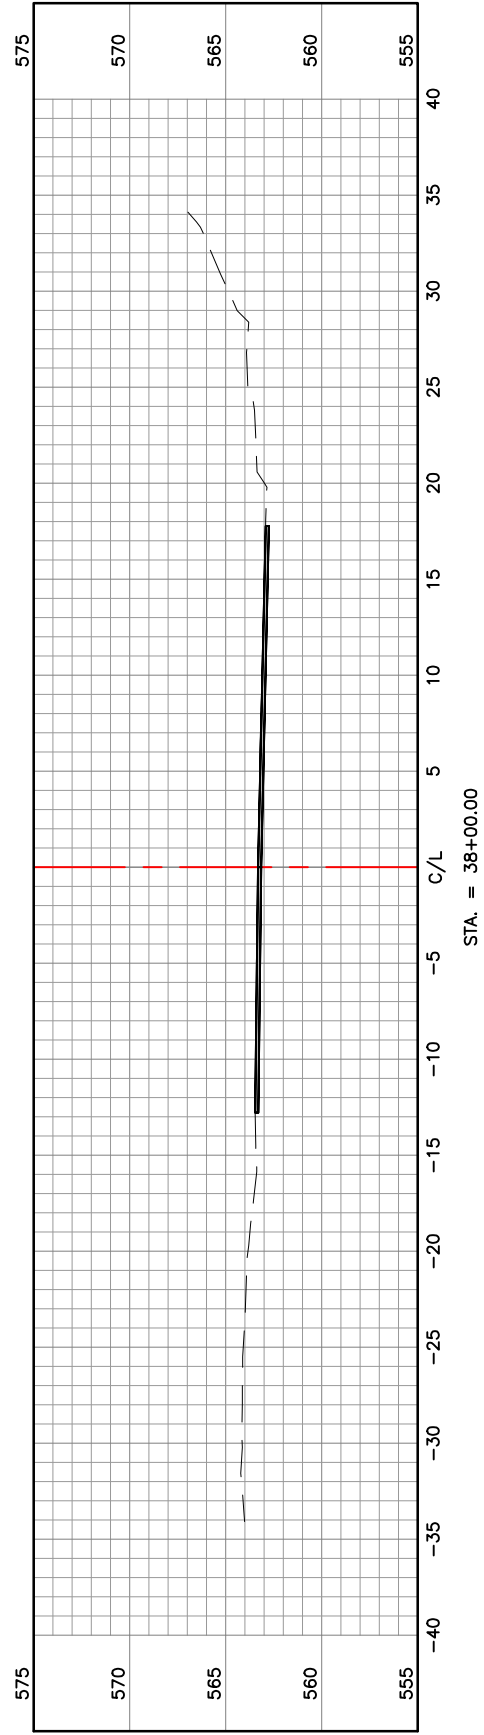
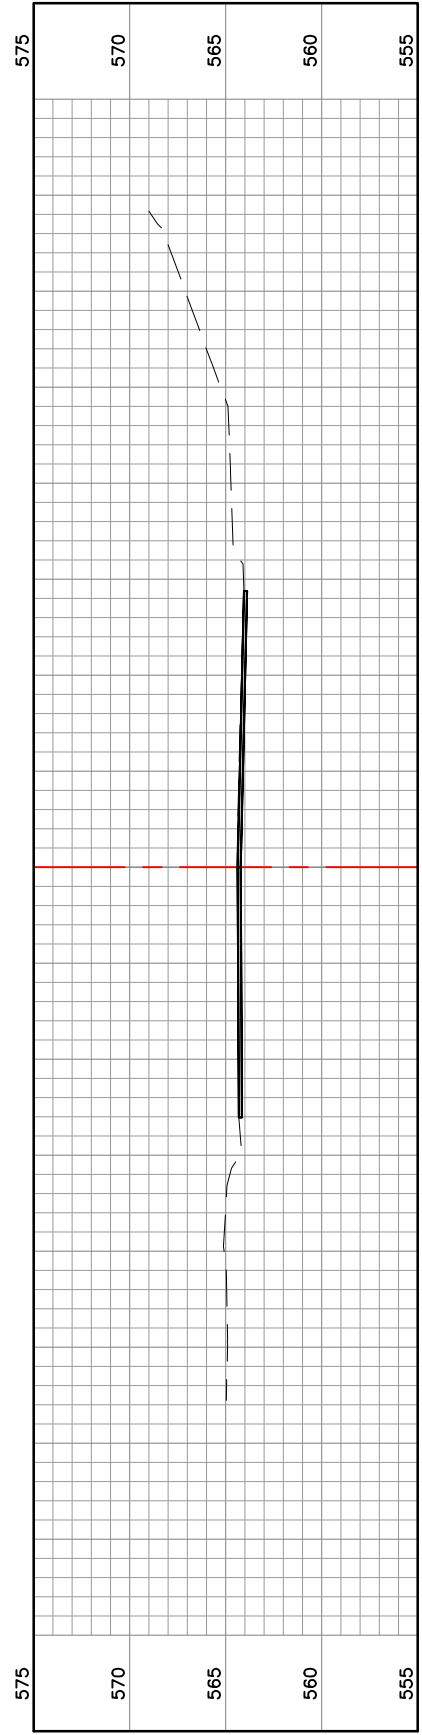
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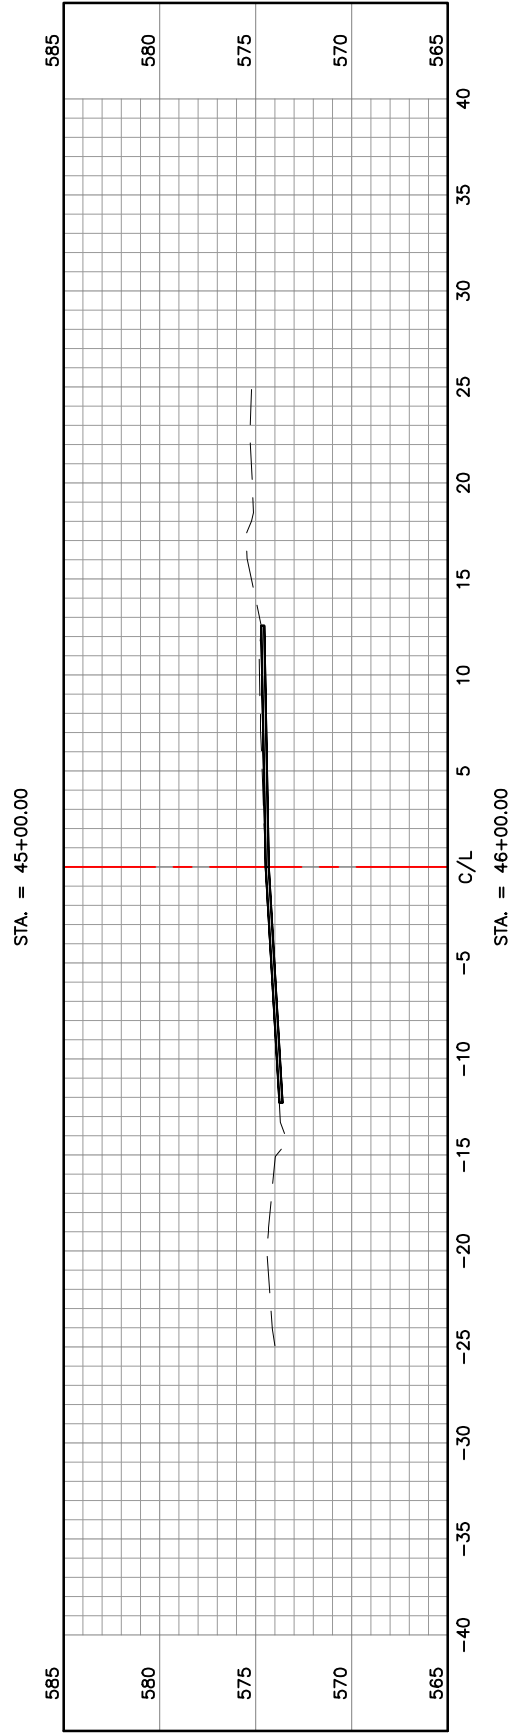
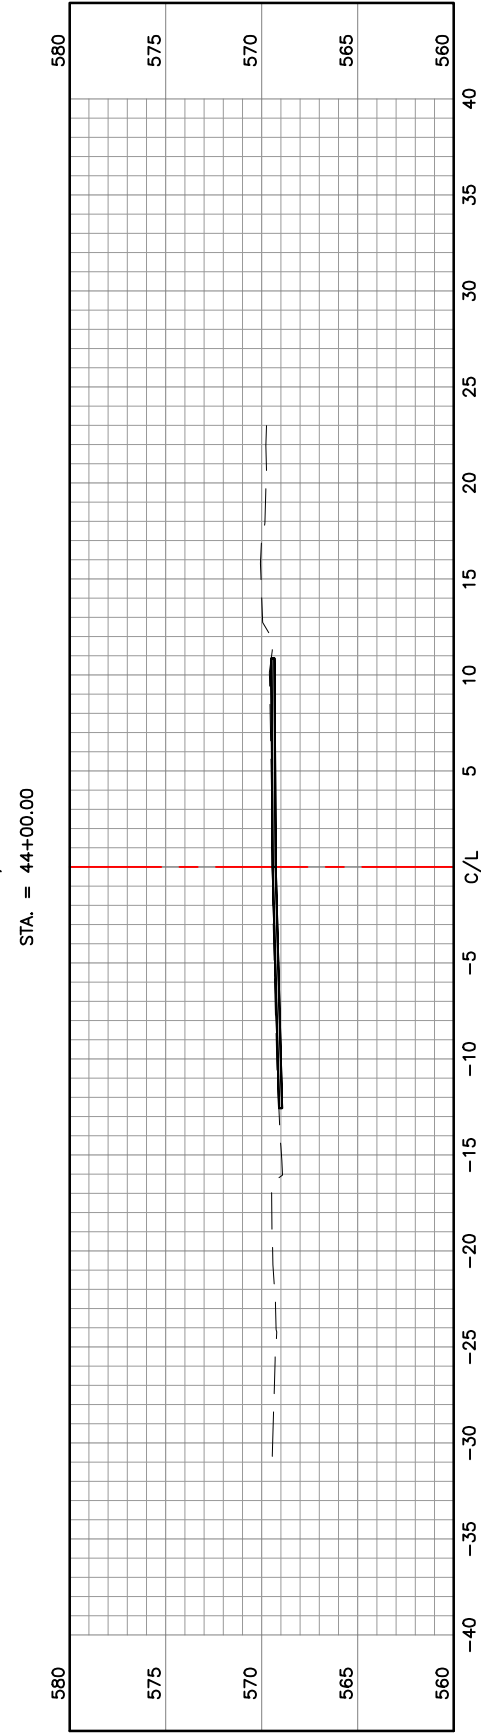
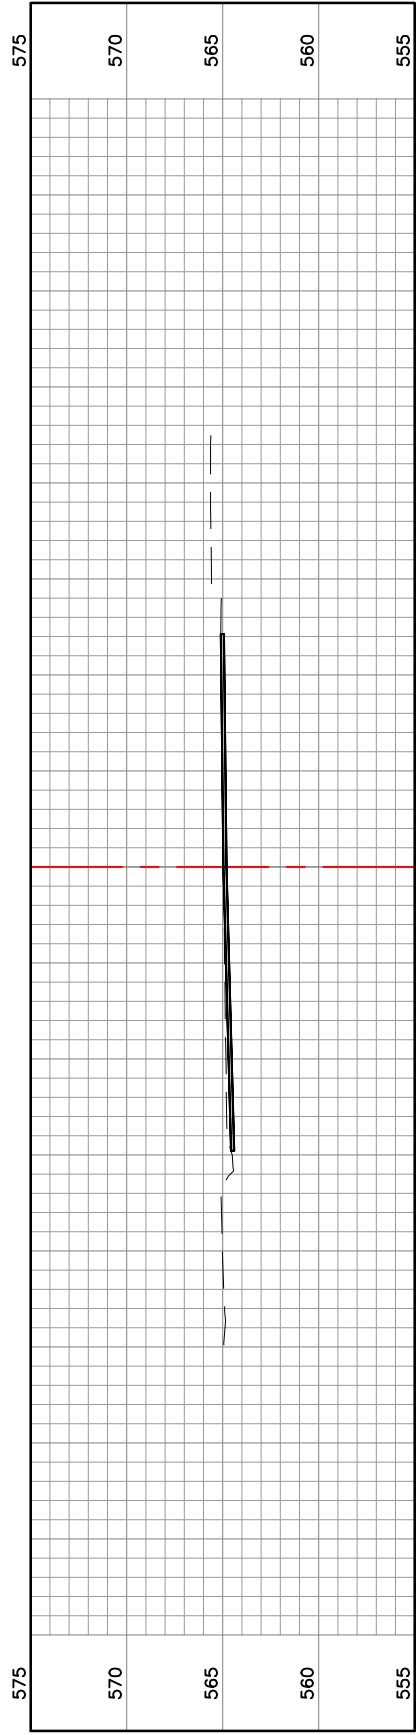
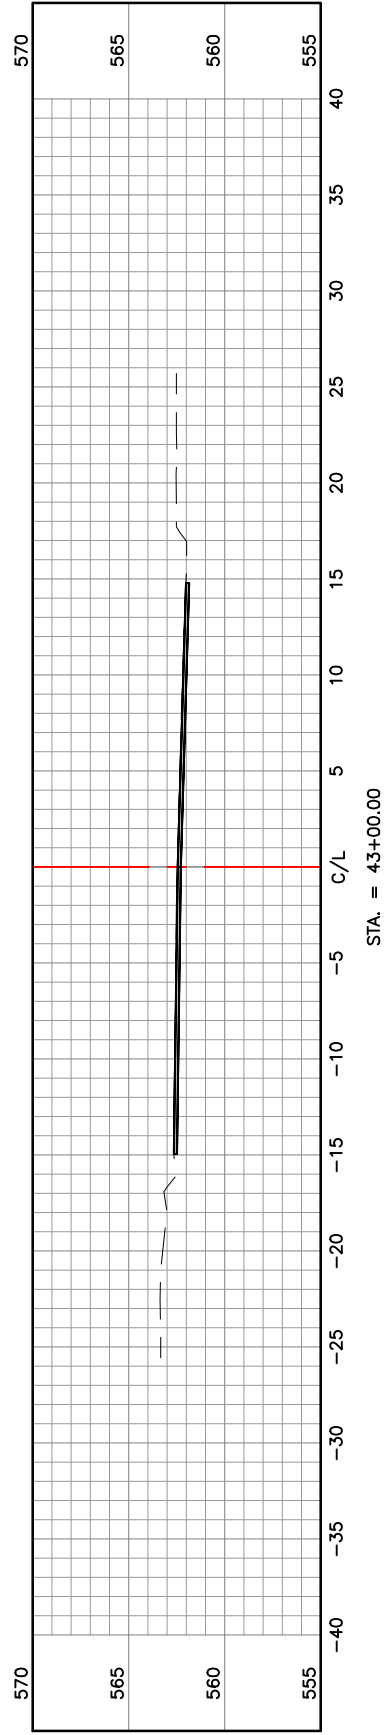
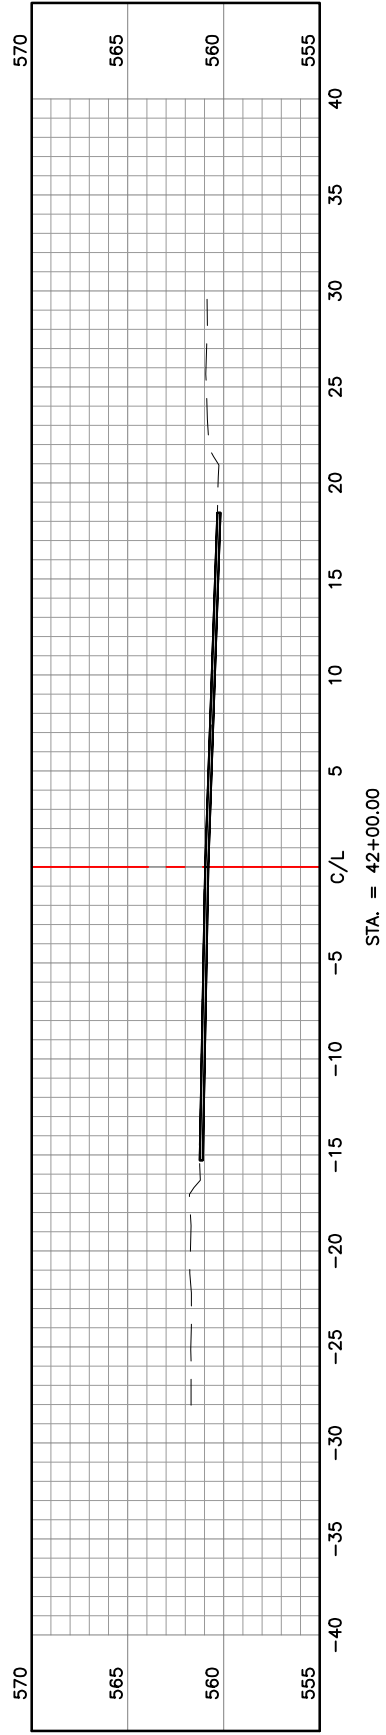
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 PROJ. NO: SC19-981
 DWG. NO: XS-7

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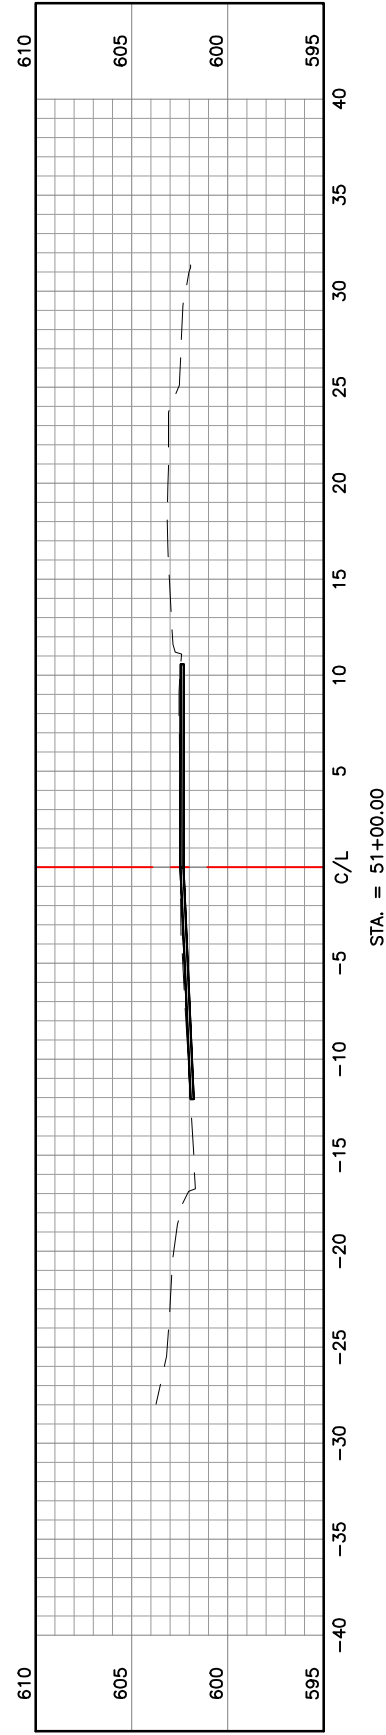
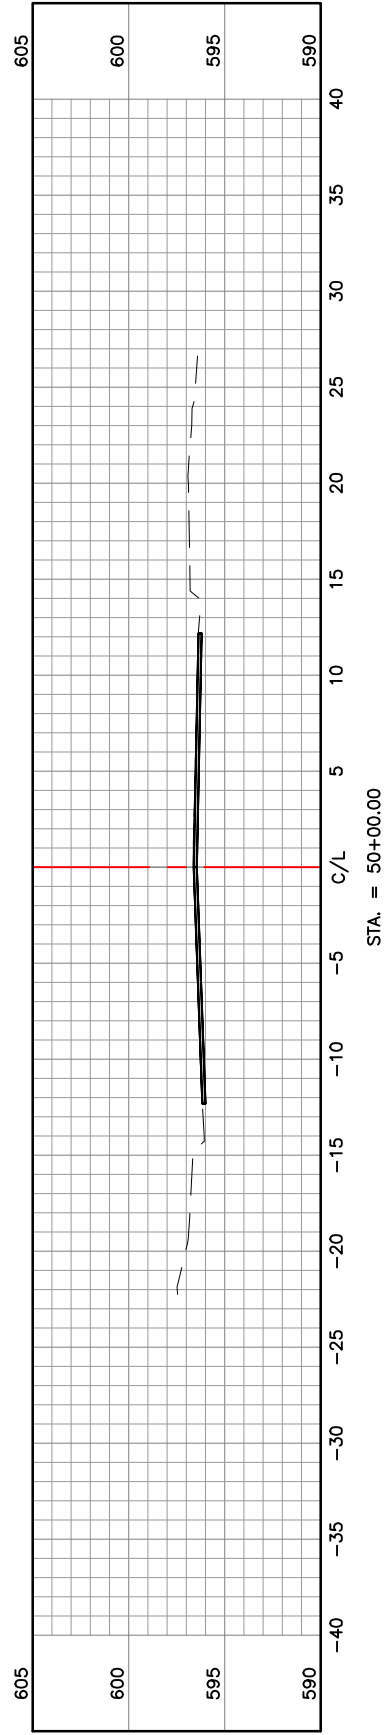
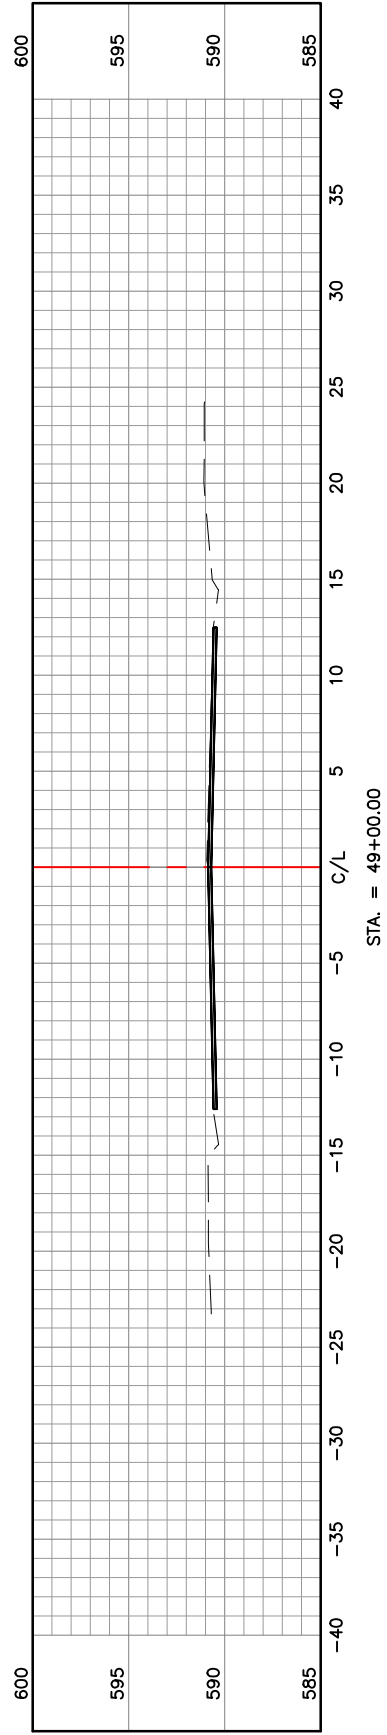
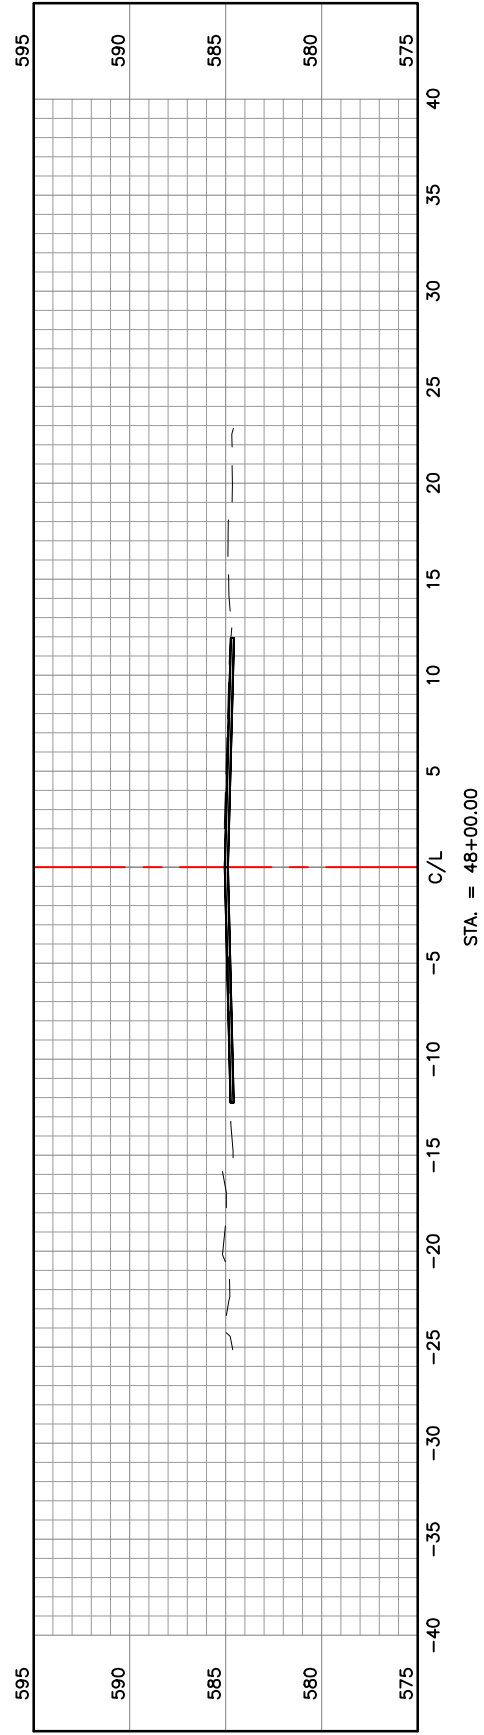
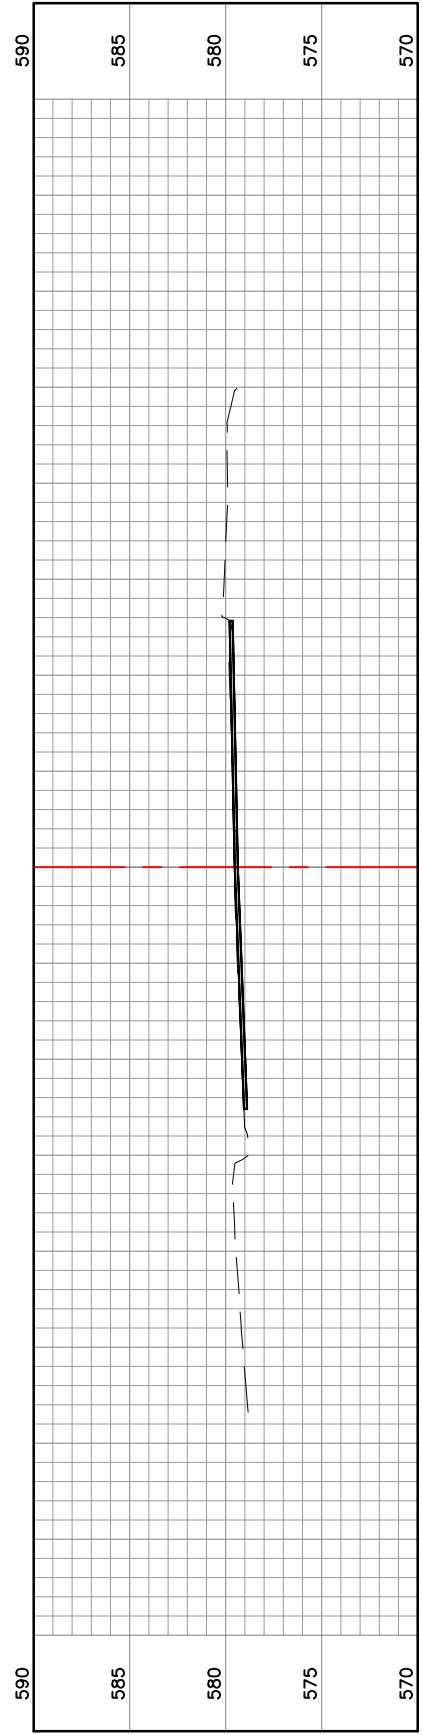
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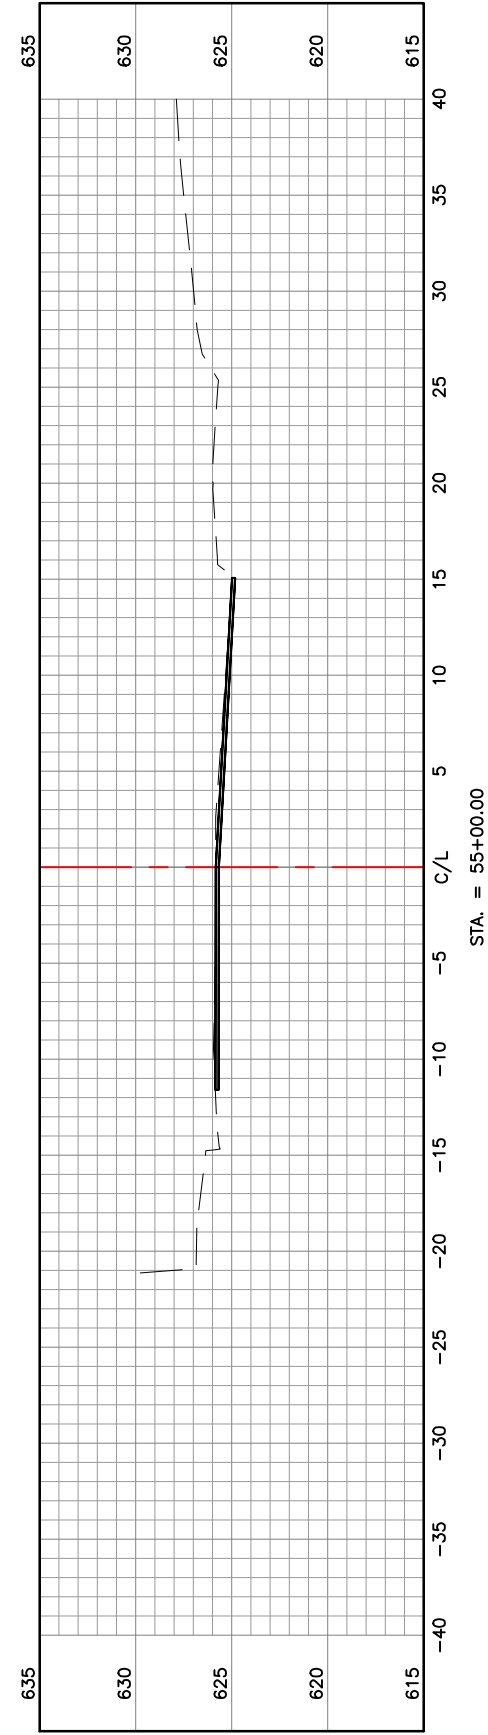
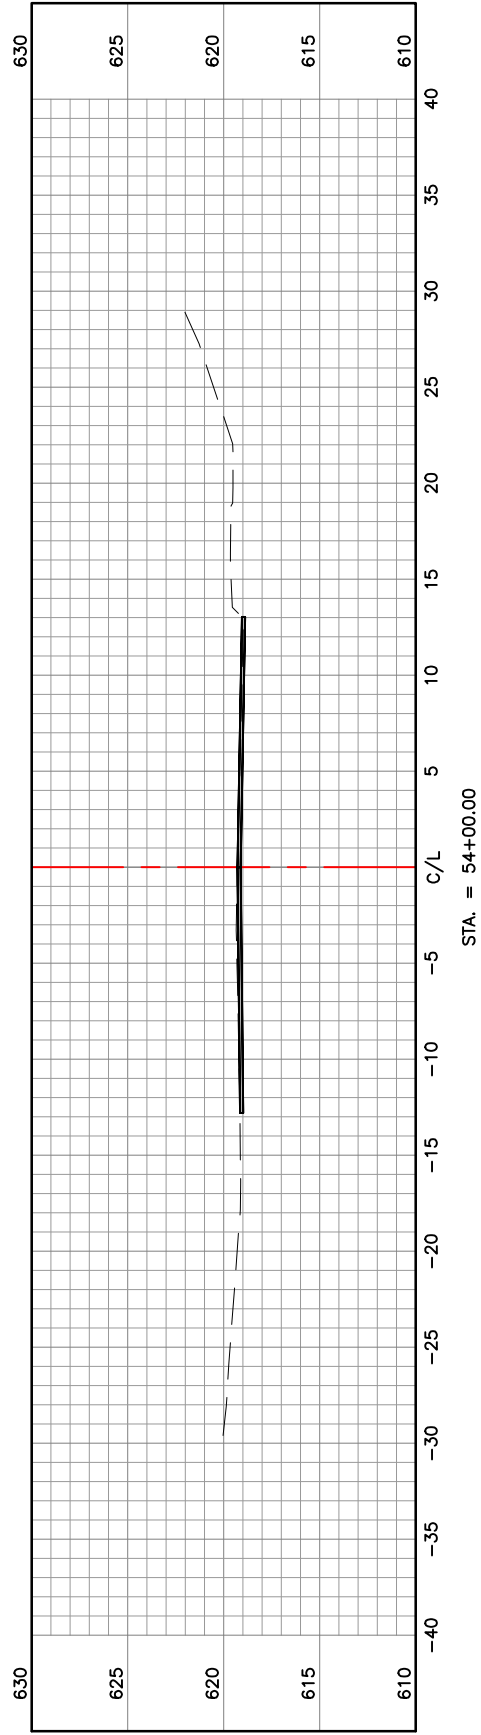
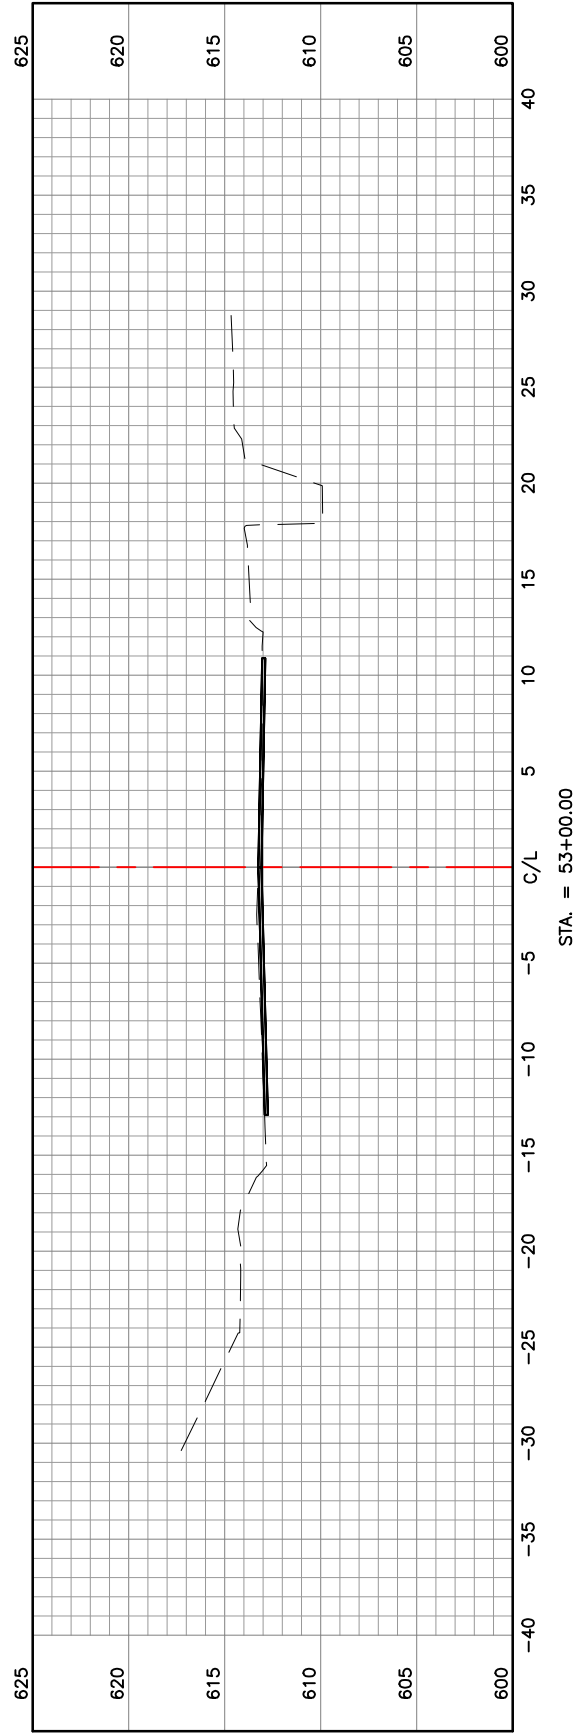
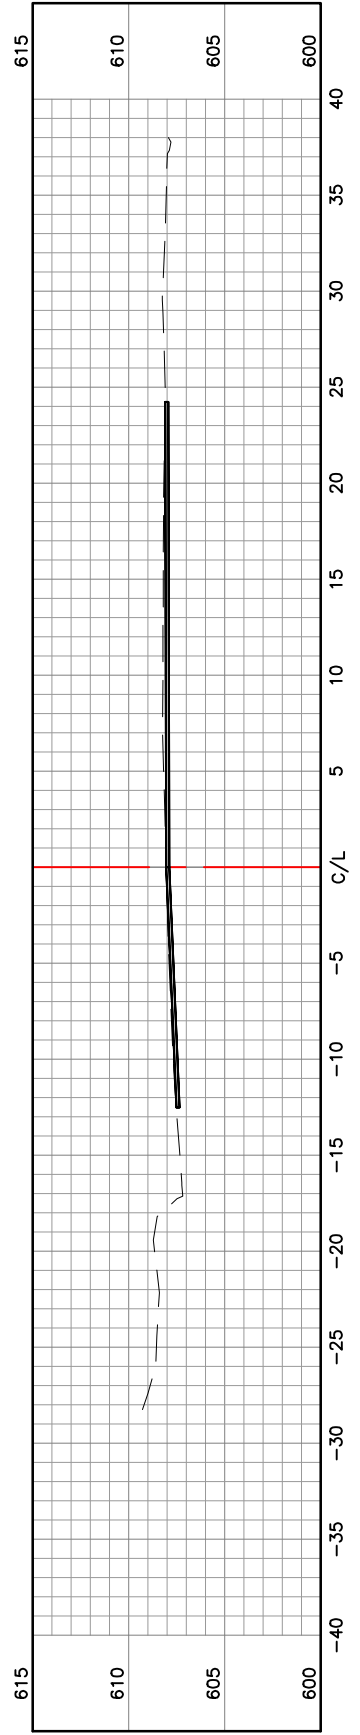
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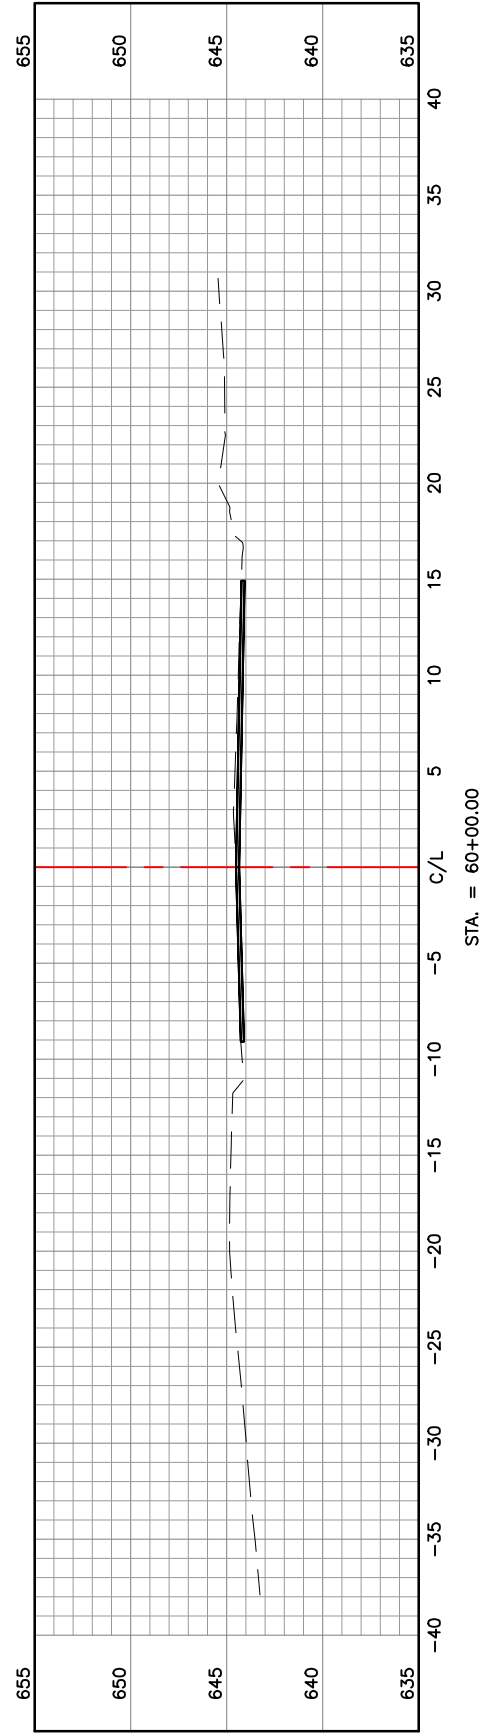
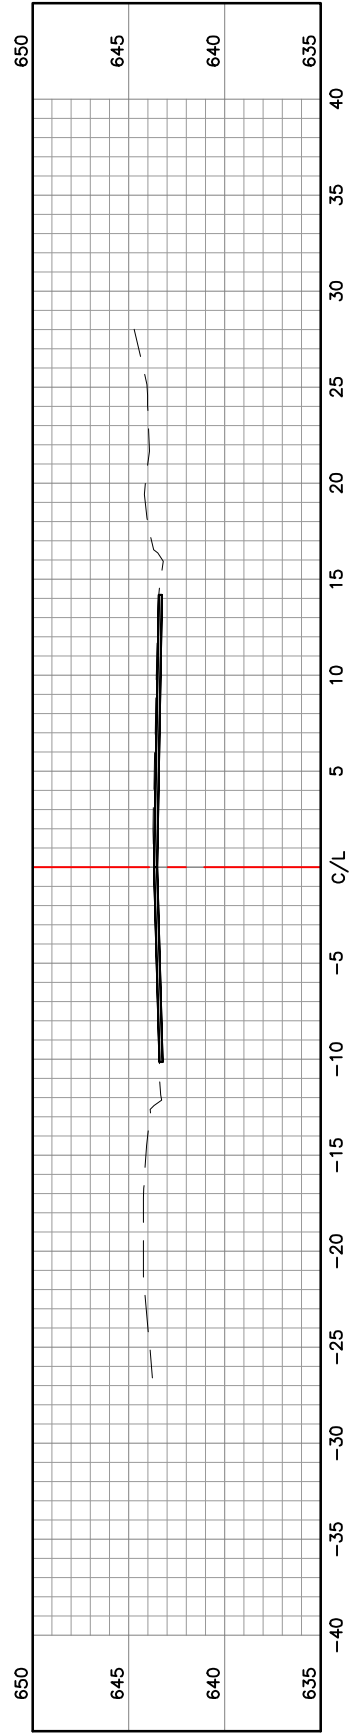
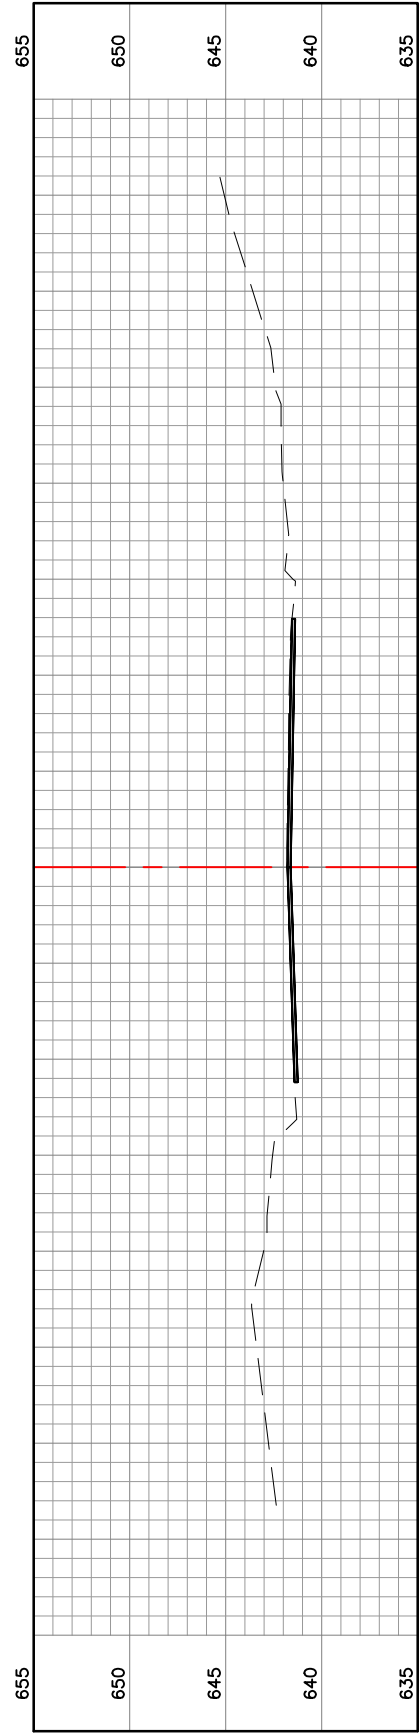
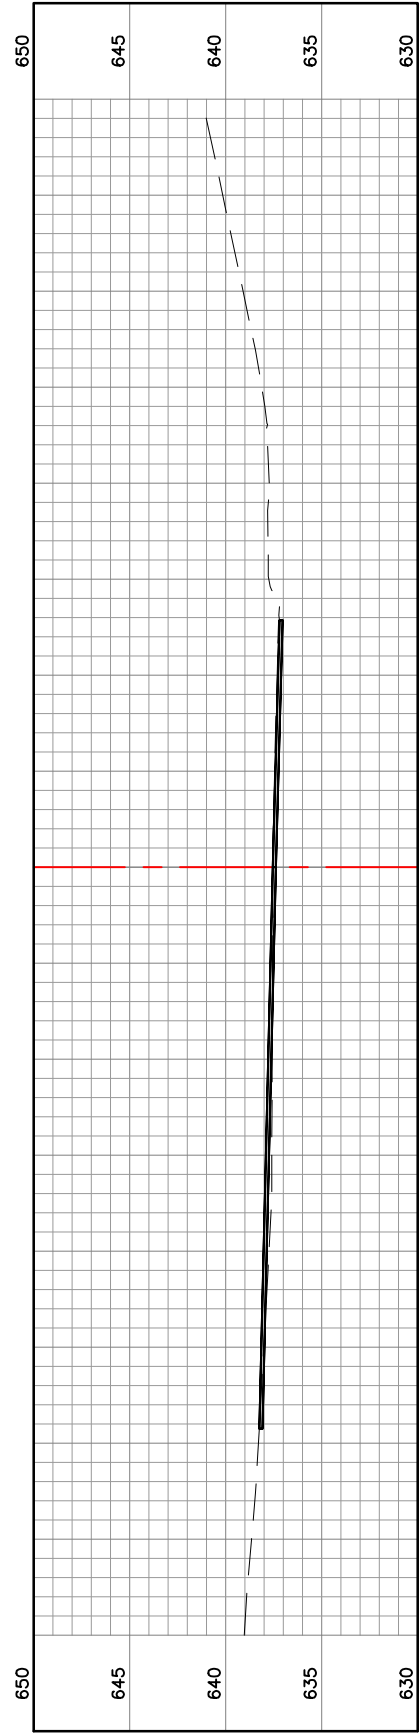
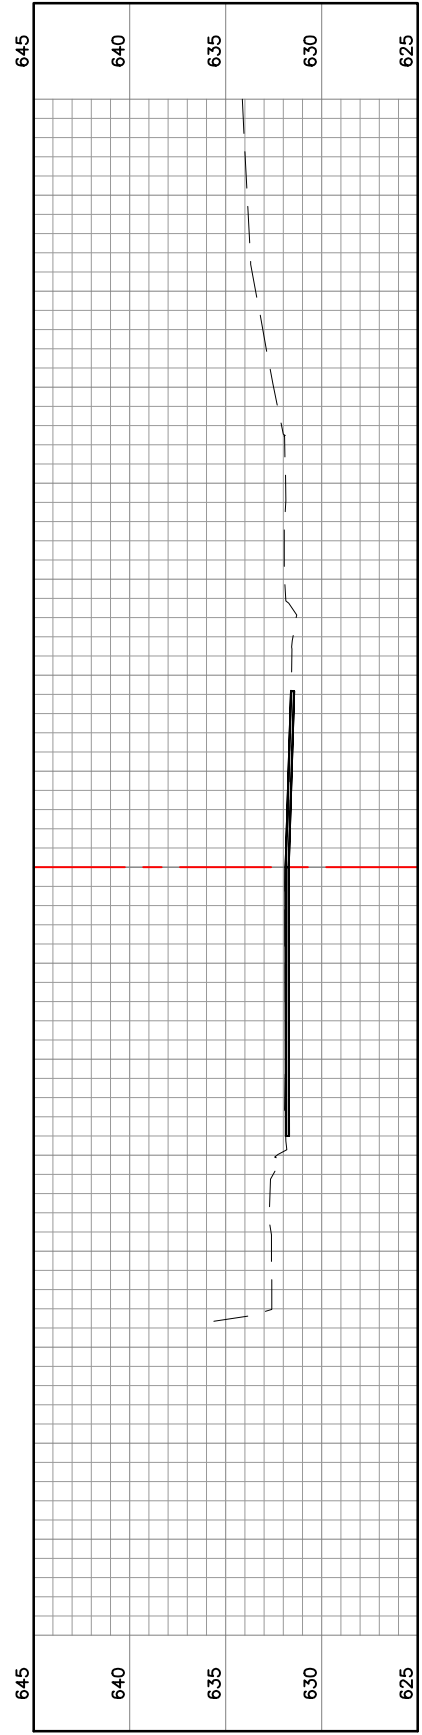


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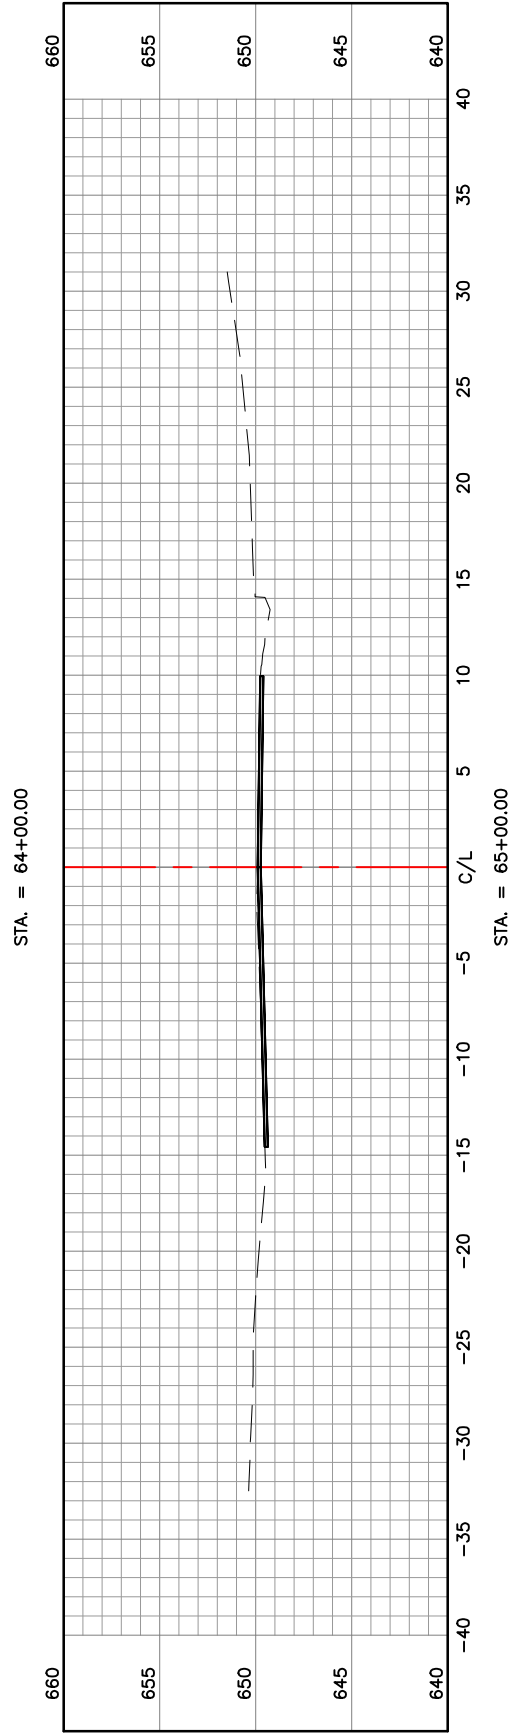
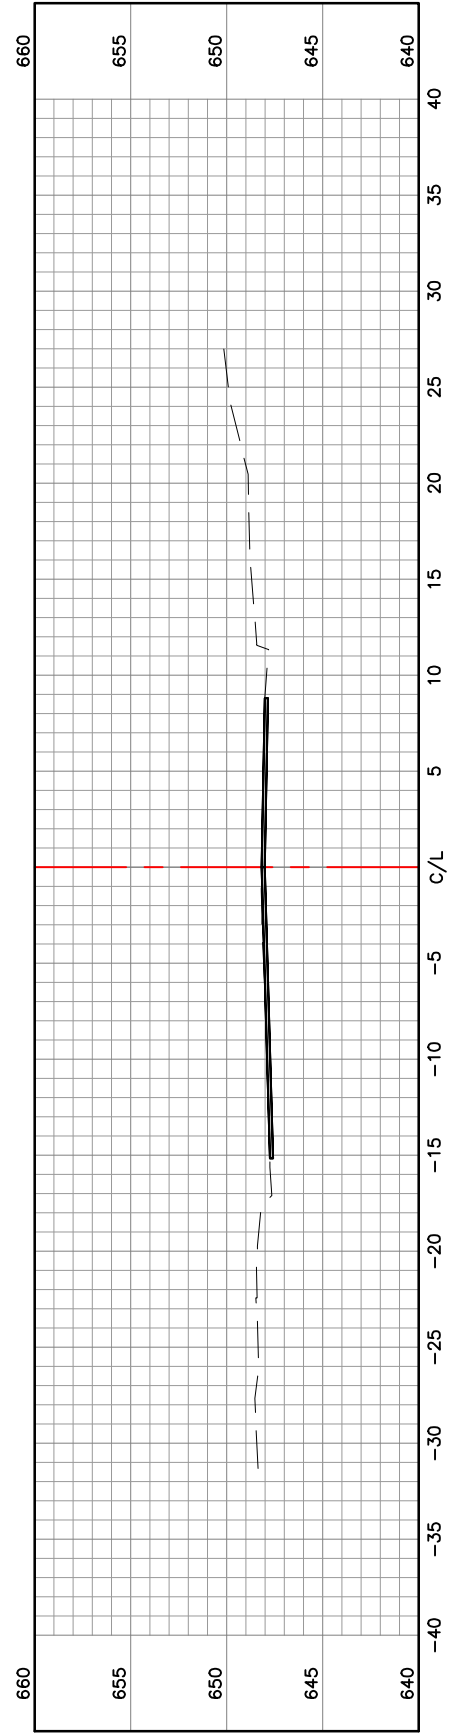
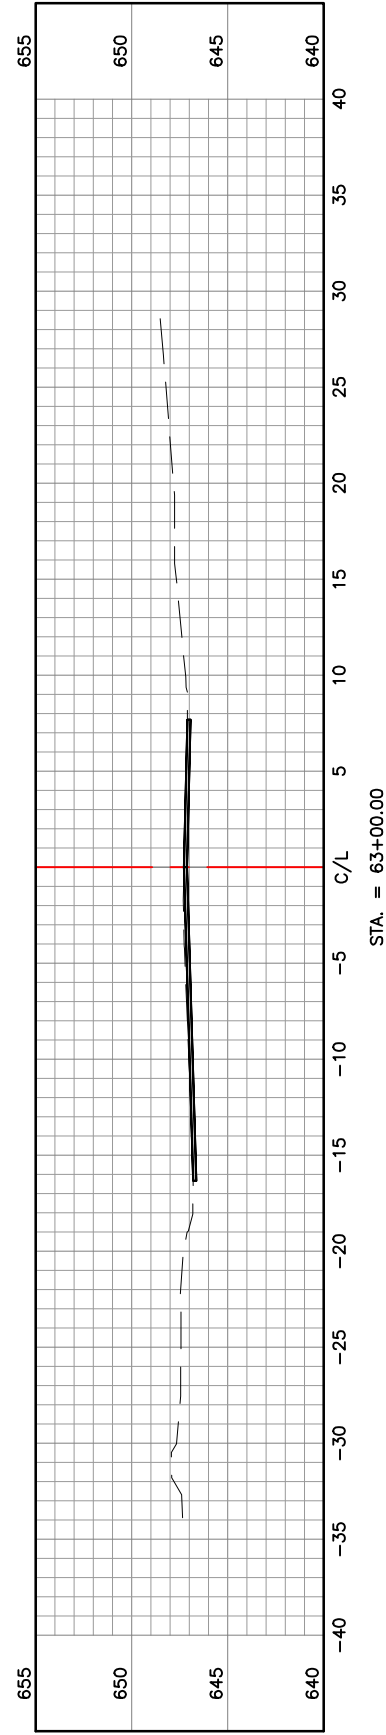
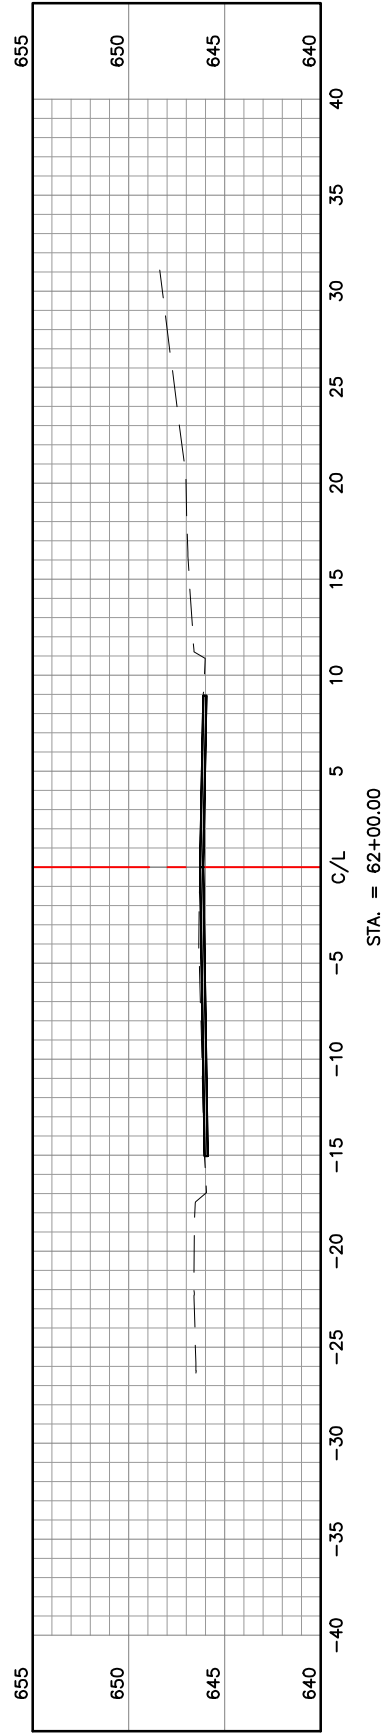
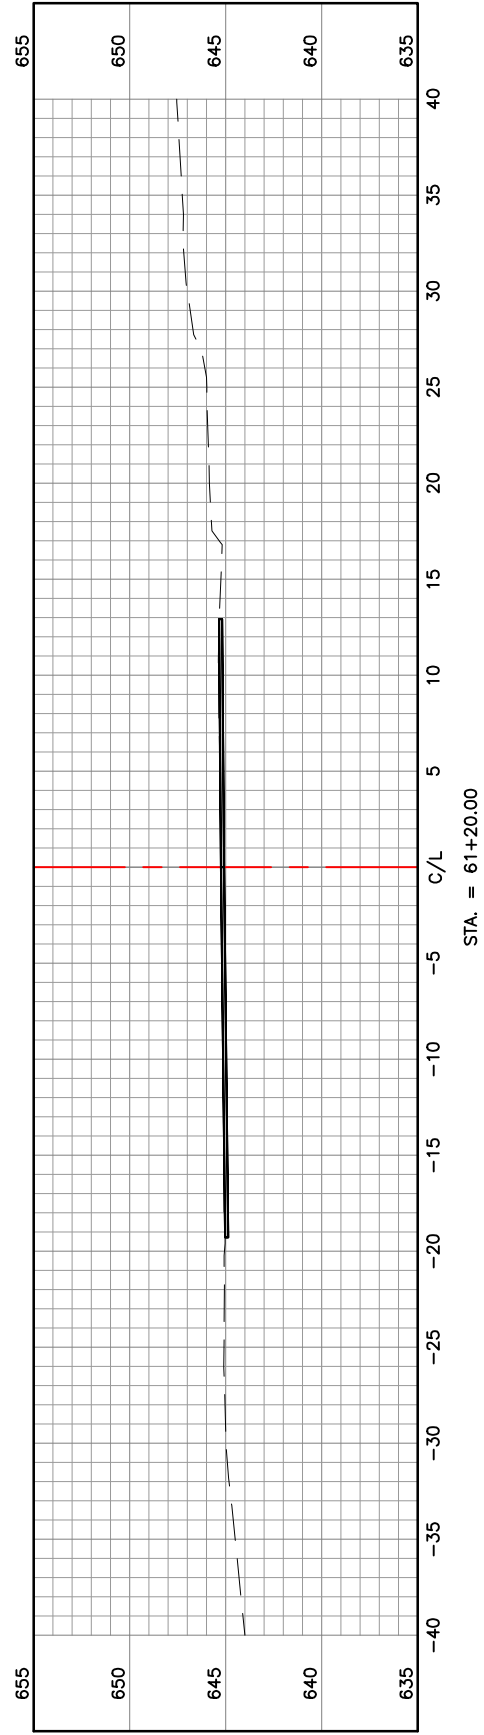
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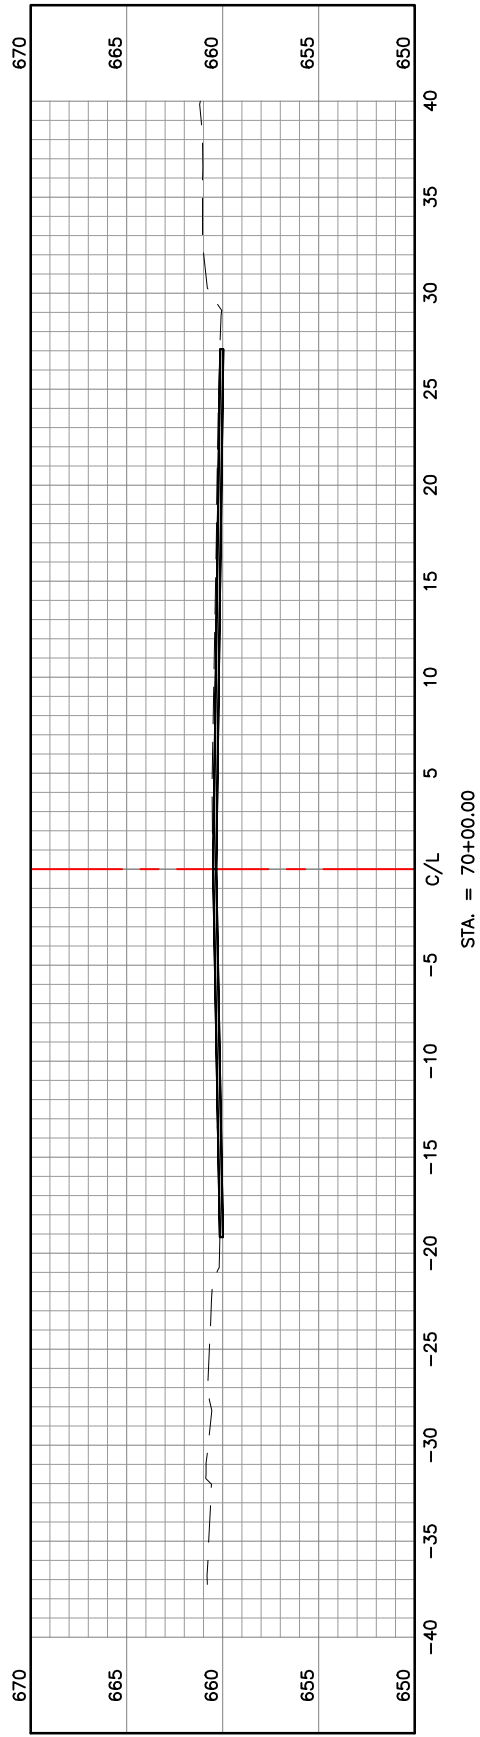
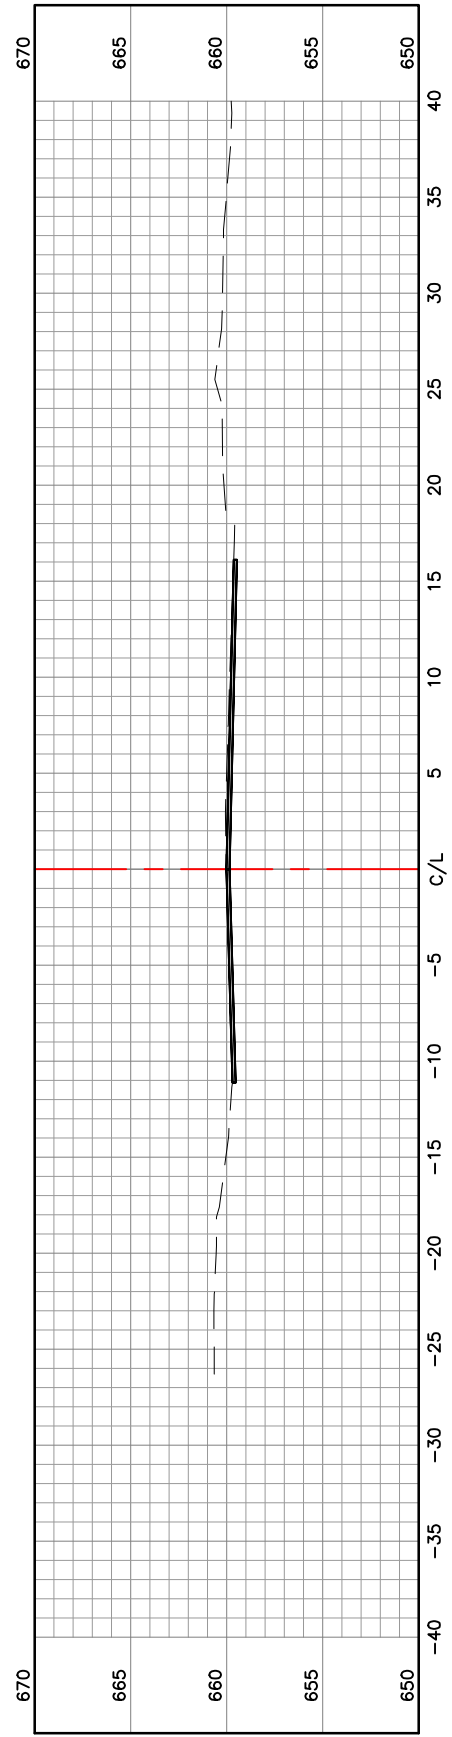
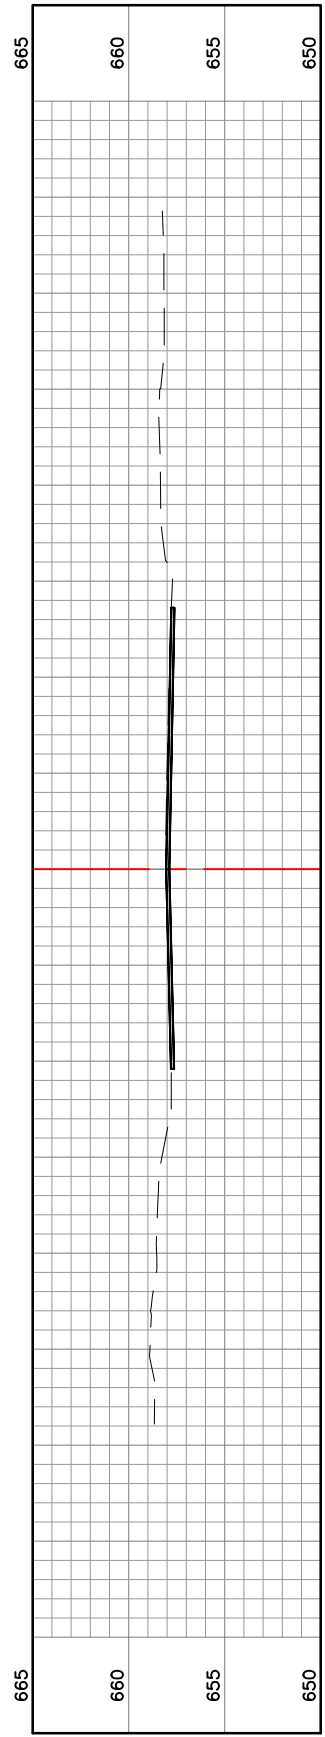
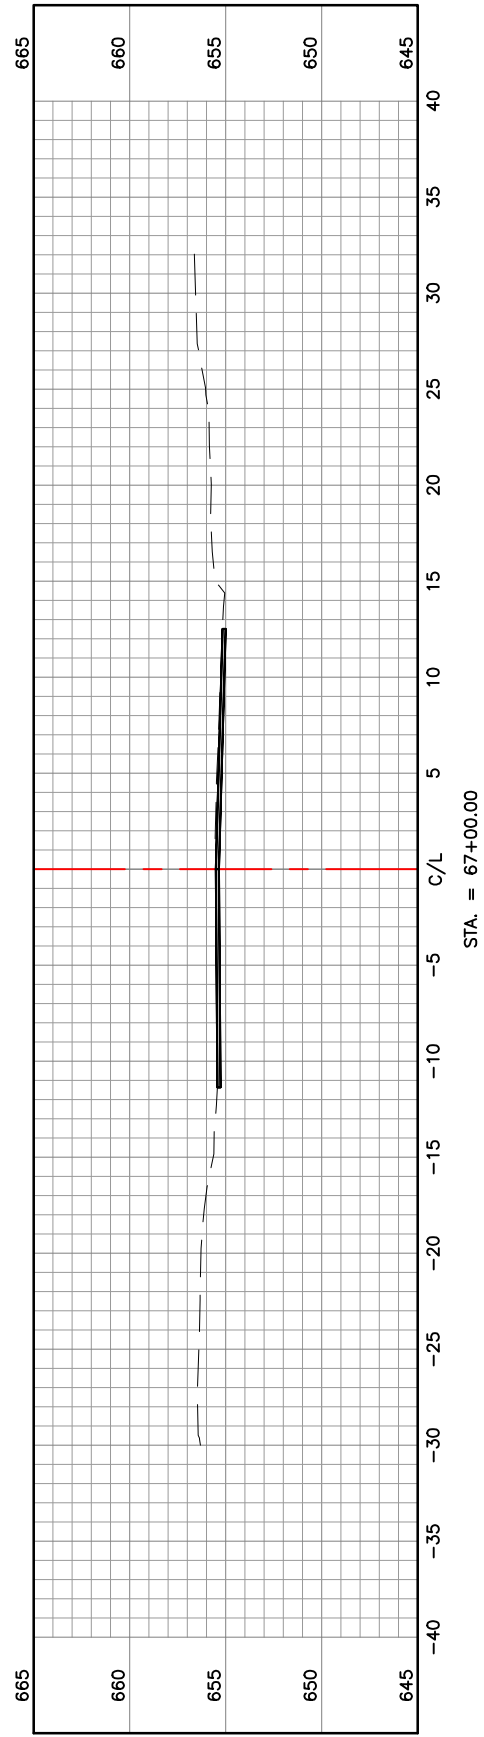
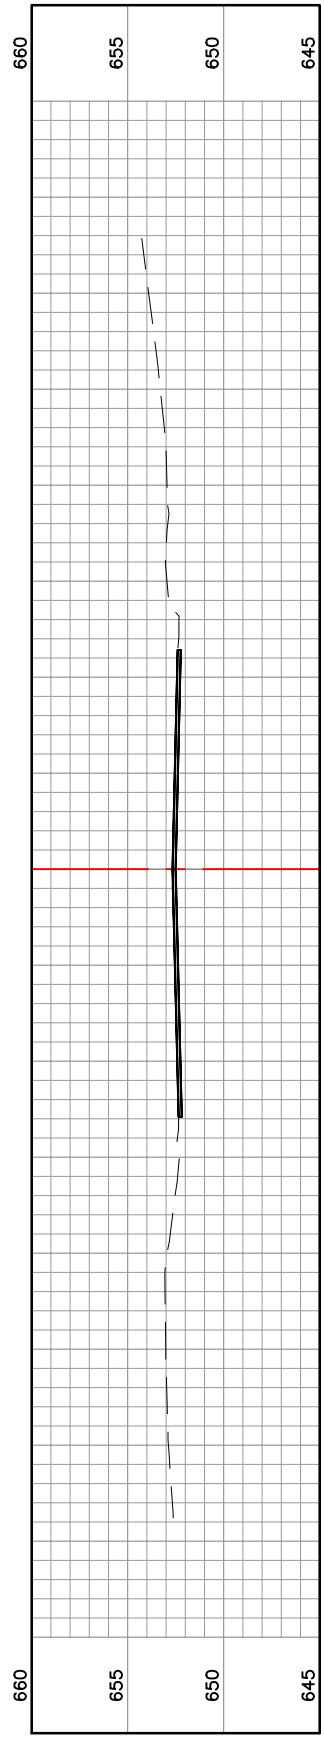
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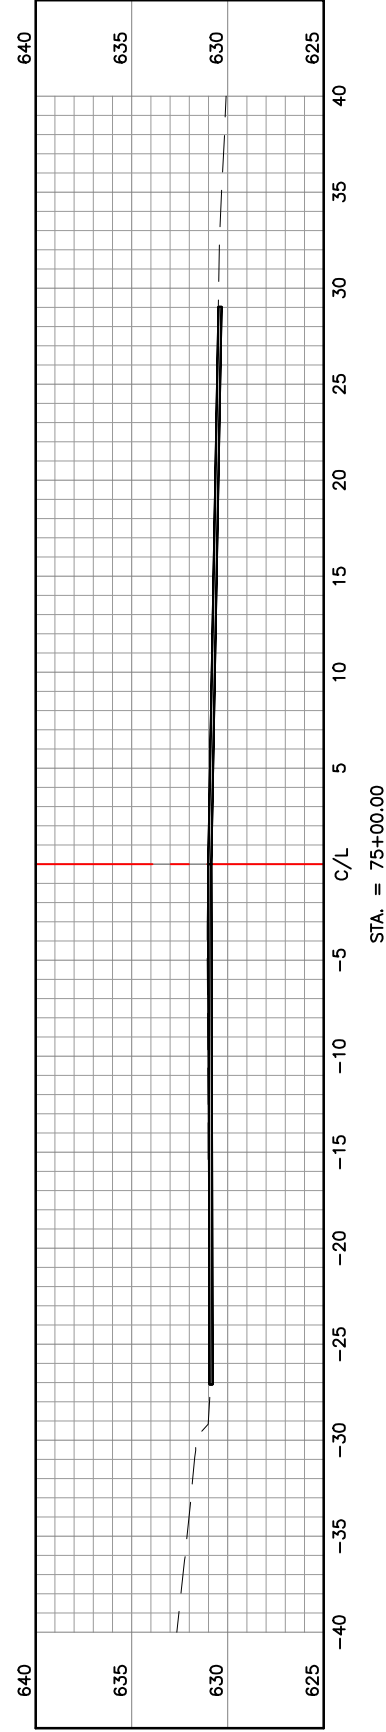
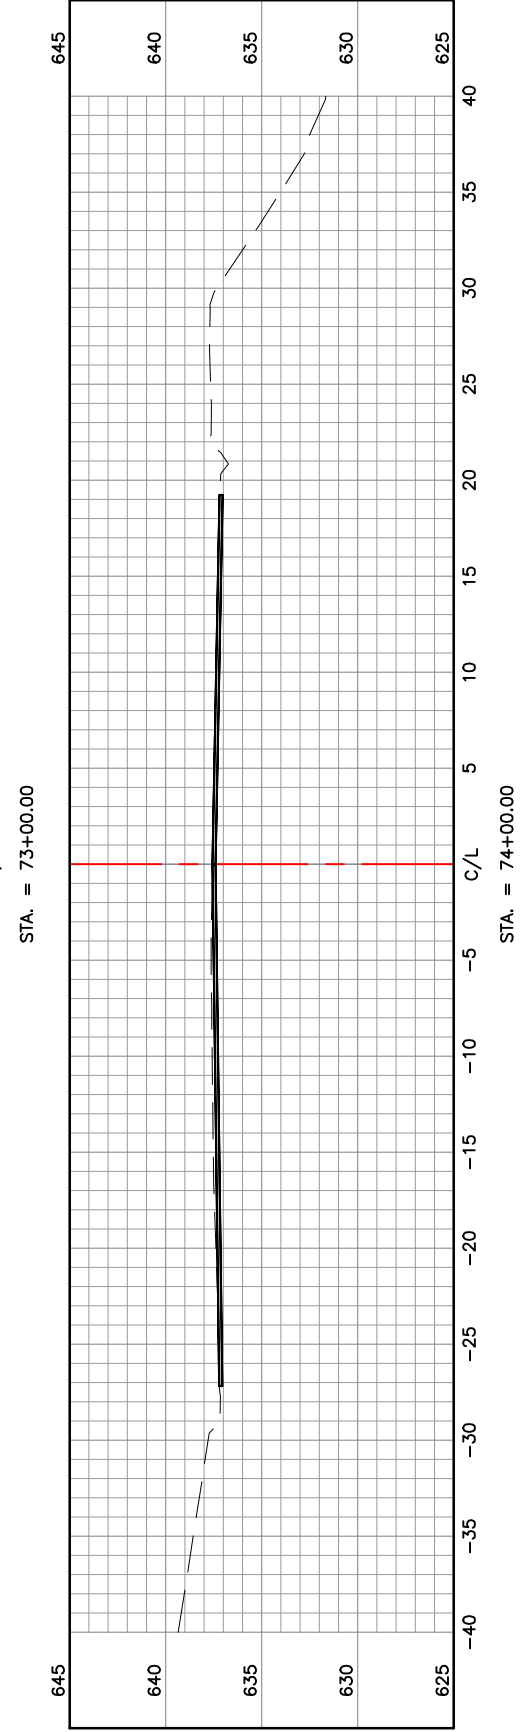
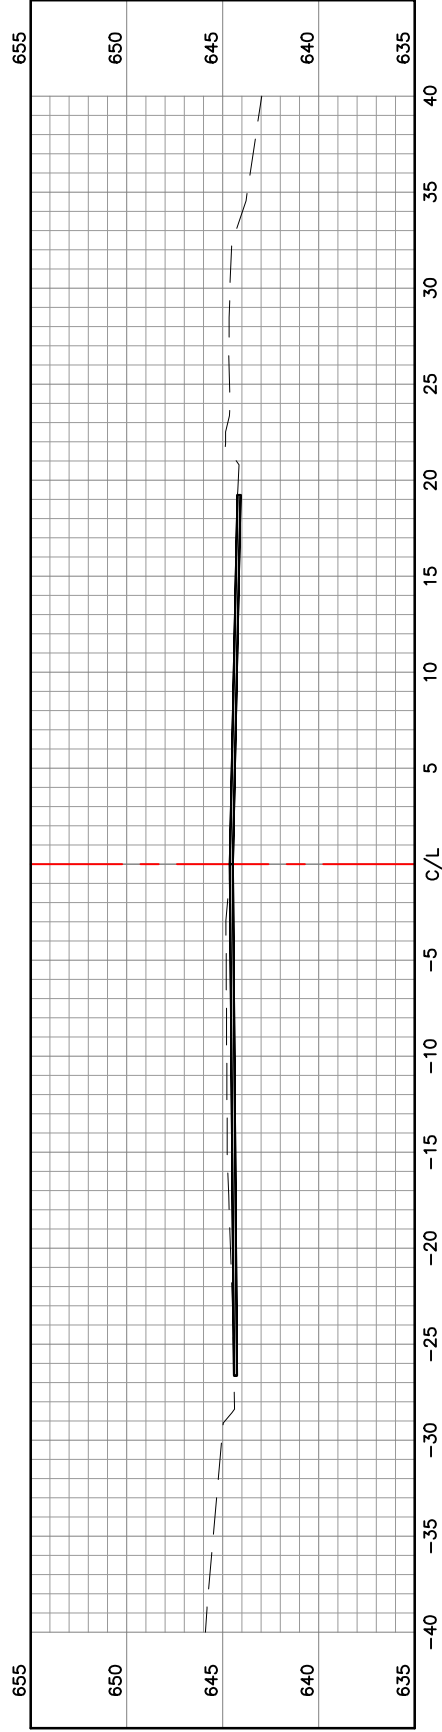
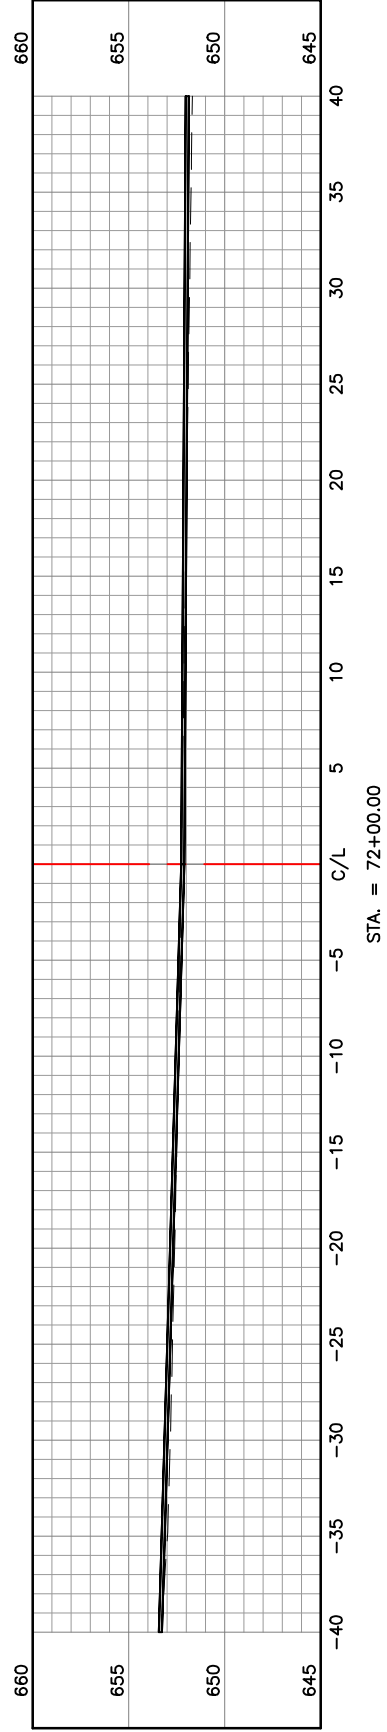
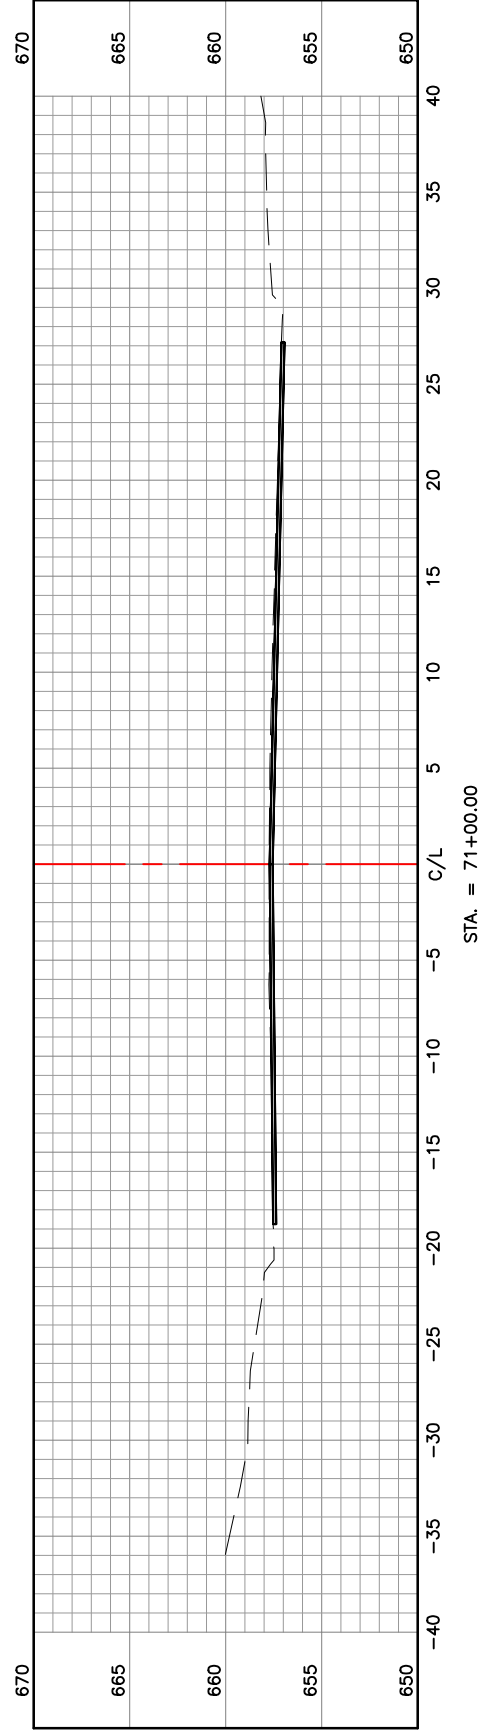
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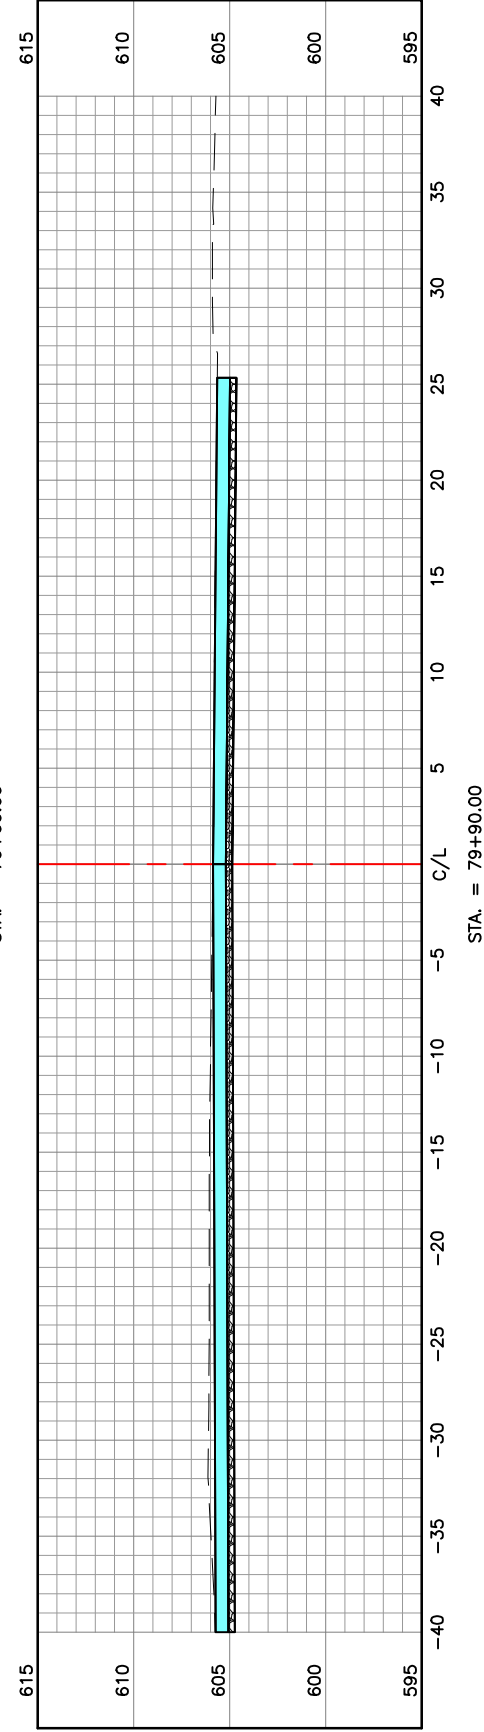
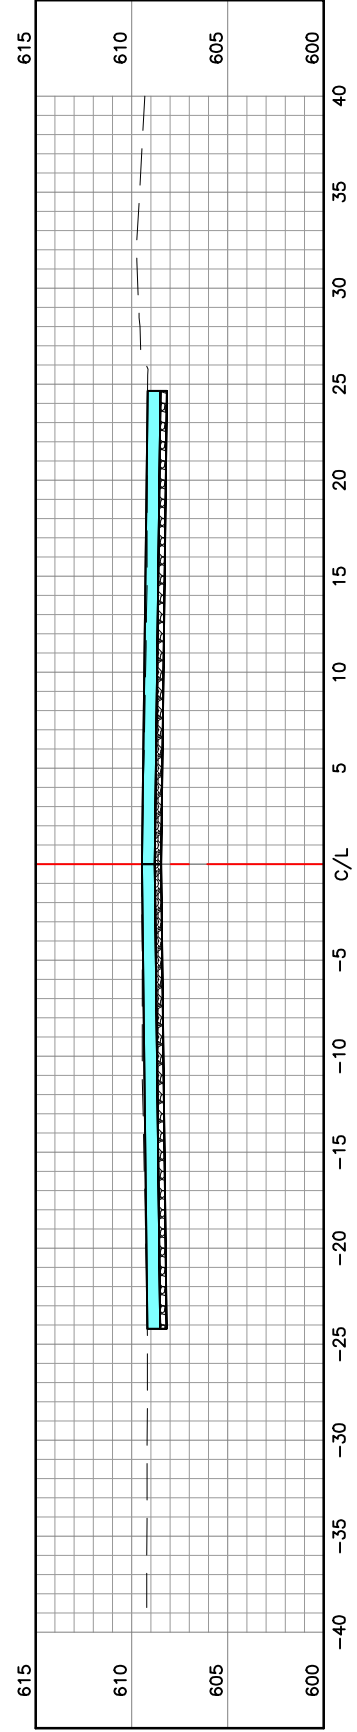
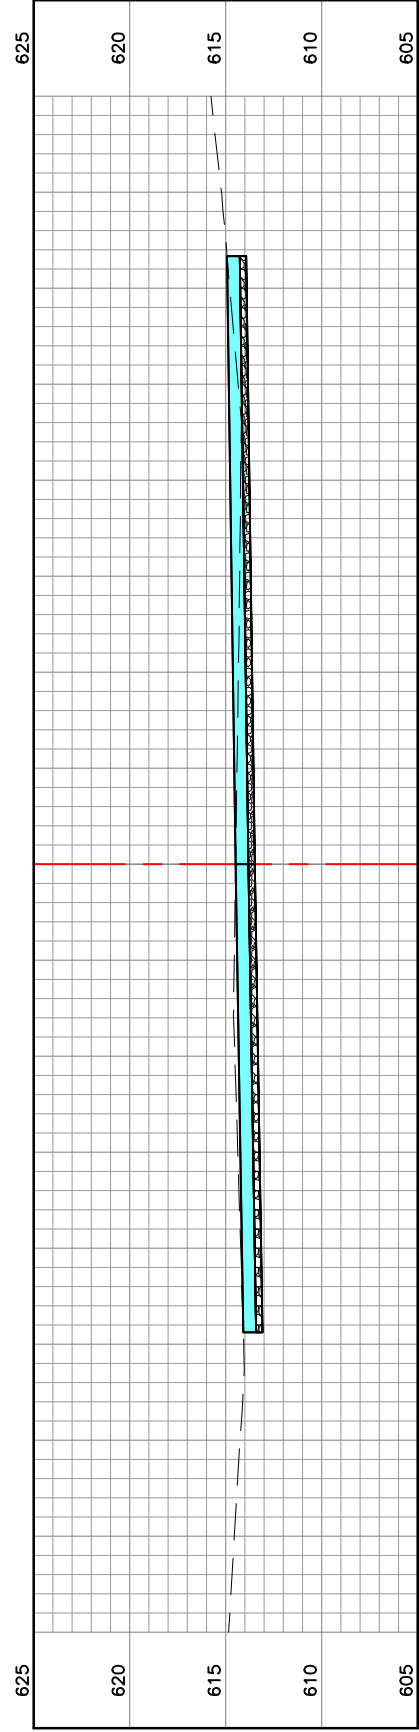
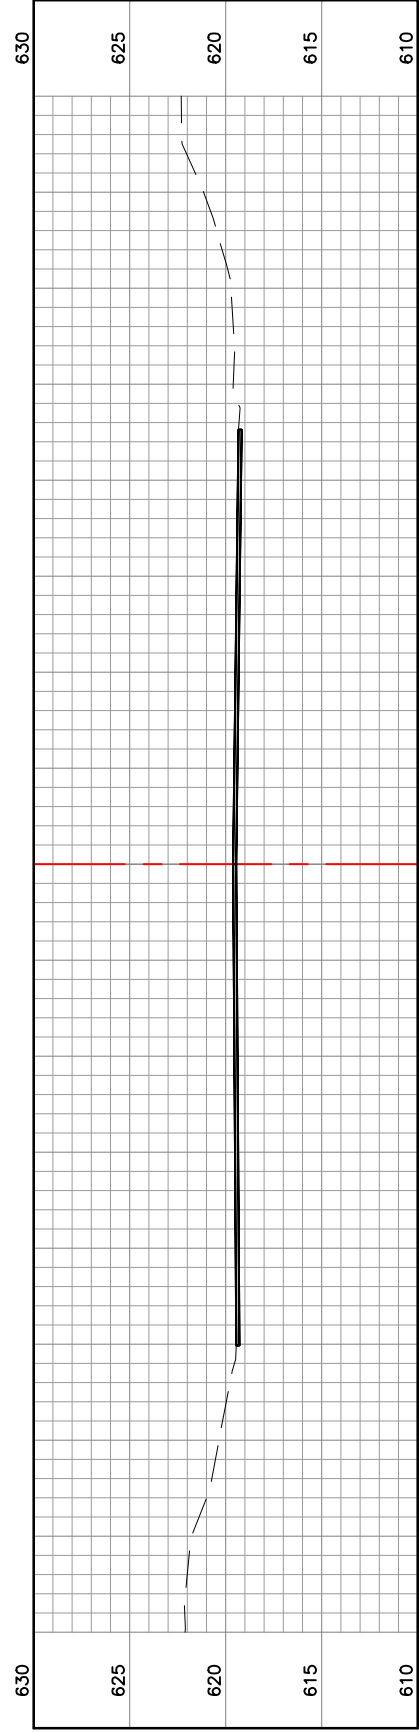
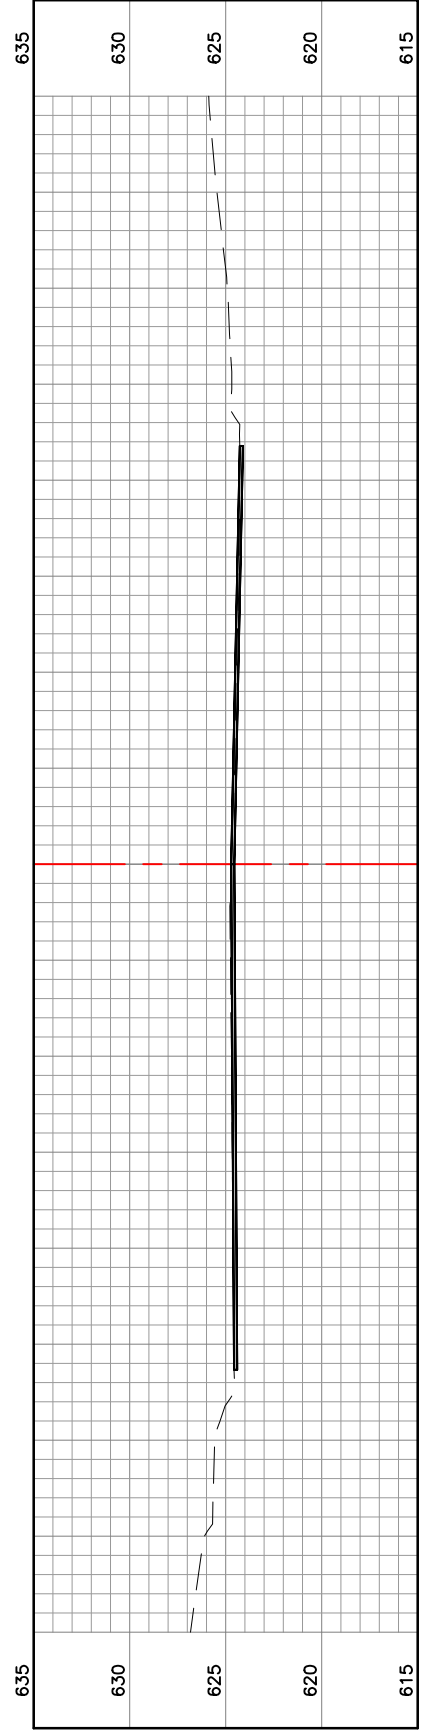
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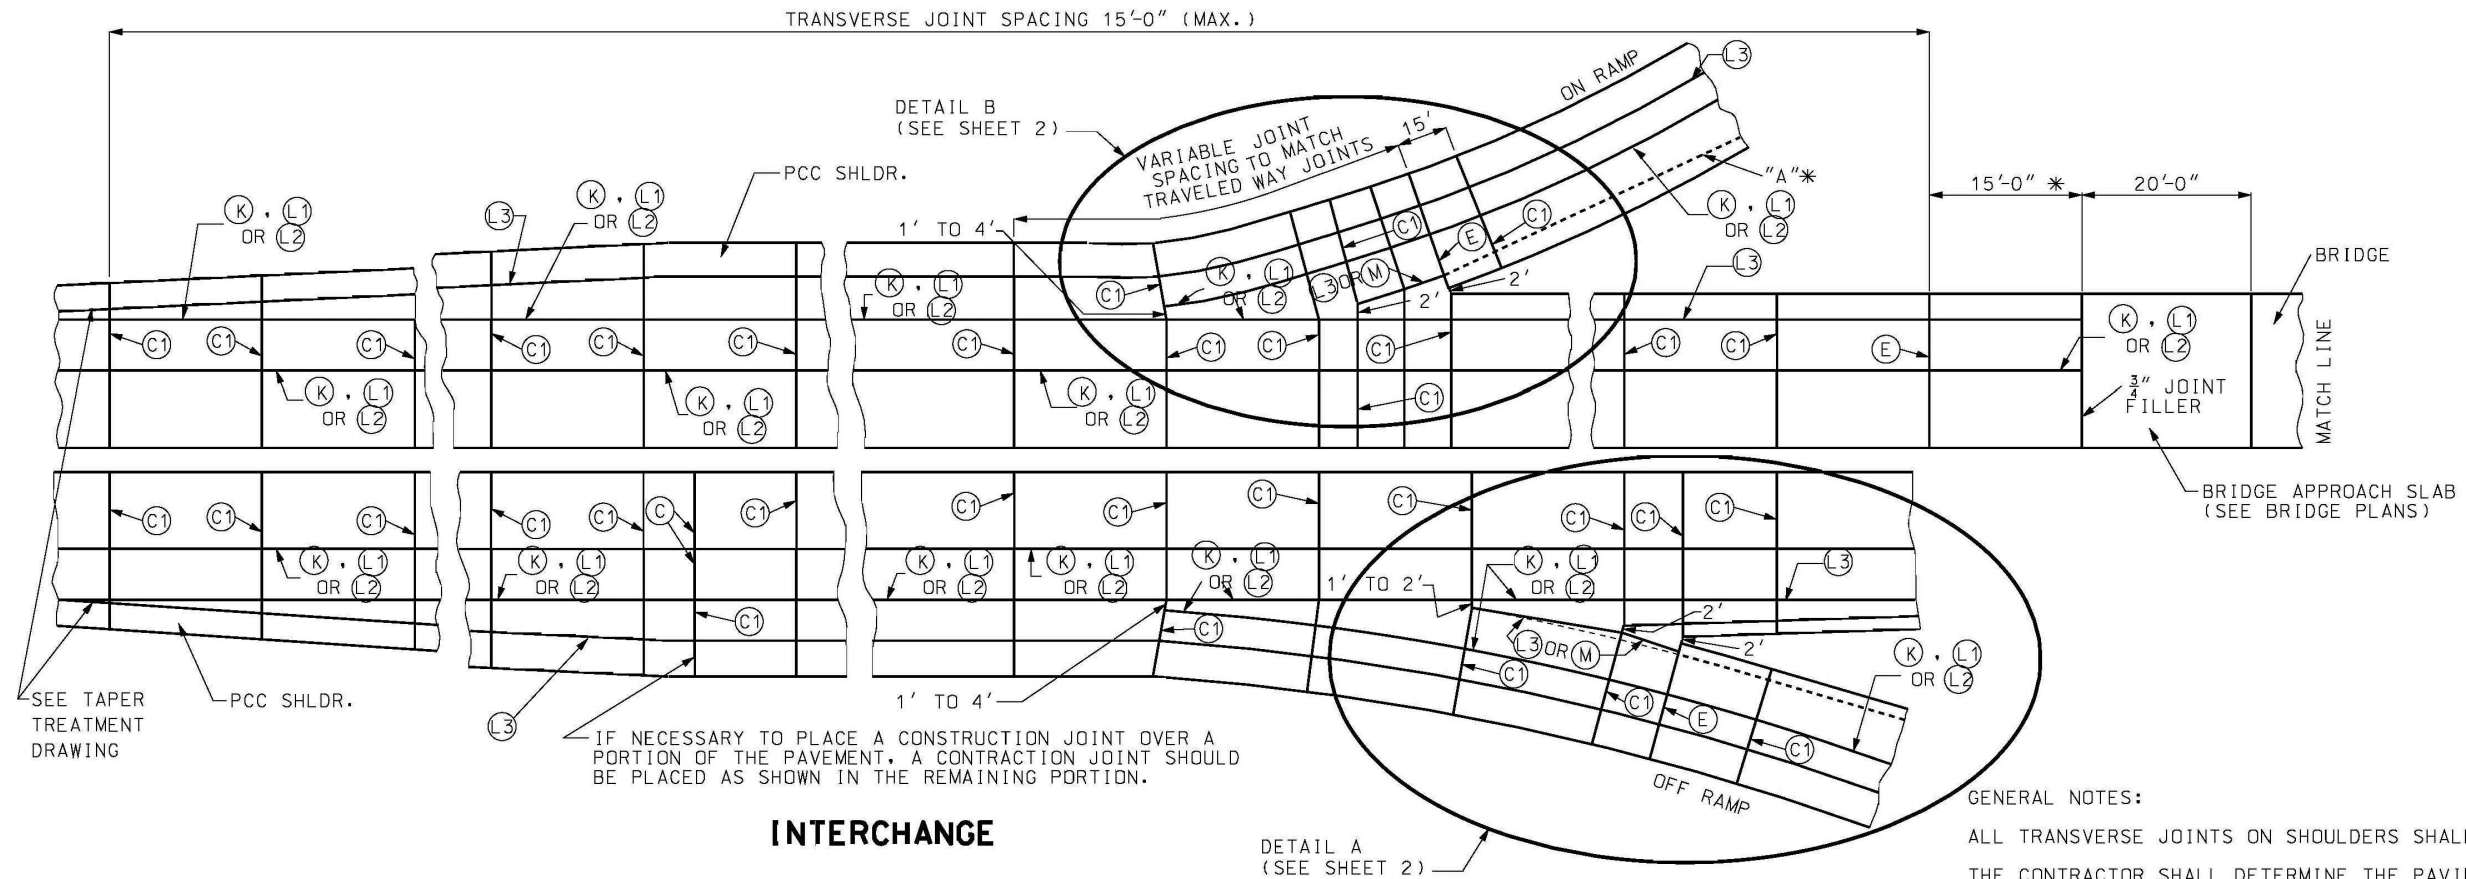
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MODOT 502.05 JOINT SPACING DETAILS

PAGE 1



INTERCHANGE

IF NECESSARY TO PLACE A CONSTRUCTION JOINT OVER A PORTION OF THE PAVEMENT, A CONTRACTION JOINT SHOULD BE PLACED AS SHOWN IN THE REMAINING PORTION.

GENERAL NOTES:

ALL TRANSVERSE JOINTS ON SHOULDERS SHALL BE C2.
THE CONTRACTOR SHALL DETERMINE THE PAVING WIDTH.


C3 SHALL BE USED BETWEEN PAVEMENT AND SHOULDER GREATER THAN 4'. THE INTERCHANGE WILL EXTEND FROM THE BEGINNING OF THE ACCELERATION/DECELERATION LANE TO THE GORE RETURN TAPER ON THE MAINLINE. THE INTERCHANGE WILL ALSO INCLUDE THE RAMPS UP TO THE BEGINNING OF THE RADIUS WITH THE ROAD INTERSECTING THE RAMP.

FOR JOINT DETAILS, SEE SHEETS NO. 3 & 4.


THE JOINT LAYOUT OF RAMPS IS TYPICAL FOR OUTER RAMPS OF CLOVERLEAF AND DIAMOND INTERCHANGES. SEE OTHER DRAWINGS FOR SPECIAL JOINT LAYOUTS.

JOINT SPACING SHOWN IS MAXIMUM AND IS TO BE REDUCED TO AVOID CONFLICT WITH ABUTTING STRUCTURES. JOINTS IN MULTI-LANE PAVEMENT ARE TO BE CONTINUOUS.

ALL SHOULDERS 4' OR LESS IN WIDTH CAST MONOLITHICALLY WITH THE ADJACENT LANE AND SHALL NOT HAVE A LONGITUDINAL JOINT OR TIE BARS.

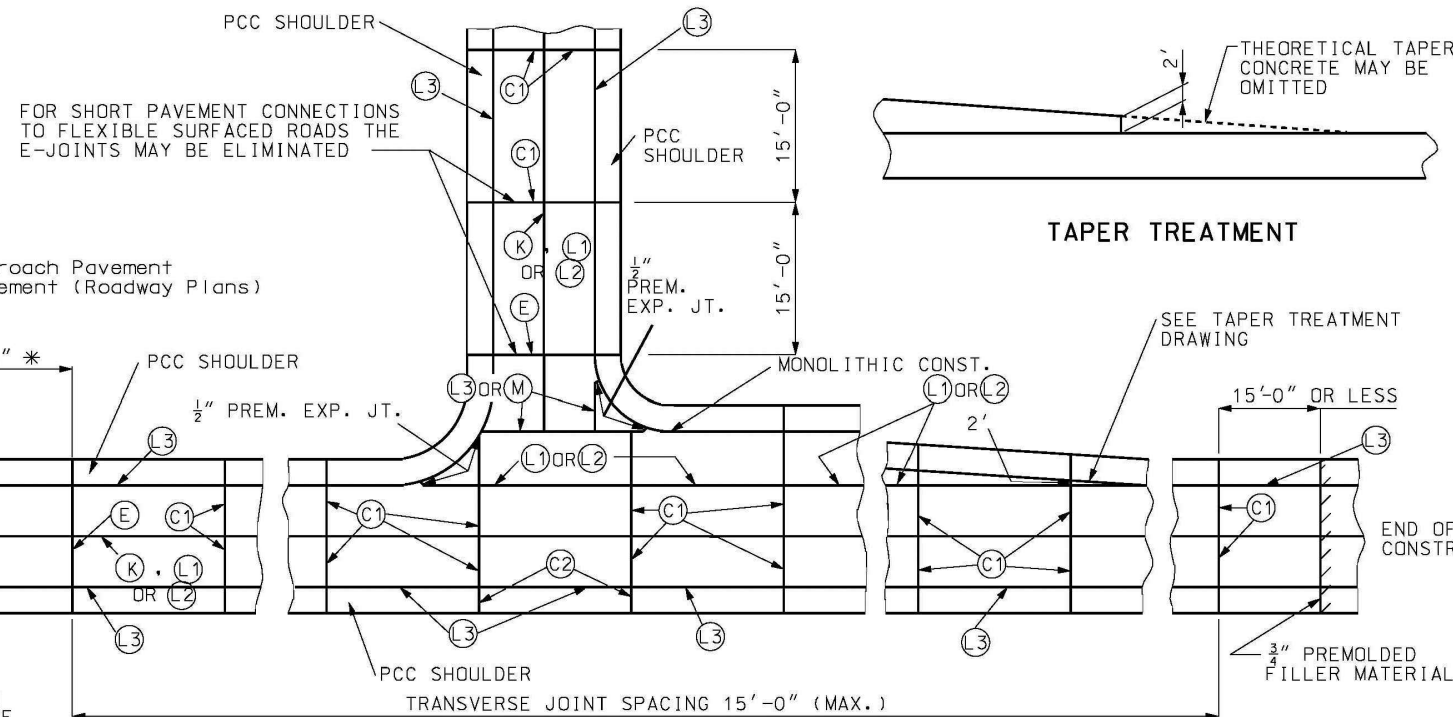

NON-INTERCHANGE

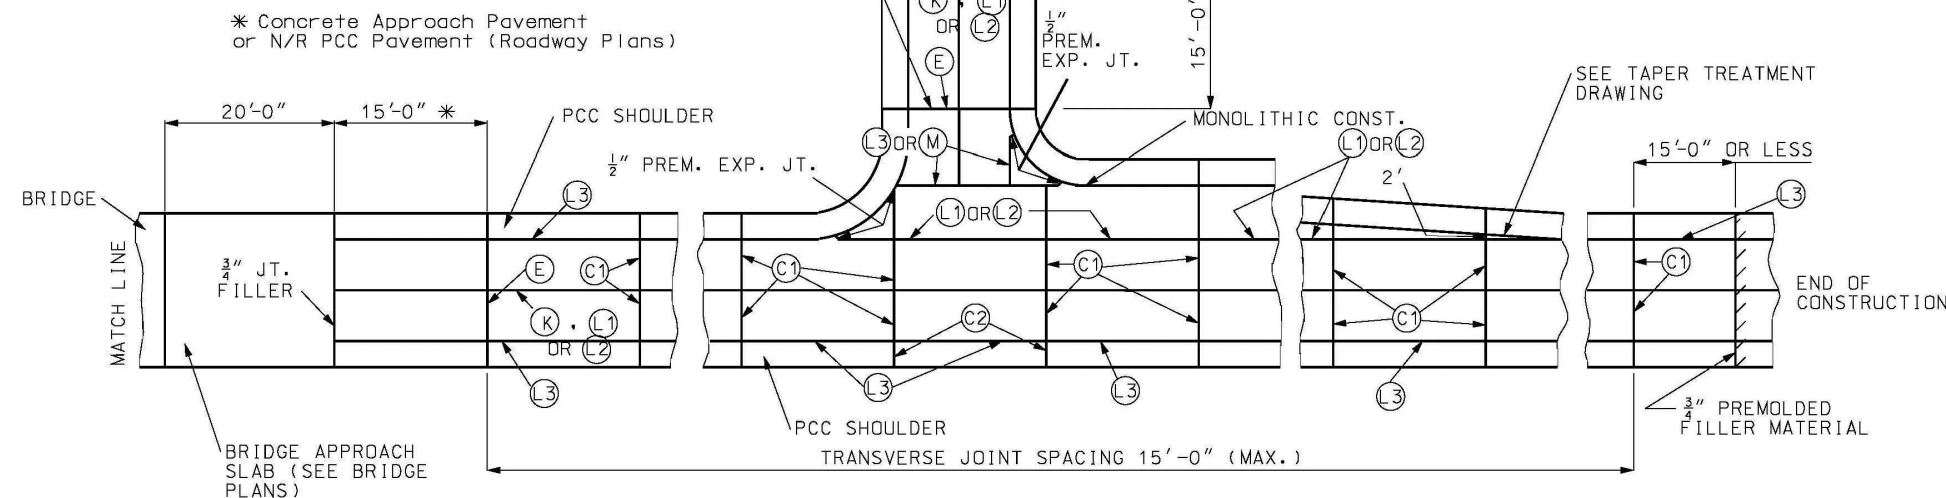

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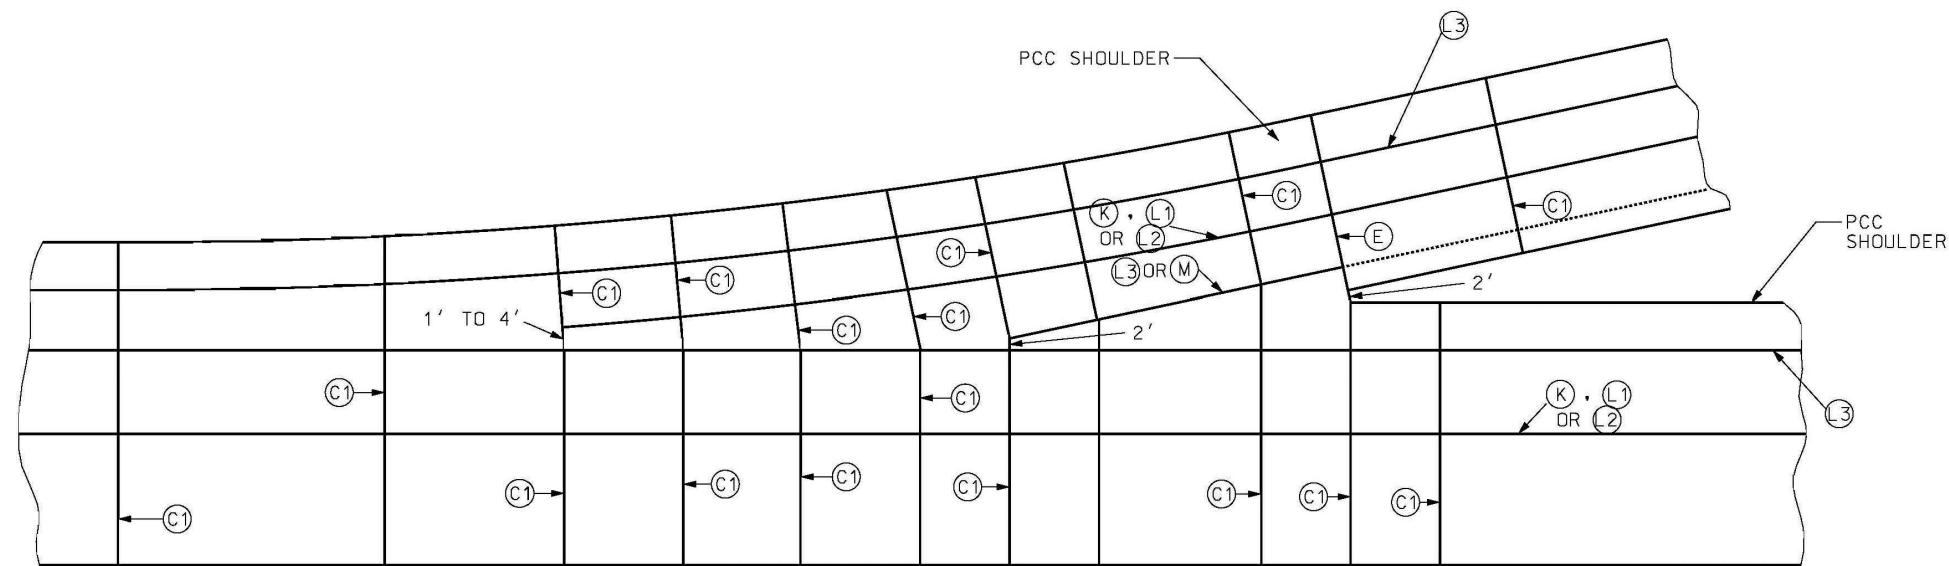
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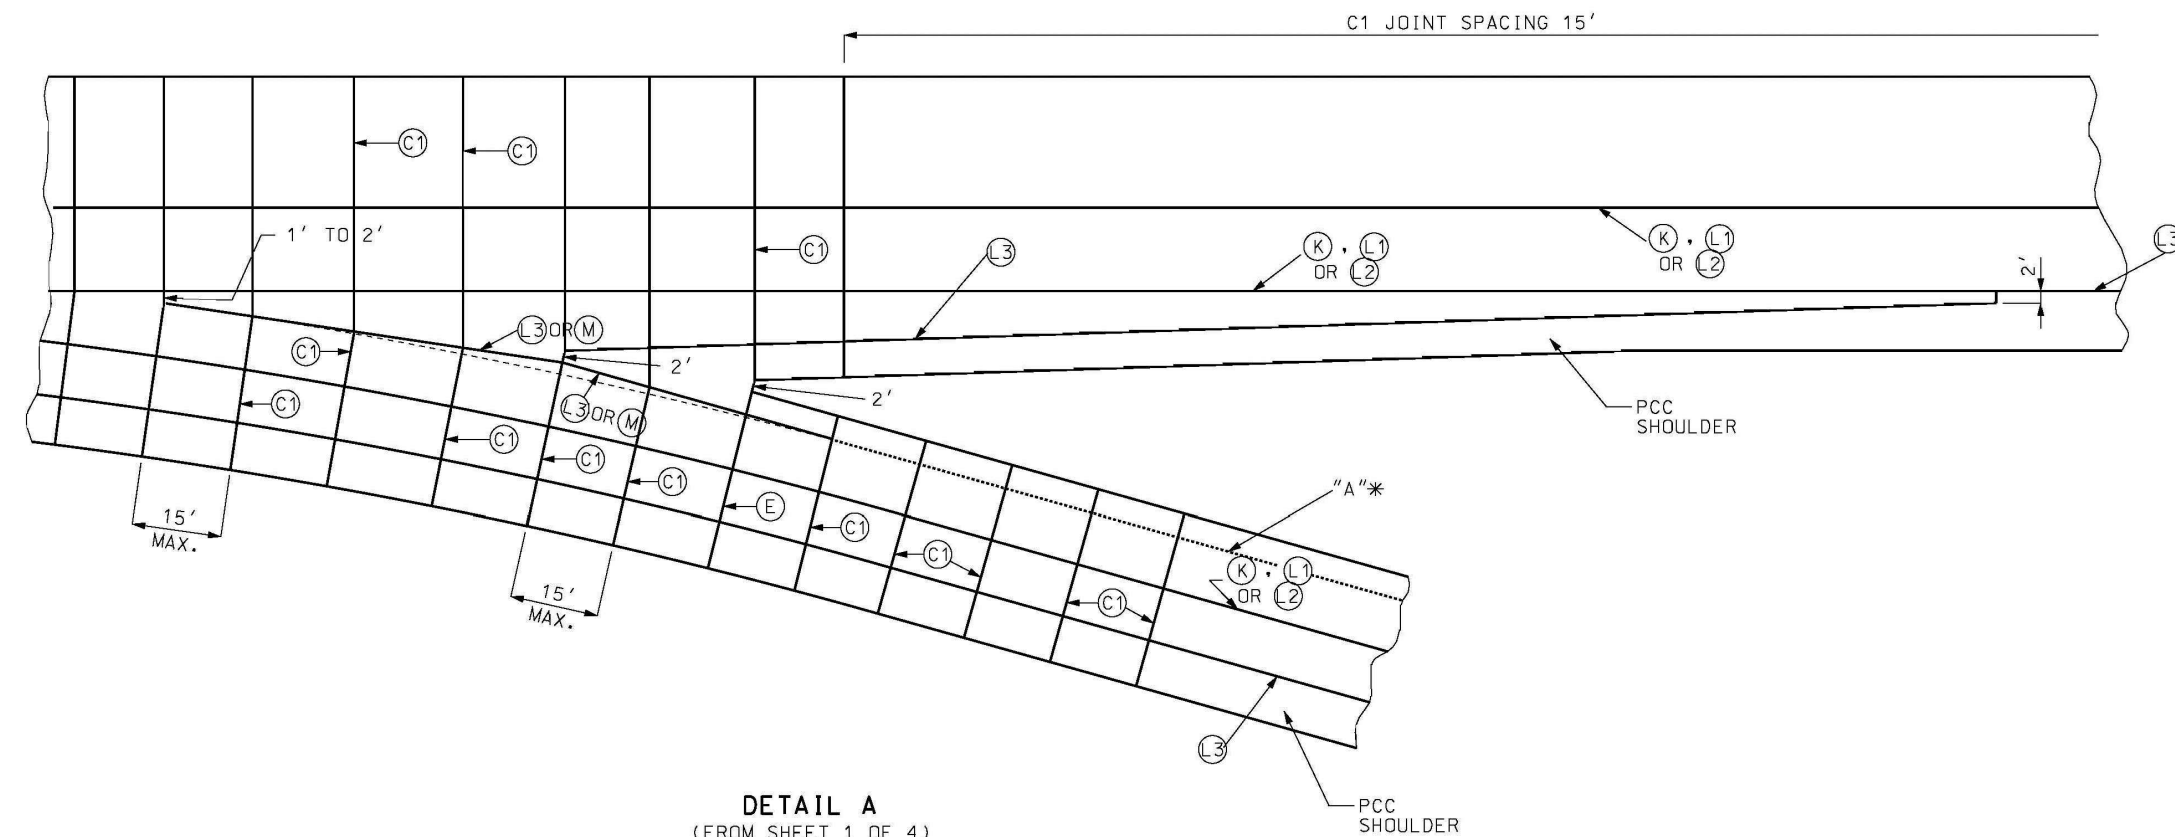
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MODOT 502.05 JOINT SPACING DETAILS

PAGE 2



DETAIL B
(FROM SHEET 1 OF 4)



DETAIL A
(FROM SHEET 1 OF 4)

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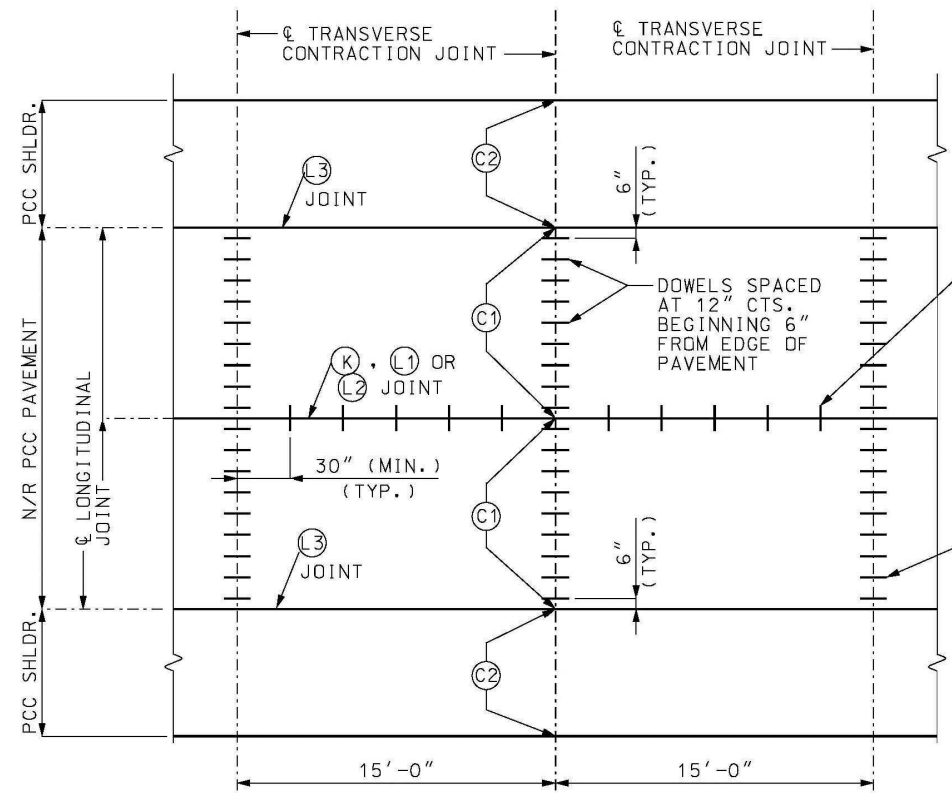
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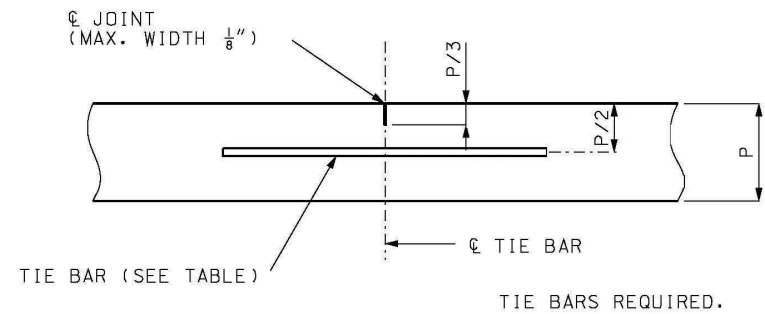
MODOT 502.05 JOINT SPACING DETAILS

PAGE 3




JOINT PLAN AND SPACING FOR CONTRACTION JOINTS (1)

(1) LONGITUDINAL JOINT NOT REQUIRED AT INSIDE SHOULDER ON DIVIDED HIGHWAYS OR AT INSIDE SHOULDER OF RAMPS. FOR 4' OR LESS INSIDE SHOULDERS, DOWELS ARE REQUIRED FOR THE FIRST TWO FEET ADJACENT TO THE TRAVEL LANE.



LONGITUDINAL JOINT (L1)

TIE BAR AND DOWEL TABLE				
PCCP THICKNESS (P)	DOWEL SIZE	TIE BAR SIZE	DOWEL SPACING	TIE BAR SPACING
LESS THAN 7"	NONE	#5X30"	NONE	30" CTR.-CTR.
7" TO 10"	1 1/4"X18"	#5X30"	12" CTR.-CTR.	30" CTR.-CTR.
GREATER THAN 10"	1 1/2"X18"	#6X40"	12" CTR.-CTR.	30" CTR.-CTR.

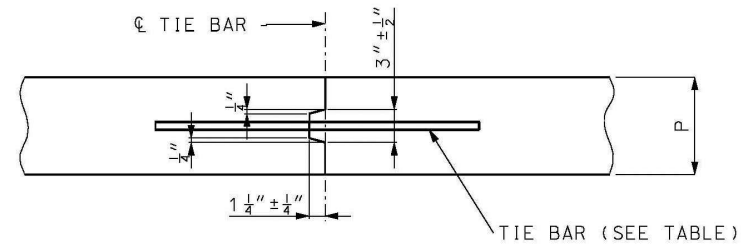


IF METAL IS USED TO FORM KEY DISCONTINUE STRIP FOR DISTANCE OF APPROXIMATELY 3" EACH SIDE OF TRANSVERSE JOINT.

TYPE (K) REQUIRES TIE BAR.

TYPE (M) CONSTRUCTED WITHOUT TIE BARS.

(K) AND (M) JOINTS SHALL NOT BE SAWED.

TONGUE AND GROOVE JOINTS (K) AND (M)

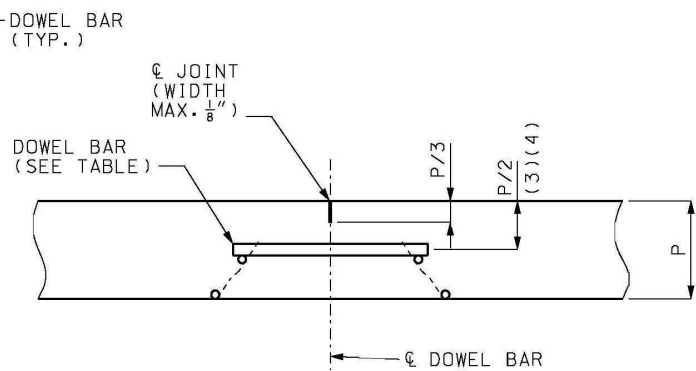


DOWELS REQUIRED. FOR PERMISSIBLE TYPES OF DOWELS SUPPORTING UNITS, SEE OTHER DRAWINGS.


TRANSVERSE CONTRACTION JOINTS FOR CONCRETE PAVEMENT OR BASE WIDENING SHALL MATCH EXISTING JOINTS.

TRANSVERSE CONTRACTION JOINT (C1) (2)


- (2) DOWEL BARS ARE REQUIRED FOR ALL PAVEMENTS HAVING THE SAME THICKNESS AS THE TRAVELED WAY.
- (3) FOR PAVEMENTS HAVING THICKNESS IN 1/2" INCREMENTS, DOWEL BASKETS SHALL BE P/2 - 1/2".
- (4) DOWEL BARS MAY BE PLACED BY MECHANICAL MEANS AT THE OPTION OF THE CONTRACTOR.

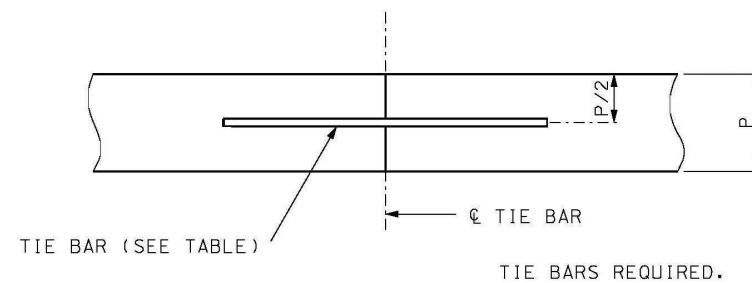

LONGITUDINAL CONSTRUCTION JOINT (L2)

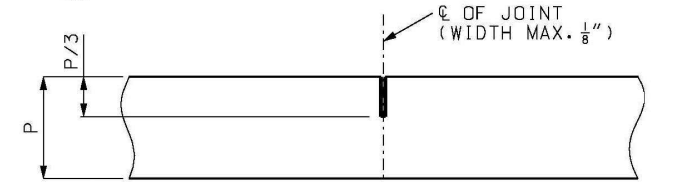

TRANSVERSE CONTRACTION JOINT (C2)

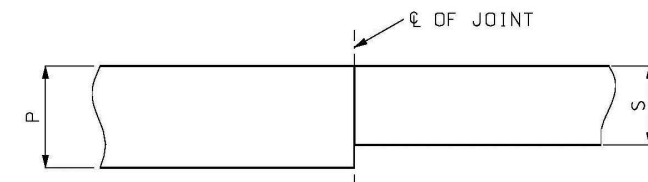

LONGITUDINAL CONSTRUCTION JOINT FOR SHOULDER (L3)

S = SHOULDER THICKNESS

GENERAL NOTES:

THE FINAL POSITION OF ALL DOWELS AND TIE BARS SHALL BE PERPENDICULAR TO THE PLANE OF THE JOINT AND PARALLEL TO THE SURFACE OF THE PAVEMENT AND PARALLEL TO EACH OTHER.

(L3) JOINT FOR FULL DEPTH OR PARTIAL DEPTH SHOULDERS.

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General Consulting
ENGINEERING CERTIFICATE OF AUTHORITY NUMBER - 2007006937
LAND SURVEYING CERTIFICATE OF AUTHORITY NUMBER - 2007004529

STATE OF MISSOURI

KEVIN J. WOLFF, P.E.
NO. PE-200400859
STATE OF MISSOURI
REGISTERED PROFESSIONAL ENGINEER
FOR SC ENGINEERING LLC,
DBA COCHRAN

1/28/21

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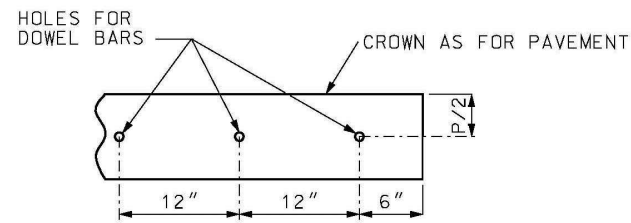
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FEDERAL PROJECT NO. STP-4939(608)
CITY OF BALLWIN, MISSOURI


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		K.J.W.	M.D.S.
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SC19-981		502.05-3	

MODOT 502.05 JOINT SPACING DETAILS


PAGE 4



PART ELEVATION OF
HEADER PLANK

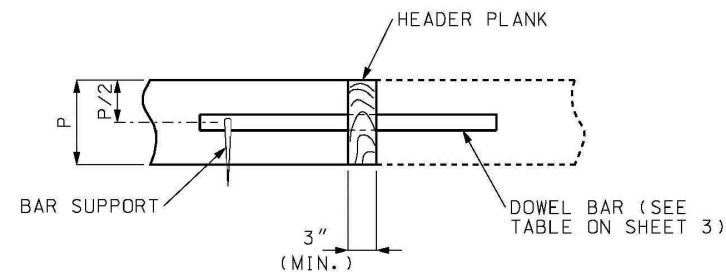

HEADER SECTION

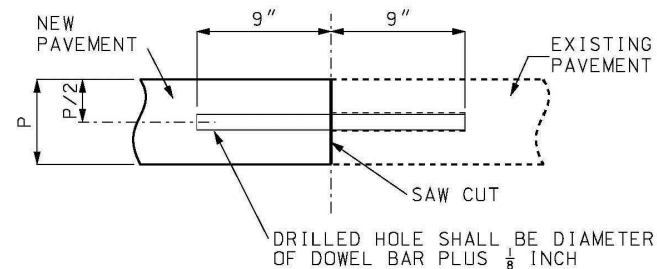

SAWED SECTION


THE HEADER BOARD SHALL BE SUFFICIENTLY RIGID TO PREVENT DISTORTION FROM THE TYPICAL SECTION AND MAINTAIN A STRAIGHT LINE FROM PAVEMENT EDGE TO PAVEMENT EDGE.

THE CONSTRUCTION JOINT MAY BE SAWED FULL DEPTH. HOLES FOR DOWEL BARS SHALL BE DRILLED AFTER THE CONCRETE HAS SUFFICIENT SET TO PREVENT DAMAGE. DOWEL BARS SHALL BE BONDED INTO THE HOLES.


BONDING FOR DOWEL BARS SHALL BE EPOXY OR POLYESTER BONDING AGENTS AS SPECIFIED IN SECTION 1039.

THE PORTION OF THE DOWEL OUTSIDE THE HOLE SHALL BE COATED WITH AN APPROVED LUBRICANT.

CONSTRUCTION JOINT (C)

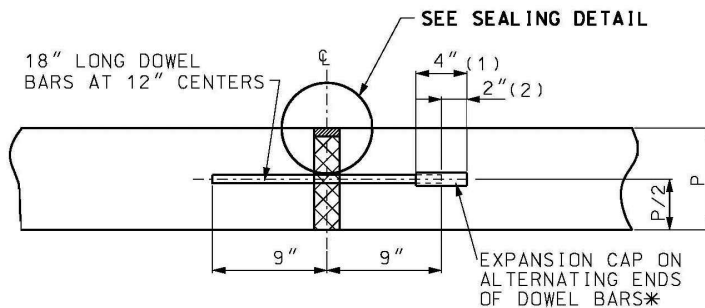


EXPANSION JOINTS (E)

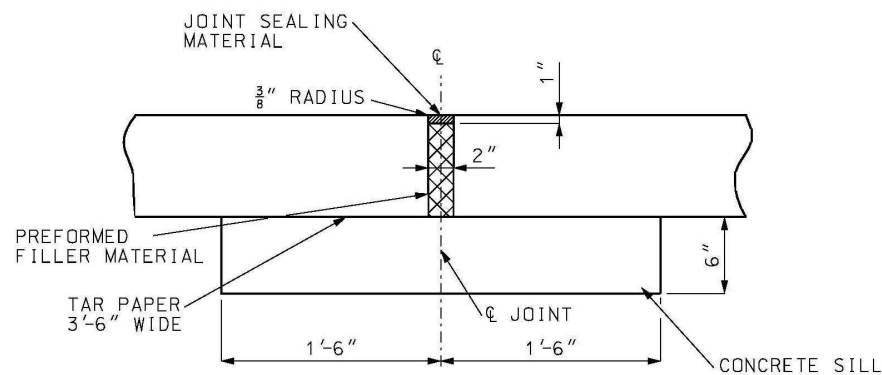

SILL SHALL EXTEND 18" BEYOND EACH EDGE OF THE PAVEMENT AND SHALL BE CONSTRUCTED OF CONCRETE REGARDLESS OF ADJACENT BASE MATERIAL.

ALTERNATE EXPANSION JOINTS (E)

(CONTRACTOR MAY SELECT EITHER EXPANSION JOINT (E))

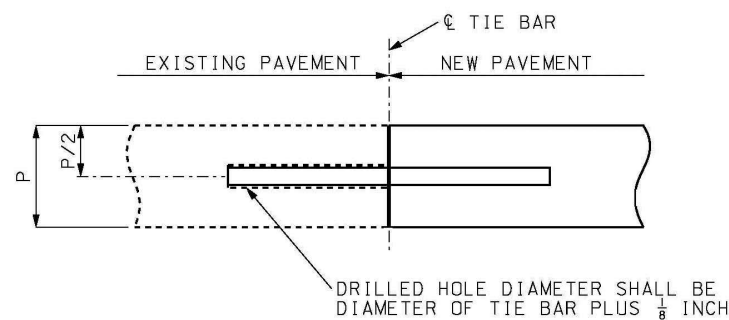

TIE BARS SHALL BE EPOXY COATED, DEFORMED REINFORCING BARS MEETING THE REQUIREMENTS OF SECTIONS 710 AND 1057.

BONDING FOR TIE BARS SHALL BE EPOXY OR POLYESTER BONDING AGENTS AS SPECIFIED IN SECTION 1039.


TIE BAR SIZE AND LENGTH SHALL BE BASED ON THE THICKNESS OF THE THINNER PAVEMENT OR SHOULDER TO BE TIED TOGETHER.

LONGITUDINAL CONSTRUCTION JOINT (EXISTING PAVEMENT) (L)

(1) LENGTH OF CAP

(2) GAP BETWEEN END OF
CAP AND DOWEL.

* FOR EXPANSION JOINTS FORMED USING A CONSTRUCTION HEADER, THE EXPANSION CAPS SHALL BE INSTALLED ON THE EXPOSED END OF EACH BAR ONCE THE HEADER HAS BEEN REMOVED AND THE JOINT FILLER MATERIAL HAS BEEN INSTALLED.

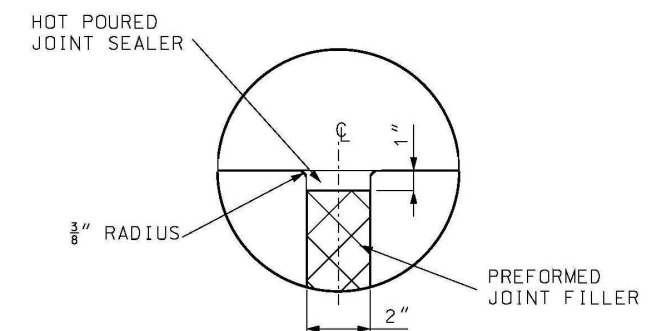

SEALING DETAIL

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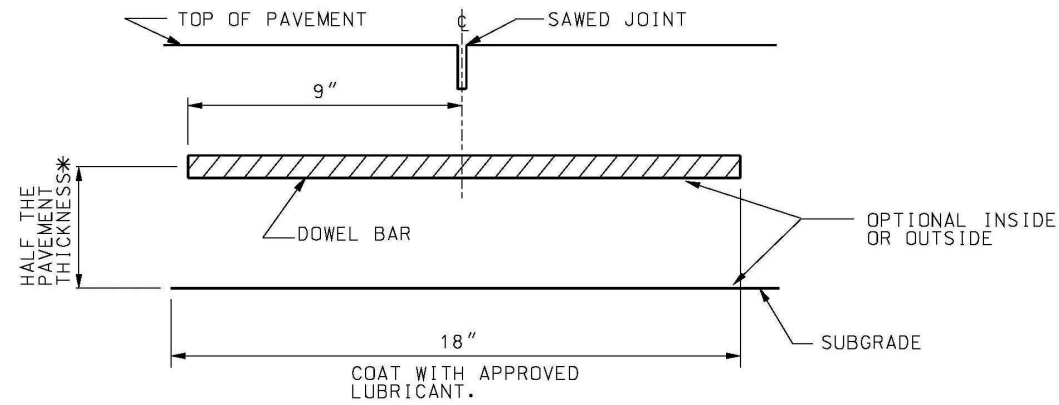
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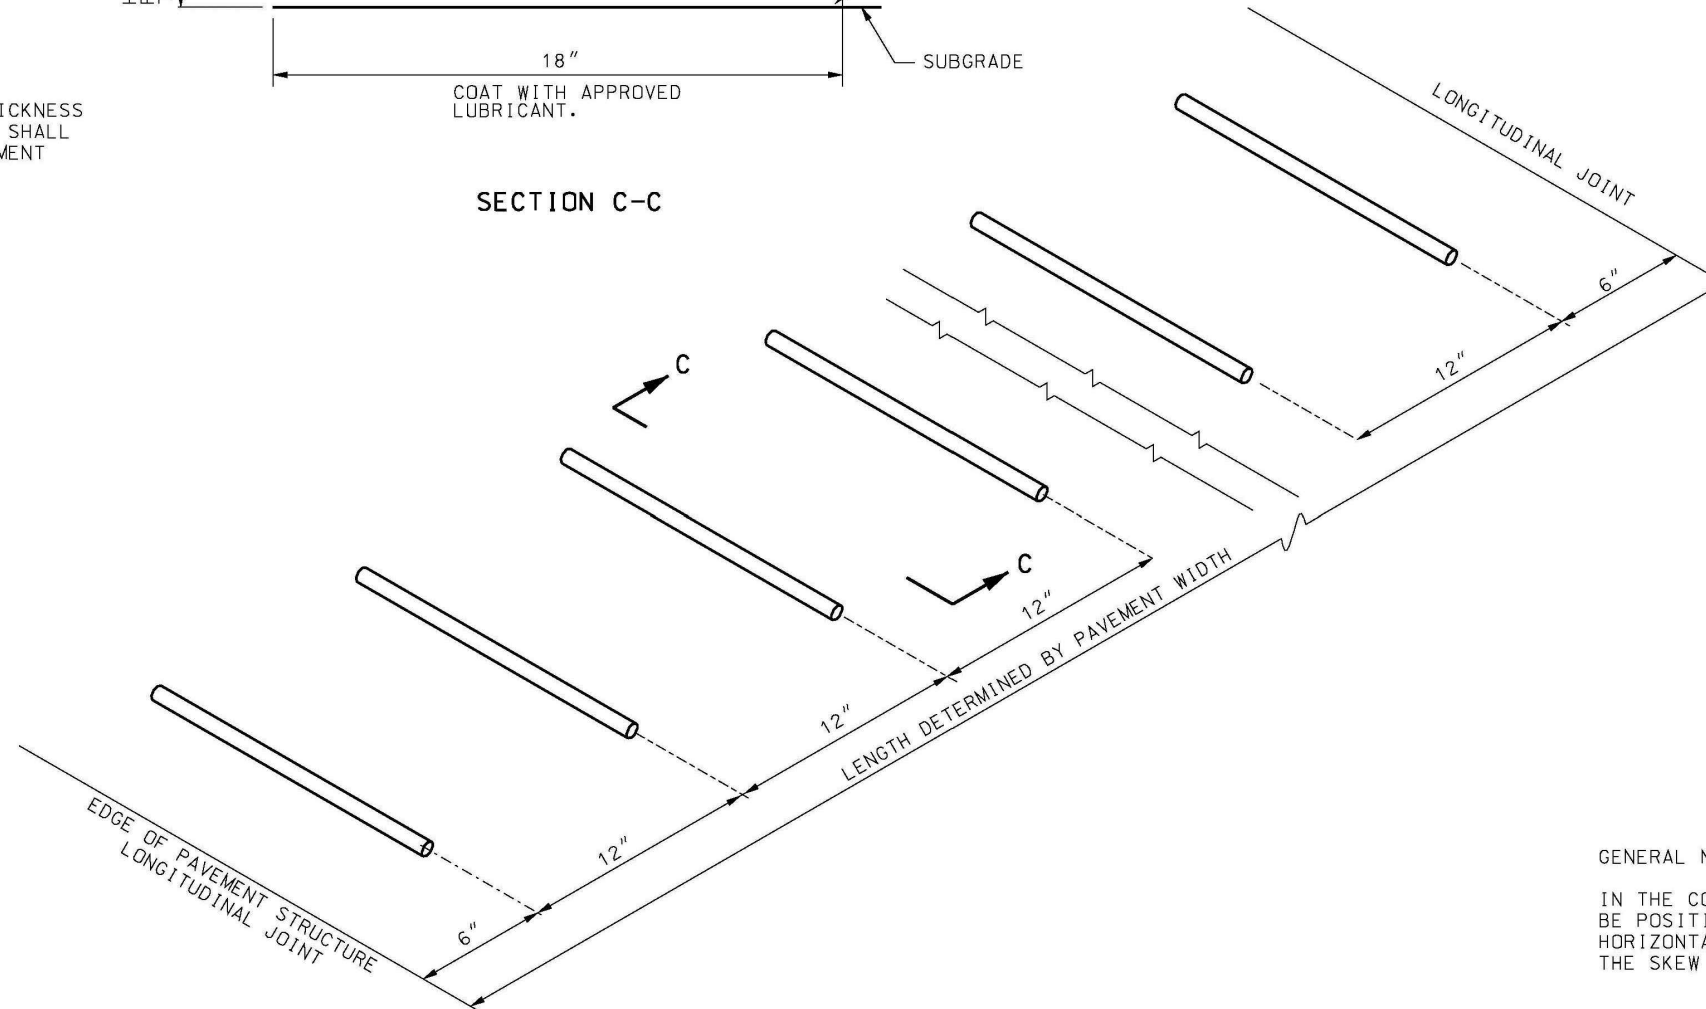
MODOT 502.10 DOWELS DETAILS

PAGE 2



* FOR PAVEMENTS HAVING THICKNESS IN $\frac{1}{2}$ " INCREMENTS, DOWEL SHALL BE PLACED HALF THE PAVEMENT THICKNESS MINUS $\frac{1}{4}$ ".

SECTION C-C



GENERAL NOTES:


IN THE COMPLETED JOINT INSTALLATION, DOWELS SHALL BE POSITIONED WITHIN $\frac{1}{2}$ " OF THE VERTICAL AND HORIZONTAL PLANE AND IN THE LONGITUDINAL DIRECTION. THE SKEW TOLERANCE SHALL BE $\frac{1}{4}$ ".

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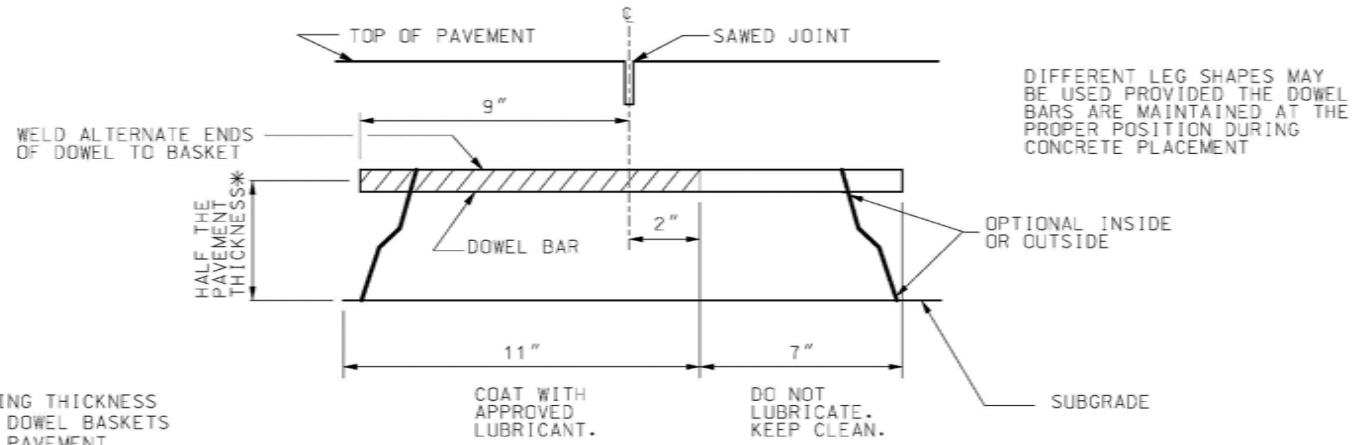
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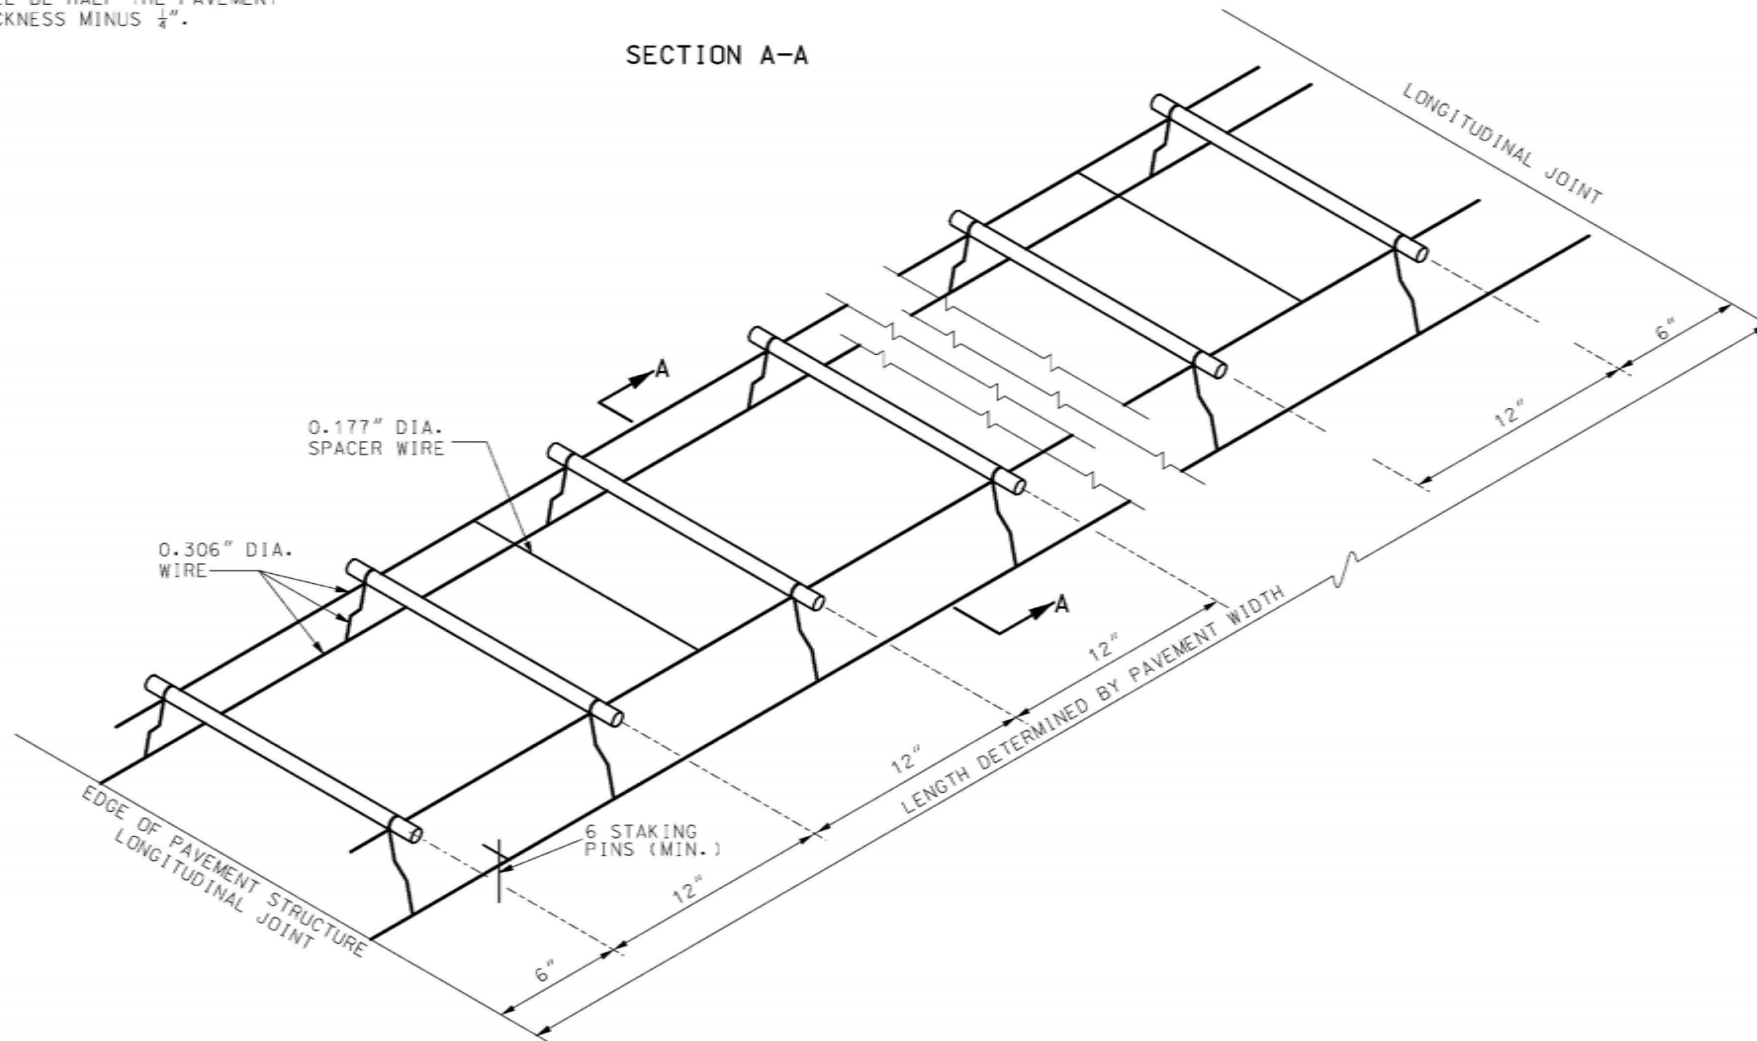
MODOT 502.10 DOWELS DETAILS

PAGE 1



* FOR PAVEMENTS HAVING THICKNESS IN $\frac{1}{2}$ " INCREMENTS, DOWEL BASKETS SHALL BE HALF THE PAVEMENT THICKNESS MINUS $\frac{1}{4}$ ".

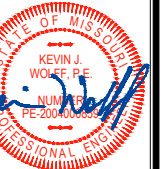SECTION A-A



DOWEL BARS		
PAVEMENT THICKNESS	BAR SIZE	
	DIAMETER	LENGTH
10" AND LESS	1 $\frac{1}{2}$ "	18"
GREATER THAN 10"	1 $\frac{1}{2}$ "	18"

GENERAL NOTES:

THE DOWEL SUPPORTING UNITS SHALL BE FACTORY ASSEMBLED AND CAPABLE OF HOLDING THE DOWELS IN THEIR REQUIRED POSITIONS. IN THE COMPLETED JOINT INSTALLATION, DOWELS SHALL BE POSITIONED WITHIN 1/2" OF THE VERTICAL AND HORIZONTAL PLANE AND IN THE LONGITUDINAL DIRECTION. THE SKEW TOLERANCE SHALL BE 1/4".

THE FREE END OF EACH EPOXY COATED DOWEL SHALL BE MARKED WITH A SPOT OF PAINT AT LEAST ONE INCH IN DIAMETER AND CONTRASTING IN COLOR WITH THE EPOXY COATING.

WIRE SIZES SHOWN ARE MINIMUM REQUIRED.

WIRES, BARS OR CLIPS SHALL BE USED AS NECESSARY TO STRENGTHEN THE ASSEMBLIES.

THE DIAMETER OF THE SPACER WIRE SHALL NOT EXCEED 0.200".

SPACER WIRE MAY BE CUT OR LEFT INTACT.

STAKING PINS SHALL BE FABRICATED FROM 0.306" DIAMETER WIRE MINIMUM WITH A SUITABLE HOOK. STAKING PINS SHALL HAVE A MINIMUM LENGTH OF 12" FOR DOWEL ASSEMBLIES UNLESS OTHERWISE DIRECTED BY THE ENGINEER.

MINOR VARIATIONS IN THE CONFIGURATION OF THE SUPPORT UNITS WILL BE ALLOWED.

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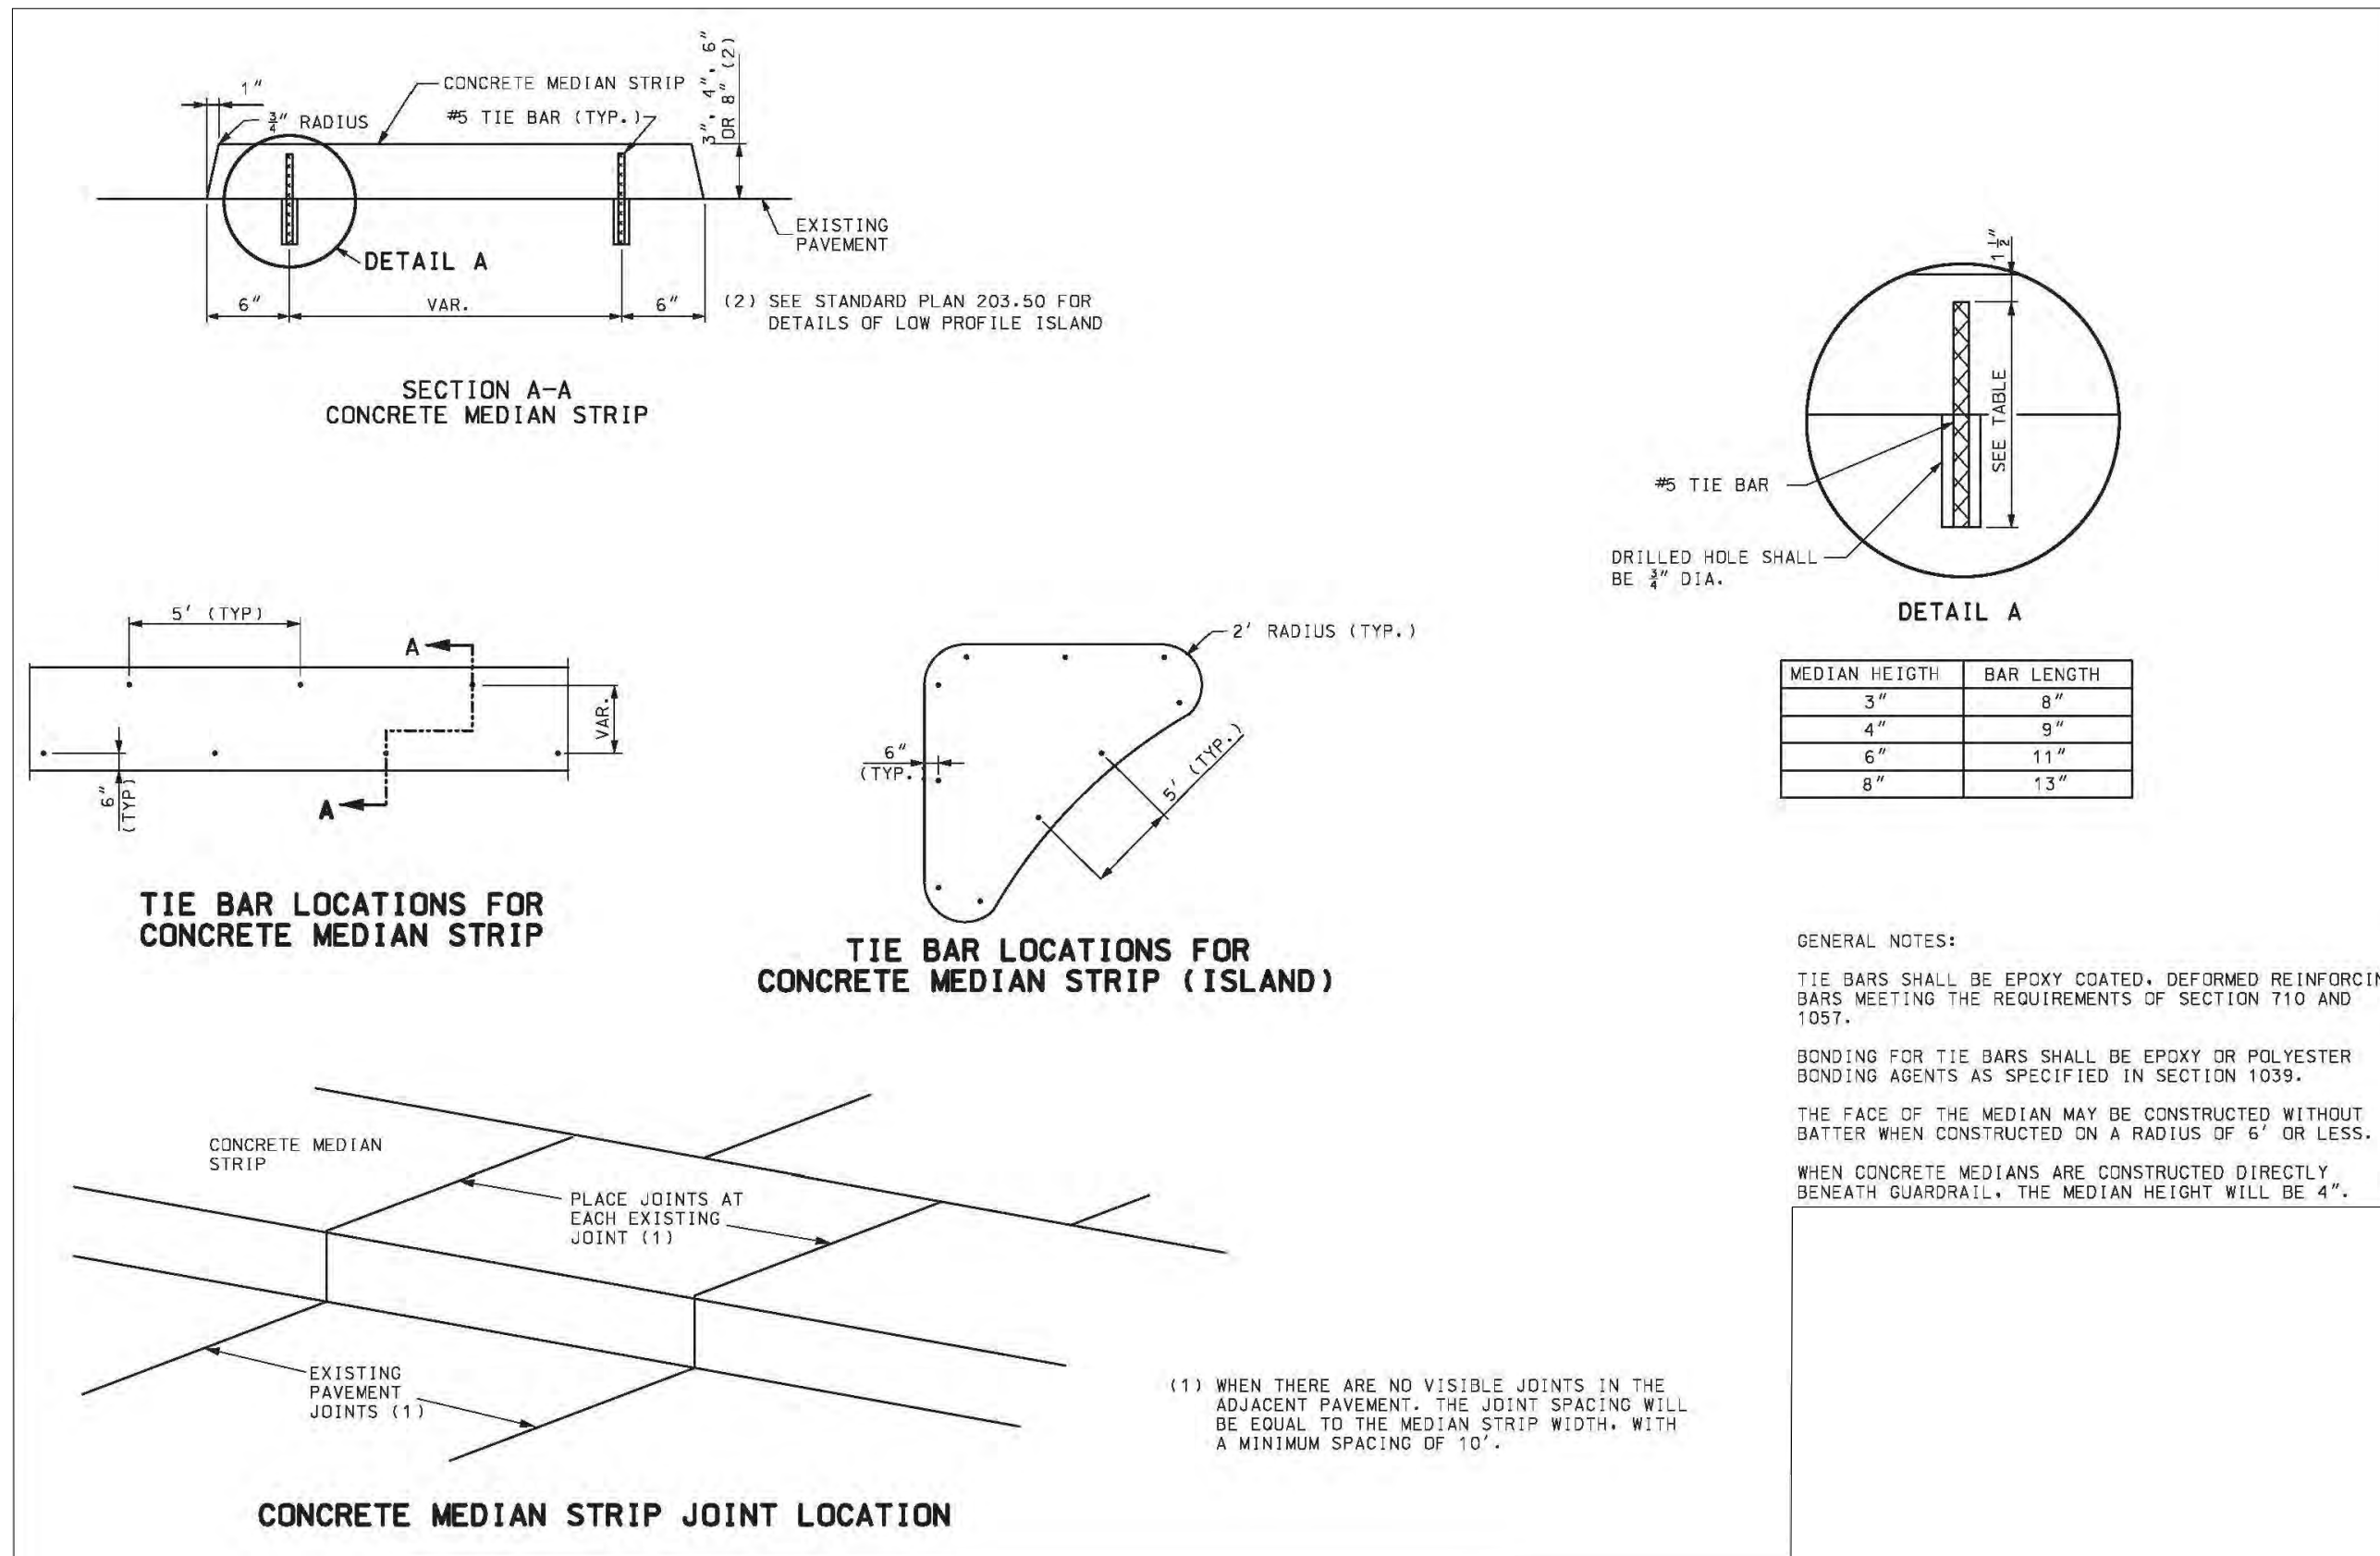
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MODOT 608.30A CONCRETE MEDIAN

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